OPPORTUNITY FOUNDATION, INC. GROUP HOMES REMODEL

526 RECLAMATION DRIVE & 7018th STREET EAST WILLISTON, NORTH DAKOTA 58801

F. EAPC

TELE **701.572-6759**

313 Main Street Suite 200 Williston, ND 58801

Fort Collins CO

Grand Forks ND Minot ND Buenos Aires ARG Sioux Falls SD

— www.eapc.net

GENERAL

COVER SHEET CODE PLAN

TECTURAL

GENERAL ARCHITECTURAL INFORMATION

FIRST AND MEZZANINE FLOOR PLAN

REFLECTED CEILING PLAN **BUILDING ELEVATIONS**

BUILDING SECTIONS BUILDING SECTIONS

WALL SECTIONS

ENLARGED FLOOR PLANS / INTERIOR ELEVATIONS

ENLARGED FLOOR PLANS / INTERIOR ELEVATIONS

DETAILS

PLUMBING & MECHANICAL

MECHANICAL SYMBOLS & LEGEND SHEET

UNDERGROUND, FIRST FLOOR AND MEZZANINE PLUMBING PLANS

MECHANICAL

MECHANICAL SITE PLANS


ELECTRICAL

ELECTRICAL SYMBOLS & ABBREVIATIONS LEGEND

ELECTRICAL SITE PLAN

- 701 8th STREET FAST - 526 RECLAMATION DRIVE

SITE LOCATION

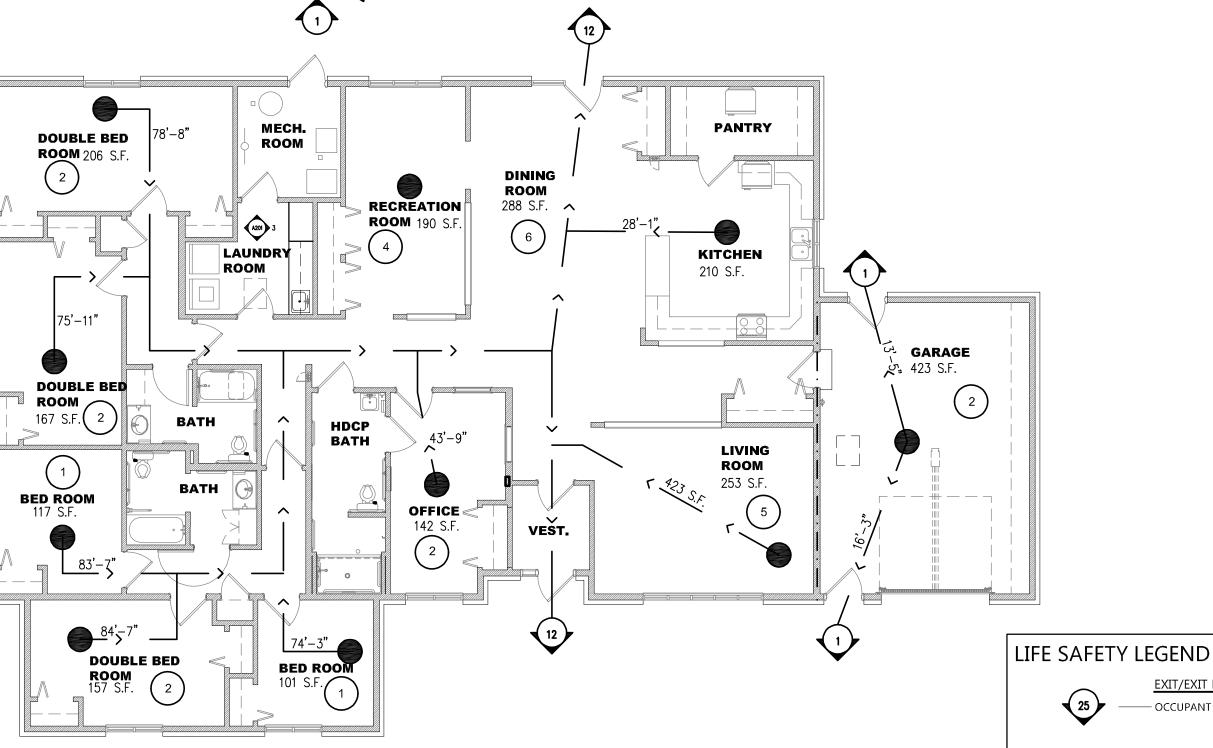

DESCRIPTION 8 BUILDING IS EXISTING WOOD FRAMED GROUP HOME ON CRAWL SPACE YES OCCUPANCY CHANGE NO INFORMATION NEW BUILDING NO ATTIC SPACE NO EXIST. SPRINKLED YES BASEMENT YES EXIST. FIRE RATINGS YES CRAWL SPACE 2021 INTERNATIONAL BUILDING CODE (IBC) W/ AMENDMENTS 2021 EXISTING BUILDING CODE OF ND WITH AMENDMENTS 2021 INTERNATIONAL MECHANICAL CODE 2018 UNIFORM PLUMBING CODE 2021 NATIONAL ELECTRICAL CODE W/ AMENDMENTS 2021 INTERNATIONAL ENERGY CONSERVATION CODE **BUILDING OCCUPANCY EXISTING CLASSIFICATION:** I-1 GROUP (SEC. 308.2) SPECIAL REQUIREMENTS FIRE ALARM & SMOKE ALARMS REQUIRED (420.6) FIRE RESISTANT CORRIDORS REQUIRED (420.7) **BUILDING ALLOWABLES** (TABLE 504.3) ALLOWABLE NUMBER OF STORIES: (TABLE 504.4) ALLOWABLE BUILDING AREA: I-1: 10,000 SF (3,757.5 SF ACTUAL) (TABLE 506.2) ALLOWABLE FRONTAGE INCREASE: 30 FEET OR GREATER: .25 **BUILDING AREA** EXISTING PERIMETER: 287'-0" **EXISTING NUMBER OF STORIES: 1 STORY** EXISTING FRONTAGE: (SEC. 506.2) I-1: ACTUAL 3,757.5 SF IS LESS THAN 10,000 SF (SEC. 506.2.2) A_a = Allowable area (square feet). A₁ = Tabular allowable area factor. NS = Tabular allowable area factor I_f = Area factor increase due to frontage (percent). $A_a = [(10,000 + (10,000 \times .25))]$ $A_a = 15,000$ ALLOWABLE AREA $A_a = ACTUAL 3,757.5 SF IS LESS THAN 15,000 SF$ FIRE SEPARATION BETWEEN | REQUJIRED SEPARATION OF OCCUPANCIES: (TABLE 508.4) GROUP I-1 / GARAGE: **INCIDENTAL USES** (TABLE 509) AUTOMATIC SPRINKLER SYSTEM-REQUIRED -FURNACE ROOM -BOILER ROOM CONSTRUCTION TYPE (SEC. 602.2) (TABLE 601) FIRE-RESISTANCE RATING FOR BUILDING ELEMENTS OCATIONS) YPE IIB REQUIRED FIRE RATINGS: = 0 HOUR STRUCTURAL FRAME: = 0 HOUR BEARING WALLS: NON-BEARING WALLS: = 0 HOUR FLOOR CONSTRUCTION: = 0 HOUR ROOF CONSTRUCTION & HEIGHT = 0 HOUR = 0 HOUR FIRE BARRIERS: = 0 HOUR SHAFT ENCLOSURES = 0 HOUR = 0 HOUR FIRE PARTITIONS: = 0 HOUR SMOKE BARRIERS: SMOKE PARTITIONS = 0 HOUR. FIRE PROTECTION GROUP I-1 AN AUTOMATIC SPRINKLER SYSTEM IS REQUIRED THROUGHOUT. (SEC. 903.2..6) BUILDING IS FULLY SPRINKLED WITH NFPA TYPE 13 (SEC. 903.3.1.1) FIRE EXTINGUISHERS FOR CLASS A FIRE HAZARDS (SEC. 906.1) MINIMUM RATED SINGLE EXTINGUISHER: 2-A 10-B:C. (TABLE 906.1) MAXIMUM FLOOR AREA PER UNIT: 11,250 S.F. (TABLE 906.3)(1) MAXIMUM DISTANCE OF TRAVEL TO EXTINGUISHER: 75'-0" GROUP A-2 A FIRE ALARM SYSTEM IS REQUIRED THROUGHOUT. (SEC. 907.2.6) REFER TO LIFE SAFETY PLANS FOR COMPLIANCE **EGRESS CRITERIA** OCCUPANT LOAD BEDROOMS SINGLE VARIES S.F. 120 GROSS 2 OCCUPANTS DOUBLE 6 OCCUPANTS VARIES S.F. 120 GROSS 142 S.F. 110 GROSS 1 OCCUPANT RECREATION ROOM 190 S.F. 50 NET 4 OCCUPANTS LIVING ROOM 253 S.F. 5 OCCUPANTS DINING ROOM 288 S.F. 6 OCCUPANTS GARAGE 2 OCCUPANTS 423 S.F. 26 OCCUPANTS TOTALS: EGRESS WIDTH PER OCCUPANT (0.2" PER OCCUPANT) (SEC.1005.3.2) 0.2" x 26 = 5.2" MINIMUM PER OCCUPANT 60" ACTUAL TABLE 1006.2.1 COMMON PATH OF EGRESS TRAVEL = 75 FT. COMPLIES MAXIMUM DISTANCE OF TRAVEL = 250 FT. COMPLIES, (WITH SPRINKLER SYSTEM) (TABLE 1017.2) MINIMUM CORRIDOR WIDTH = 44 INCHES (TABLE 1017.3) MAXIMUM DEAD END CORRIDOR DISTANCE = 20 FT. COMPLIES (TABLE 2902.1) **EGRESS CRITERIA** THE FACILITY IS ACCESSIBLE AND FULLY COMPLIES WITH ICC A117.1-2017 PLUMBING FACILITIES (TABLE 2902.1) 701 GROUP HOME 26 OCCUPANTS 1 PER 10 1 PER 10 526 GROUP HOME 26 OCCUPANTS 1 PER 10 1 PER 10 1 PER 8 ENERGY CODE SHALL NOT BE USED TO REQUIRE THE REMOVAL, ALTERATION, OR ABANDONMENT OF,

CODE ANALYSIS

701 8TH STREET EAST & 526 RECLAMATION DRIVE, WILLISTON, NORTH DAKOTA 58801

OPPORTUNITY FOUNDATION GROUP HOMES

OPPORTUNITY FOUNDATION, INC.

PROJECT

OWNER

ADDRESS

THIS DOCUMENT WAS ORIGINALLY ISSUED AND SEALED BY BURTON E. YOUNGS REGISTRATION NUMBER 1132 ON 12/03/2024 AND the original documents are stored at

OPPORTUNITY FOUNDATION, INC.

PROJECT DESCRIPTION

GROUP HOMES LAUNDRY ROOM

WILLISTON

NORTH DAKOTA

ISSUE DATES ARCHITECTURAL STAMP

was prepared by me or under my direct supervision, and that I am a duly Registered Architect under the laws of the State of North Dakota.

hereby certify that this plan, specification, or report

CD CONSTRUCTION DOCUMENTS

DATE

20246090 PROJECT NO: DRAWN BY: ### CHECKED BY:

MARK DESCRIPTION

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DRAWING TITLE

COVER/CODE SHEET

G001

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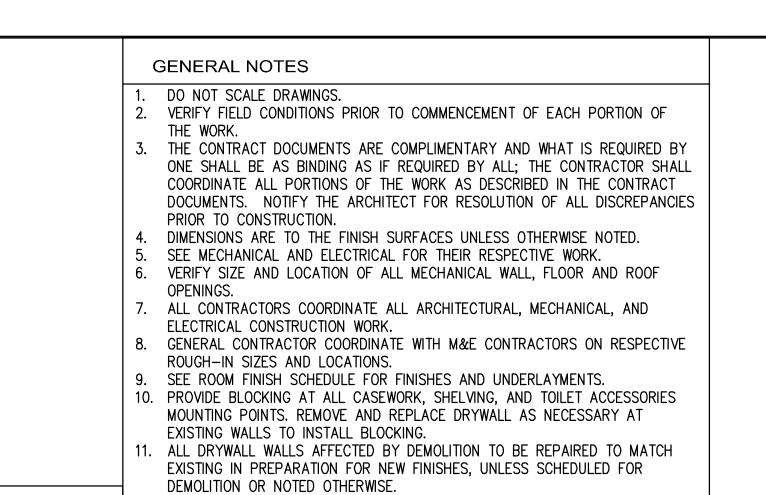
DISTANCE TO EXIT OCCUPANT LOAD IN A GIVEN ROOM OR AREA

ONE HOUR FIRE RATED WALL FIRE EXTINGUISHER CABINET FIRE EXTINGUISHER

COMMON PATH TRAVEL DISTANCE

- OCCUPANT CAPACITY

NOR PREVENT THE CONTINUED USE AND MAINTENANCE OF, AN EXISTING BUILDING OR BULDING SYSTEM LAWFULLY IN EXISTENCE.



NOTES:

1. EXIST. ELECTRICAL OUTLET TO REMAIN.

2. NEW SINK & FAUCET. REUSE EXIST. PAPER TOWEL DISPENSER. 4. REUSE EXIST. SOAP DISPENSER.

▲ A201

LAUNDRY

ENLARGED LAUNDRY PLAN

ROOM

EXIST. WASHER —


EXIST. DRYER -


EXIST. CRAWL SPACE ACCESS ·


ALL DOOR CABINETS HAVE LOCKS. HANDICAP SINK CABINET. NO LOCKS ON LAUNDRY ROOM CABINETS FOR 526 RECLAMATION DRIVE GROUP HOME.

DEMOLITION NOTES:

- 1 REMOVE CABINETS. COORD. SINK REMOVAL (BY M.C.) W/ M.C. (2) REMOVE FLOORING & BASE. PREP FLOOR FOR NEW FLOORING.
 (3) EXISTING DOOR TO REMAIN.
- 4 REMOVE MIRROR-TURN OVER TO OWNER.

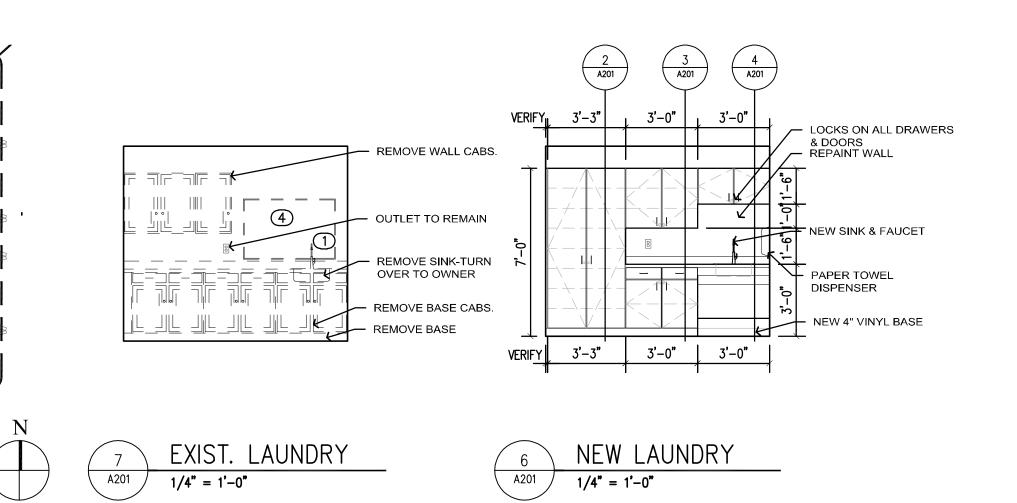

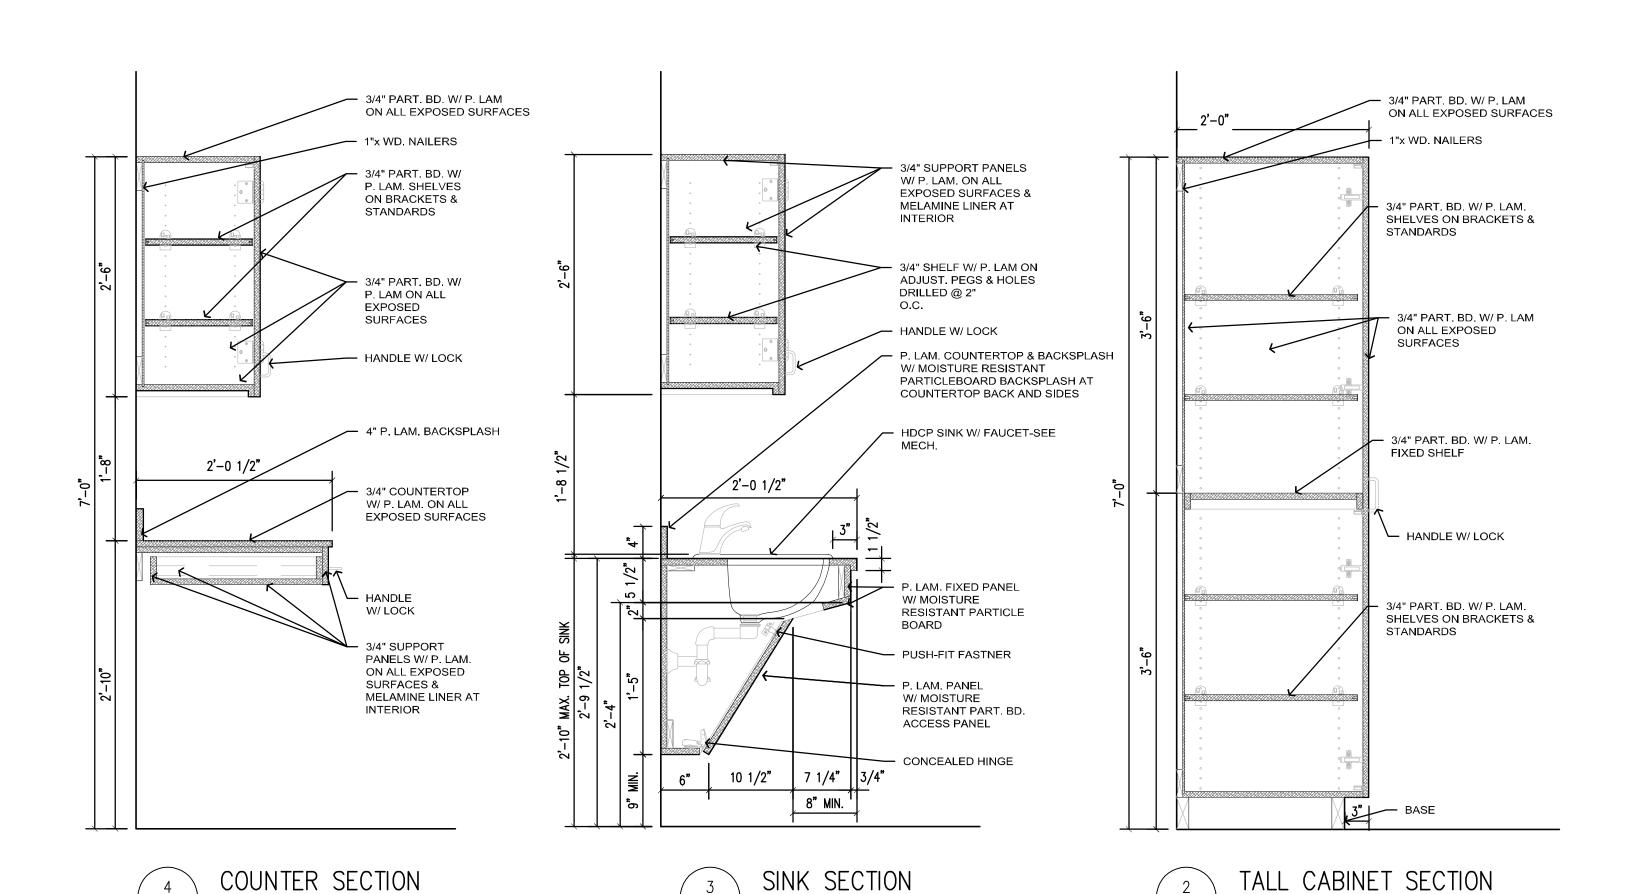

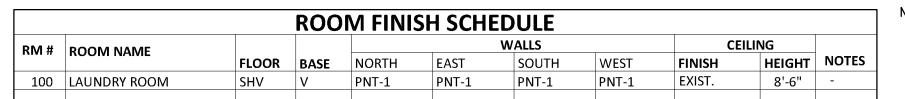

OVERALL GENERAL DEMOLITION NOTE: THE OWNER HAS FIRST REFUSAL BEFORE ITEMS ARE DISPOSED OF.

MECH.

ROOM

LAUNDRY

ROOM₂

BATH

#526 FLOOR PLAN

DOUBLE BED

ROOM

DOUBLE BED

DOUBLE BED

ROOM

BED ROOM

ROOM

_ A--

RECREATION

- EXIST. OUTLET TO REMAIN

ROOM

HDCP

BATH

BED ROOM

DINING **ROOM**

COMPLETELY REMOVE EXIST. WALL & BASE CABINETS, SINK. REMOVE MIRROR & TURN OVER TO OWNER.

VEST.

. FLOOR HEAT, ALTERNATE #3 2. TS1 - TRANSITION SHV/CONC. 3. TS2 - TRANSITION CPTT/CONC. 4. TS3 - TRANSITION MAT/CPTT 5. PAINT PRECAST WALLS, ALTERNATE #4

PANTRY

KITCHEN

LIVING

ROOM

6. PAINT EXPOSED STRUCTURE & CEILING, ALTERNATE <u>LEGEND</u> ACT = ACOUSTICAL CEILING TILE

CONC = SEALED CONCRETE EXP = EXPOSED CEILING PAINTED PNT = PAINT

CPTT = CARPET TILE V = VINYL BASESHV = SHEET VINYL

GARAGE

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CLIENT

OPPORTUNITY FOUNDATION, INC.

PROJECT DESCRIPTION

GROUP HOMES LAUNDRY ROOM REMODEL

WILLISTON CITY NORTH DAKOTA

ISSUE DATES

STATE

ARCHITECTURAL STAMP

I hereby certify that this plan, specification, or report was prepared by me or under my direct supervision, and that I am a duly Registered Architect under the laws of the State of North Dakota.

CD | CONSTRUCTION DOCUMENTS | 12/03/2024 MARK DESCRIPTION DATE


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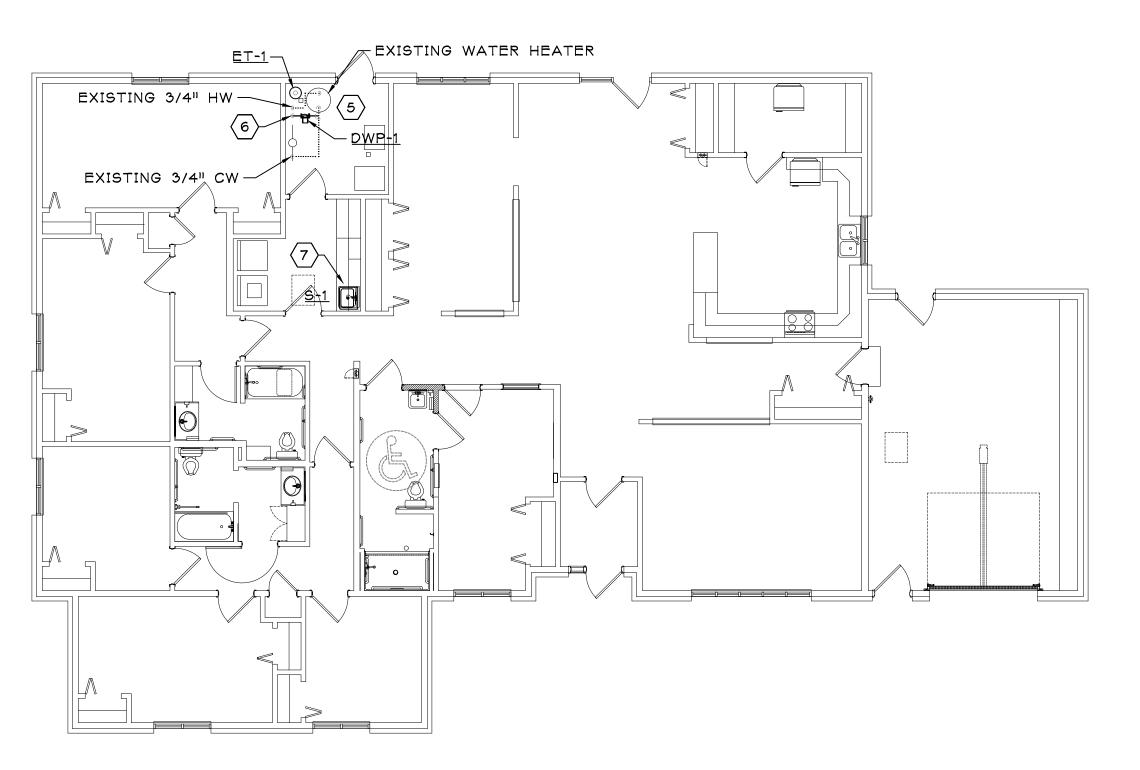
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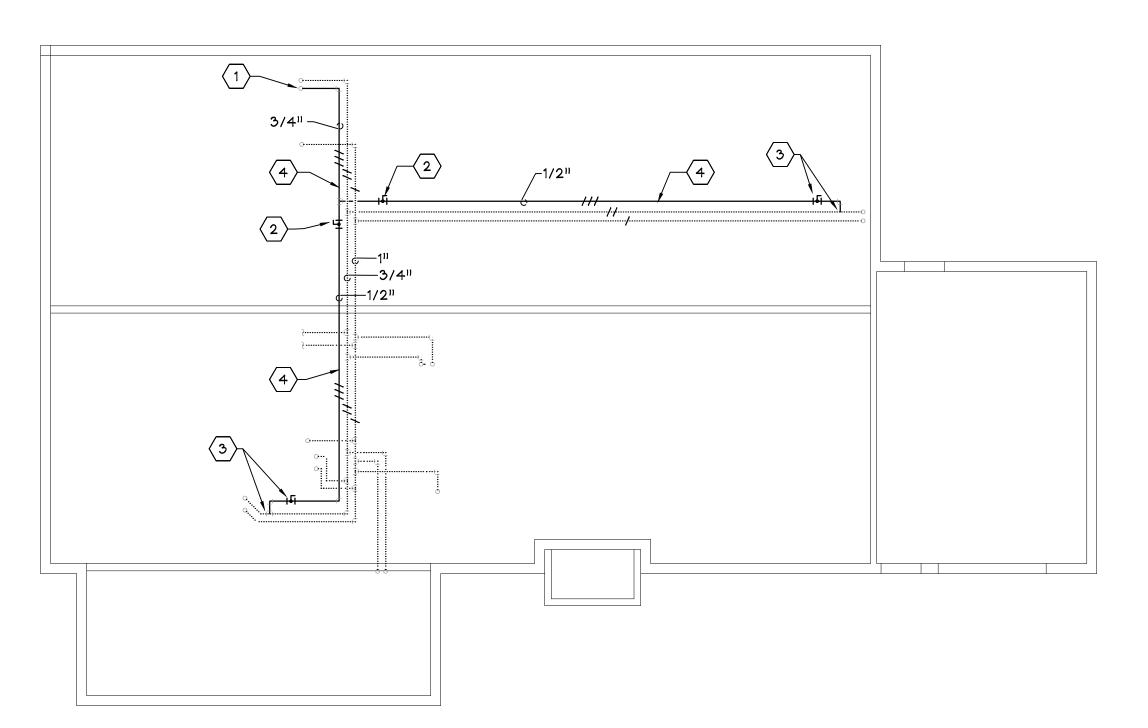
DRAWING TITLE

FLOOR PLANS, **ELEVATIONS**, **DETAILS**







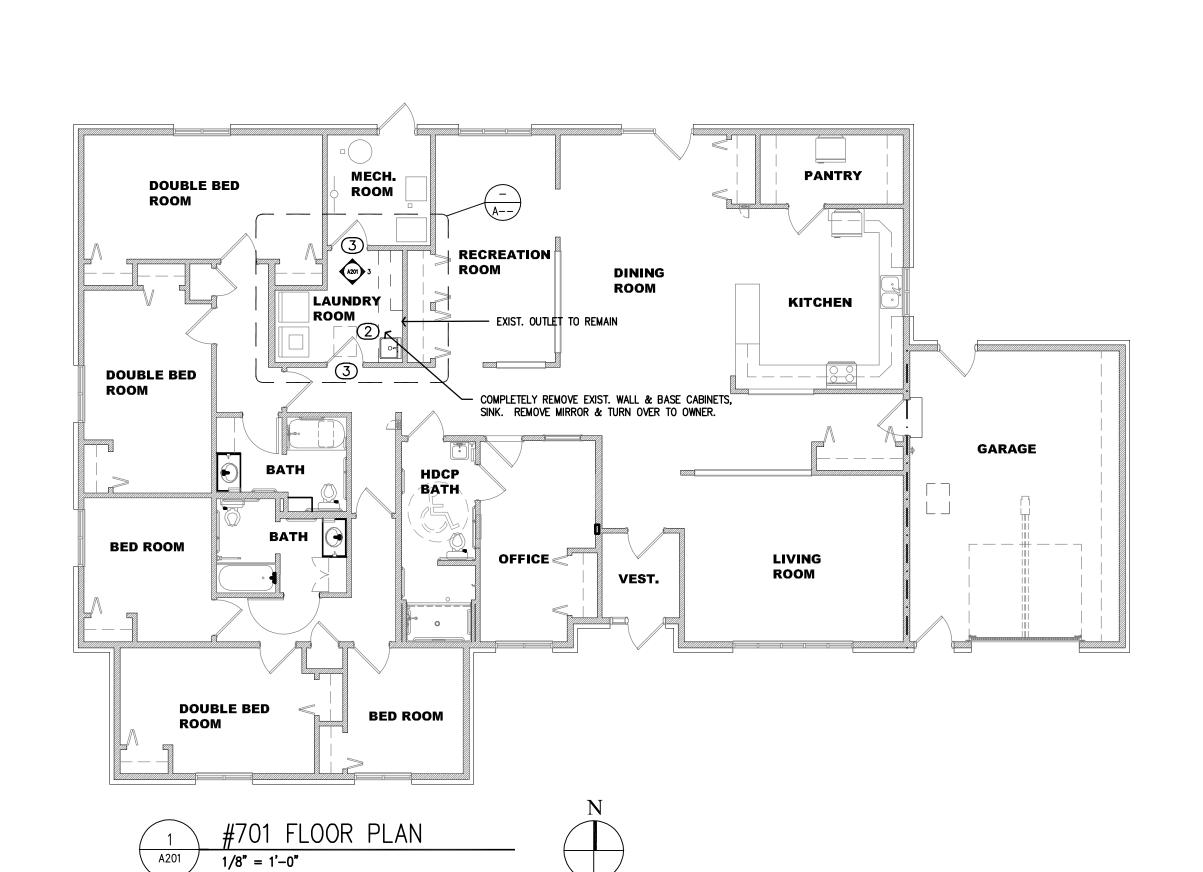

2	CRAWL SPACE	E PLUMBING PLAN	
M101	1/8" = 1'-0"		
		NC	ORT

EXPANSION TANK SCHEDULE									
MARK	MFR	MODEL	AIR	PRESSU	IRE (PSI)	VC	FLUID		
			SEPARATOR	FILL	FINAL	ACCEPT.	TANK	EST. SYS.	FLOID
ET-1	AMTROL	ST-5	DIAPHRAM	0	150	N/A	2	N/A	WATER

2) INCLUDE TIMER, AQUA-STAT, AND MINIMUM 5' CORD AND PLUG.

CHECK VALVE

EXISTING

HEATER

WATER

WATER HEATER DETAIL

PUMP SCHEDULES

MARK MFR MODEL TYPE FUNCTION FLOW HEAD RPM HP ELECTRICAL NOTES

 DWP-1
 TACO
 003-PNP
 WET ROTOR
 HW RECIRC
 3
 3
 3650
 0.13
 120/1/60
 1, 2

-AQUASTAT

CONNECT TO EXISTING COLD WATER

VALVE_

SINGLE SPEED MOTOR.

PLUMBING FIXTURE SCHEDULE													
MARK	FIXTURE		ADA	FAUCET/VALVE		CONNECTIONS							
IVIANK	TYPE	MFR	MODEL	ADA	MFR	MODEL	OPTION	CW	HW	TEMP.	WASTE	VENT	DESCRIPTION
S-1	LAVATORY	KOHLER	K-2196	YES	KOHLER	K-15198	SINGLE HANDLE	1/2"	1/2"		1-1/2"	1-1/4"	Counter mounted, self-rimming, vitreous china, oval, single handle faucet, 1.5 gpm

GENERAL NOTES

- 1. PERFORM WORK IN ACCORDANCE WITH THE LATEST EDITIONS, REVISIONS, AMENDMENTS OR SUPPLEMENTS OF APPLICABLE STATUES, ORDINANCES, CODES OR REGULATIONS OF FEDERAL, STATE, AND LOCAL AUTHORITIES HAVING JURISDICTION IN EFFECT ON THE DATE THE DRAWING PACKAGE IS ISSUED.
- 2. ARRANGE WITH AUTHORITIES AND UTILITY COMPANIES FOR PERMITS, FEES AND SERVICE CONNECTIONS. VERIFY LOCATIONS AND ARRANGEMENTS AND PAY ALL CHARGES, INCLUDING INSPECTIONS.
- 3. INSTALL PIPING AND DUCTWORK TO PROVIDE THE MAXIMUM CLEAR HEIGHT UNDERNEATH UNLESS OTHERWISE NOTED.
- 4. THE ENTIRE SYSTEM AND ITS COMPONENT ITEMS SHALL OPERATE WITHOUT OBJECTIONABLE NOISE AND VIBRATION.
- 5. PIPE ROUTING IS SHOWN WITH AN EXAGGERATED SPACING FOR CLARITY. ACTUAL PLACEMENT OF PIPING SHOULD BE DONE COLLECTIVELY AND IN SUCH A MANNER AS NOT TO CONFLICT WITH LOCATION SENSITIVE COMPONENTS SUCH AS LIGHT FIXTURES.
- 6. PROVIDE FIRE-STOP AROUND PIPE AND/OR DUCT PENETRATIONS THROUGH FIRE RATED FLOORS AND WALLS.
- 7. COORDINATE ALL SLAB PENETRATIONS
 AND SLEEVES PRIOR TO EACH CONCRETE
 POUR. PROVIDE SLEEVES AND INSERTS AS
 REQUIRED FOR PLACEMENT IN STRUCTURAL
 OR ARCHITECTURAL WORK.

LINE	E TYPE LEGEND
TO REMAIN	
NEW	
TO REMOVE	
-	

PIPE LEGEND					
ABOVE GROUND WASTE					
ABOVE GROUND VENT					
DOMESTIC COLD WATER	\				
DOMESTIC HOT WATER	\\\\\\\\\\\\\\\\\\\\\\\\\\\\\\\\\\\\\\				
RECIRC. HOT WATER	\\\\				
TEMPERED WATER	\\\\				
RECIRC. TEMPERED WATER	\\\\\				
BALL VALVE					
STRAINER	<u> </u>				
CHECK VALVE	N				
UNION	<u>├</u> ──── ├───				
BALL VALVE INDICATOR					

KEYNOTES

- 1) 3/4" RECIRCULATING HOT WATER UP THROUGH FLOOR TO WATER HEATER IN THE MECHANICAL ROOM.
- 2 RECIRCULATING HOT WATER WITH BALL VALVE FOR BALANCING.
- CONNECT NEW RECIRCULATING HOT WATER PIPE TO EXISTING HOT WATER WHERE SHOWN. PROVIDE ISOLATION BALL VALVE.
- PROVIDE NEW RECIRCULATING HOT WATER PIPING AS SHOWN.
- 5 PROVIDE OUTLET IN WATER HEATER ROOM NEAR DWP-1. POWER FROM NEAREST WATER HEATER ROOM CIRCUIT
- PROVIDE 3/4 RECIRCULATING HOT
 WATER FROM BELOW AND CONNECT TO
 EXISTING COLD WATER PIPING. SEE
 DETAL 3/M101.
- REMOVE EXISTING SINK FOR CABINET REPLACEMEN AND REPLACE WITH NEW SINK. REPLACE EXISTING STOPS AS



Architecture Engineering Industria


Wind Energy Interior Posign Construction

TELE **701.572-6759**

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CLIENT

OPPORTUNITY FOUNDATION, INC.

PROJECT DESCRIPTION

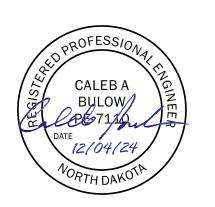GROUP HOMES LAUNDRY ROOM REMODEL

WILLISTON

STATE NORTH DAKOTA

ISSUE DATES

01 CONSTRUCTION DOCUMENTS 12/04/24

MARK DESCRIPTION DATE

PROJECT NO:	20246090
DRAWN BY:	ВНС
CHECKED BY:	CAE
CODVIDENT	

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PLUMBING PLANS



M101