GENERAL NOTES

- WITH REMODEL. MAKE ALLOWANCES IN BID THERETO.
- DEVICES WITH SLASH THROUGH INDICATE SPECIFIC EXISTING DEVICES TO BE REMOVED. REMOVE OR RELOCATE ANY ELECTRICAL DEVICE AS REQUIRED BY REMODEL OPERATIONS. EXTEND EXISTING CIRCUITRY AS REQUIRED TO MAINTAIN DOWNSTREAM DEVICES OR FIXTURES. DISCONNECT AND REMOVE ANY EXISTING CIRCUITRY NOT BEING REUSED. RE-IDENTIFY EXISTING PANEL DIRECTORIES AS REQUIRED.

RAMSEY COUNTY COURTHOUSE ELECTRICAL SYSTEM UPGRADE DEVILS LAKE, NORTH DAKOTA

DRAWING INDEX

TITLE SHEET

BASEMENT LEVEL PLANS

1ST & 2ND FLOOR PLANS

3RD FLOOR & PENTHOUSE PLANS

EXISTING RISER

UPGRADED RISER

FIELD VERIFY ALL PERTINENT EXISTING CONDITIONS AND INSTALLATION REQUIREMENTS IN CONNECTION

3. SEE SPECIFICATION 260510 FOR REMODEL.

STANDARD ELECTRICAL SYMBOLS BASED ON ANSI Y32.9-1972, ANSI A117.1-1986, AND FEDERAL REGISTER 56-144(ADA) MOUNTING HEIGHT MEASUREMENTS SHALL BE MADE FROM FINISH

CLOCK RECEPTACLE

ACCEPTABLE IF INTERNAL THERMAL PROTECTION

SINGLE POLE DOUBLE POLE THREE-WAY FOUR-WAY KEY OPERATED

TIME DELAY

BUZZER

 $\overline{}$

FLOOR TO CENTER LINE OF OUTLET DESCRIPTION <u>LIGHTING OUTLETS</u> CEILING LUMINAIRE. TYPE A, CKT 1, SW b. WALL MOUNT LUMINAIRE. SCHEDULED TROFFER TYPE LUMINAIRE, SLASH INDICATES UNSWITCHED. STRIP TYPE LUMINAIRE. EMERGENCY BATTERY UNIT REMOTE SEALED BEAM SCHEDULED PORCELAIN LAMPHOLDER. 100A LAMP JUNCTION BOX SINGLE. CKT 1 DUPLEX DOUBLE DUPLEX DUPLEX - SPLIT WIRED DUPLEX - GROUND FAULT CIRCUIT INTERRUPTER DOUBLE DUPLEX - GROUND FAULT CIRCUIT INTERRUPTER

JASON E. HUNZE

SPECIAL CONFIGURATION. DESIGNATION REFERS TO SCHEDULE | SCHEDULED MULTI-OUTLET ASSEMBLY. ARROWS EXTEND TO LIMIT OF INSTALLATION. SUBSCRIPT INDICATES SPACING OF OUTLETS DUPLEX RECEPTACLE - FLOOR BOX MOTOR - PROVIDE OVERLOAD UNIT AS REQ'D. TOGGLE

INCLUDED. SWITCH NOT REQUIRED IF MOTOR ASSEMBLY HAS INTEGRAL DISCONNECTING MEANS. PILOT HANDLE DIMMER - 1000W UNLESS OTHERWISE INDICATED GANGED SWITCHES - ARROW INDICATES MULTI-LEVEL CEILING MOUNTED OCCUPANCY SENSOR WALL MOUNTED OCCUPANCY SENSOR - ARROW INDICATES MULTI-LEVEL SWITCHING, d - 0-10V DIMMING COMMUNICATION/DATA SYSTEM OUTLETS TELEPHONE OUTLET. TELEPHONE OUTLET OR COMPUTER/VDT - FLOOR BOX COMPUTER/VDT OUTLET VOICE/DATA ROUGH-IN Prairie Engineering Professional Consulting F INTERCOM STATION MICROPHONE OUTLET

TELEVISION OUTLET VOLUME CONTROL PUSH BUTTON SPEAKER/BAFFLE/BACKBOX COMBINATION CLOCK PLAN OR DETAIL NOTE SPECIAL PURPOSE CONNECTION - AS REQUIRED BY EQUIPMENT MANUFACTURER. CO-ORDINATE ROUGH-IN WITH SHOP DWG. BRANCH CIRCUIT PANELBOARD, SHADING INDICATES NEW PANEL CONTROL PANEL EXTERNALLY OPERATED DISCONNECT SWITCH

CONTROLLER OR RELAY COMBINATION CONTROLLER AND DISCONNECTION MEANS MOTOR. DESIGNATION REFERS TO SCHEDULE.

2 EQUIPMENT DESIGNATION. SEE SCHEDULE. BB-1 ELECTRIC HEAT TO SCALE. DESIGNATION REFER TO SCHEDULE THE INDICATES INTEGRAL THERMOSTAT. THERMOSTAT-PROVIDED BY DIV. 26 THERMOSTAT-FURNISHED BY DIV. 23, INSTALLED BY DIV. 26 46" HUMIDISTAT-FURNISHED BY DIV. 23, INSTALLED BY DIV. 26 POTENTIOMETER-FURNISHED BY DIV. 23, INSTALLED BY DIV. 26 46" TIME SWITCH PHOTOELECTRIC SWITCH CIRCUITING

HOME RUN. MIN 3/4" C. ARROWS AND SUBSCRIPTS INDICATE NUMBER AND IDENTIFICATION OF CIRCUITS. EMERGENCY. MIN 1/2" C-#10 AWG. TELEPHONE. MIN 3/4"C, HOME RUN TO TERMINAL BOARD TELEPHONE. MIN 3/4"C, STUB INTO CEILING SPACE LOW VOLTAGE. MIN 1/2"C-#14 AWG AS REQ'D. SPECIAL SYSTEMS. MIN 3/4"C. PROVIDE CONDUCTORS AS REQUIRED BY MANUFACTURER. SUBSCRIPT INDICATES SYSTEM. SEE STANDARD ABBREVIATIONS. 0-10 VOLT CLASS 2 DIMMING CONDUCTORS FIRE ALARM SYSTEMS DETECTOR. SUPERSCRIPT INDICATES ZONE. SUBSCRIPT

> ELECTRIC, C-COMB. CARBON MONOXIDE & PHOTOELECTRIC, MAGNETIC DOOR HOLDER FAN RELAY FLOW SWITCH MANUAL STATION AUDIBLE NOTIFICATION APPLIANCE VISUAL NOTIFICATION APPLIANCE AUDIBLE-VISUAL NOTIFICATION APPLIANCE MAIN VALVE SUPERVISORY ("TAMPER") SWITCH FIRE ALARM CONTROL PANEL STANDARD ABBREVIATIONS

> > WP WEATHERPROOF

WT WATER TIGHT

WM WIREMOLD

AC ABOVE COUNTER (MIN 4" ABOVE BACKSPLASH) MCB MAIN CIRCUIT BREAKER MLO MAIN LUG ONLY AFF ABOVE FINISH FLOOR AFG ABOVE FINISH GRADE NC NURSES CALL AHU AIR HANDLING UNIT NR NOT REQUIRED
P PAGING/BACKGROUND MUSIC ATC AUTOMATIC TEMPERATURE CONTROL BOF BOTTOM OF FIXTURE PUBLIC ADDRESS CP CONTROL PANEL PRV POWER ROOF VENTILATOR CU CONDENSING UNIT
CUH CABINET UNIT HEATER RF RELIEF FAN RGSC RIGID GALVANIZED STEEL CONDUIT RT RAIN-TIGHT DT DUST TIGHT DTR DATA TERMINATION RACK RTU ROOFTOP UNIT EC ELECTRICAL CONTRACTOR SECURITY SD SEE DETAIL EF EXHAUST FAN EM EMERGENCY SURGE SUPPRESSION EP EXPLOSION PROOF TOP OF PANEL
T TELEPHONE
TSSW TWO SPEED SEPARATE WINDING EWC ELECTRIC WATER COOLER EWH ELECTRIC WATER HEATER FUSED FLA FULL LOAD AMPERES TTB TELEPHONE TERMINAL BOARD FA FIRE ALARM VT VAPOR TIGHT FACP FIRE ALARM CONTROL PANEL W WALL MTG. (46" AFF FORWARD REACH)

FVNR FULL VOLTAGE NON REVERSING FVR FULL VOLTAGE REVERSING IC INTERCOM IL INTERLOCK LV LOW VOLTAGE MC MECHANICAL CONTRACTOR MCA MINIMUM CIRCUIT AMPACITY

FARA FIRE ALARM REMOTE ANNUNCIATOR

FDS FUSIBLE DISCONNECT SWITCH


SPECIAL ABBREVIATIONS PECULIAR TO THIS PROJECT ATS AUTOMATIC TRANSFER SWITCH MTS MANUAL TRANSFER SWITCH

E0.1 of **6**

CEILING DESCRIBES INITIATION: D-DUCT, R-RATE OF RISE THERMAL,

EL

RAMSEY COUNTY COURTHOUSE ELECTRICAL SYSTEM UPGRADE DEVILS LAKE, NORTH DAKOTA

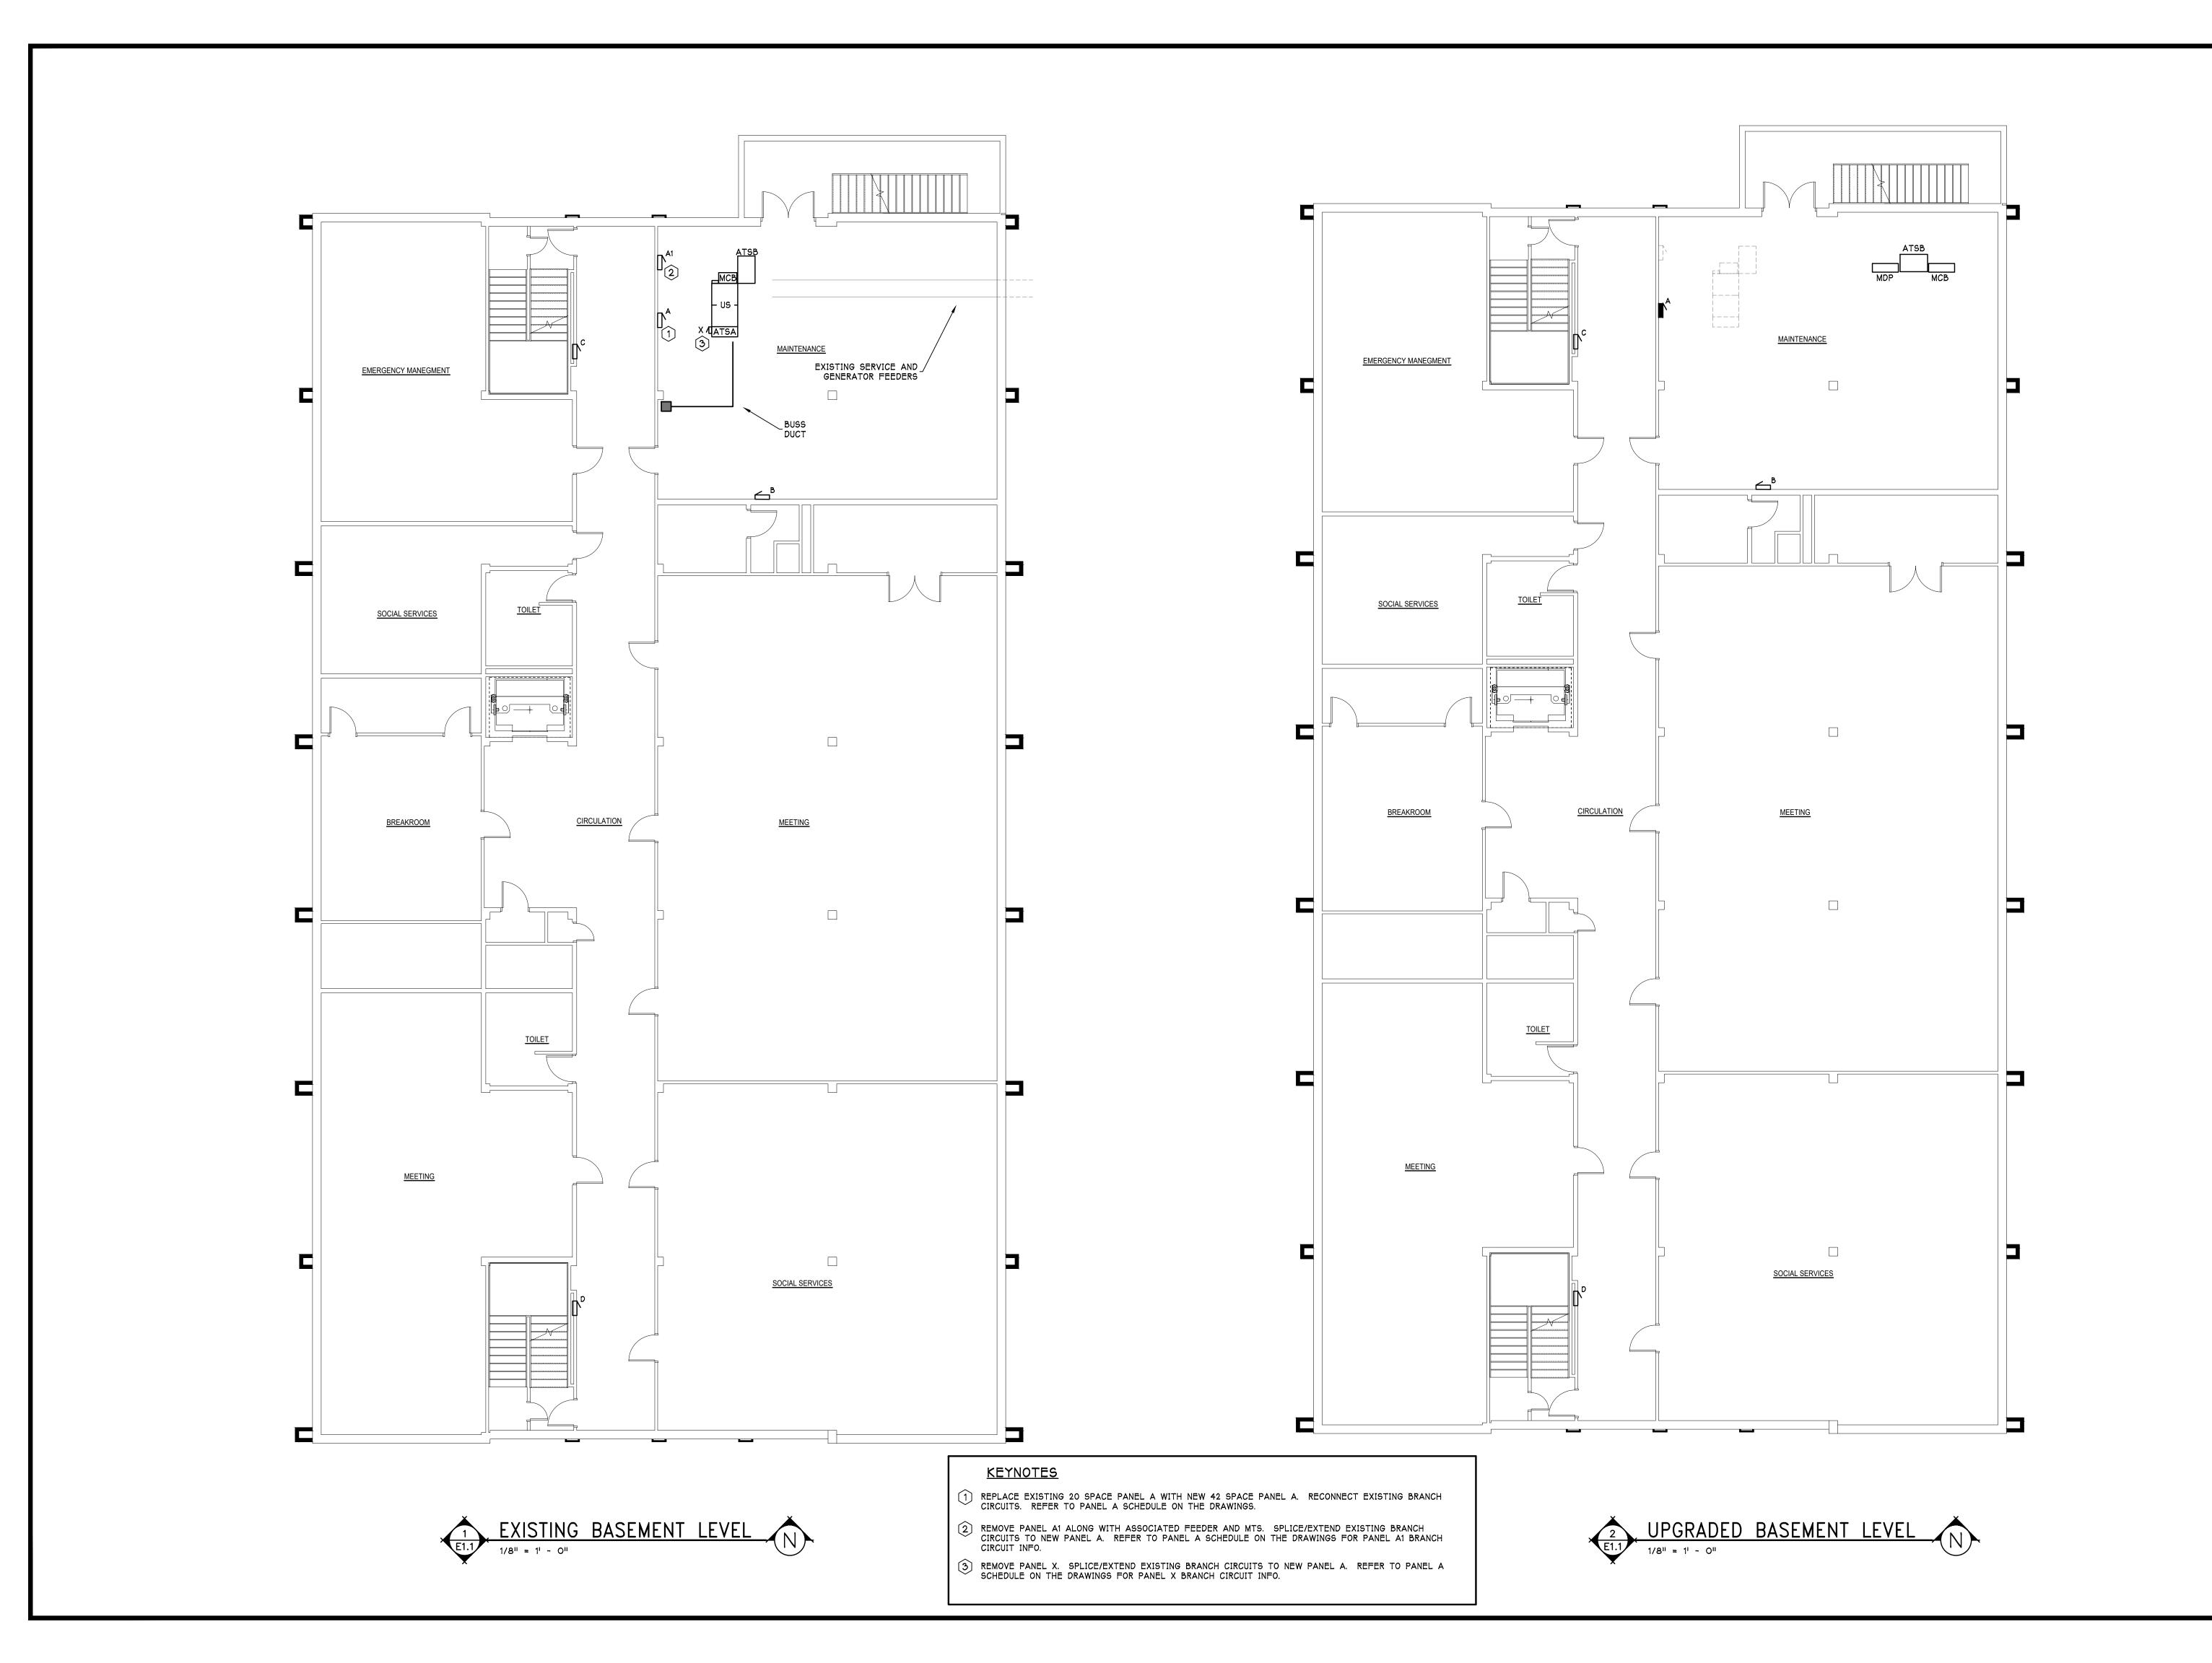


SHEET

E1.1 of **6**


Prairie Engineering P.C. Professional Consulting Engineers

RAMSEY COUNTY COURTHOUSE ELECTRICAL SYSTEM UPGRADE DEVILS LAKE, NORTH DAKOTA

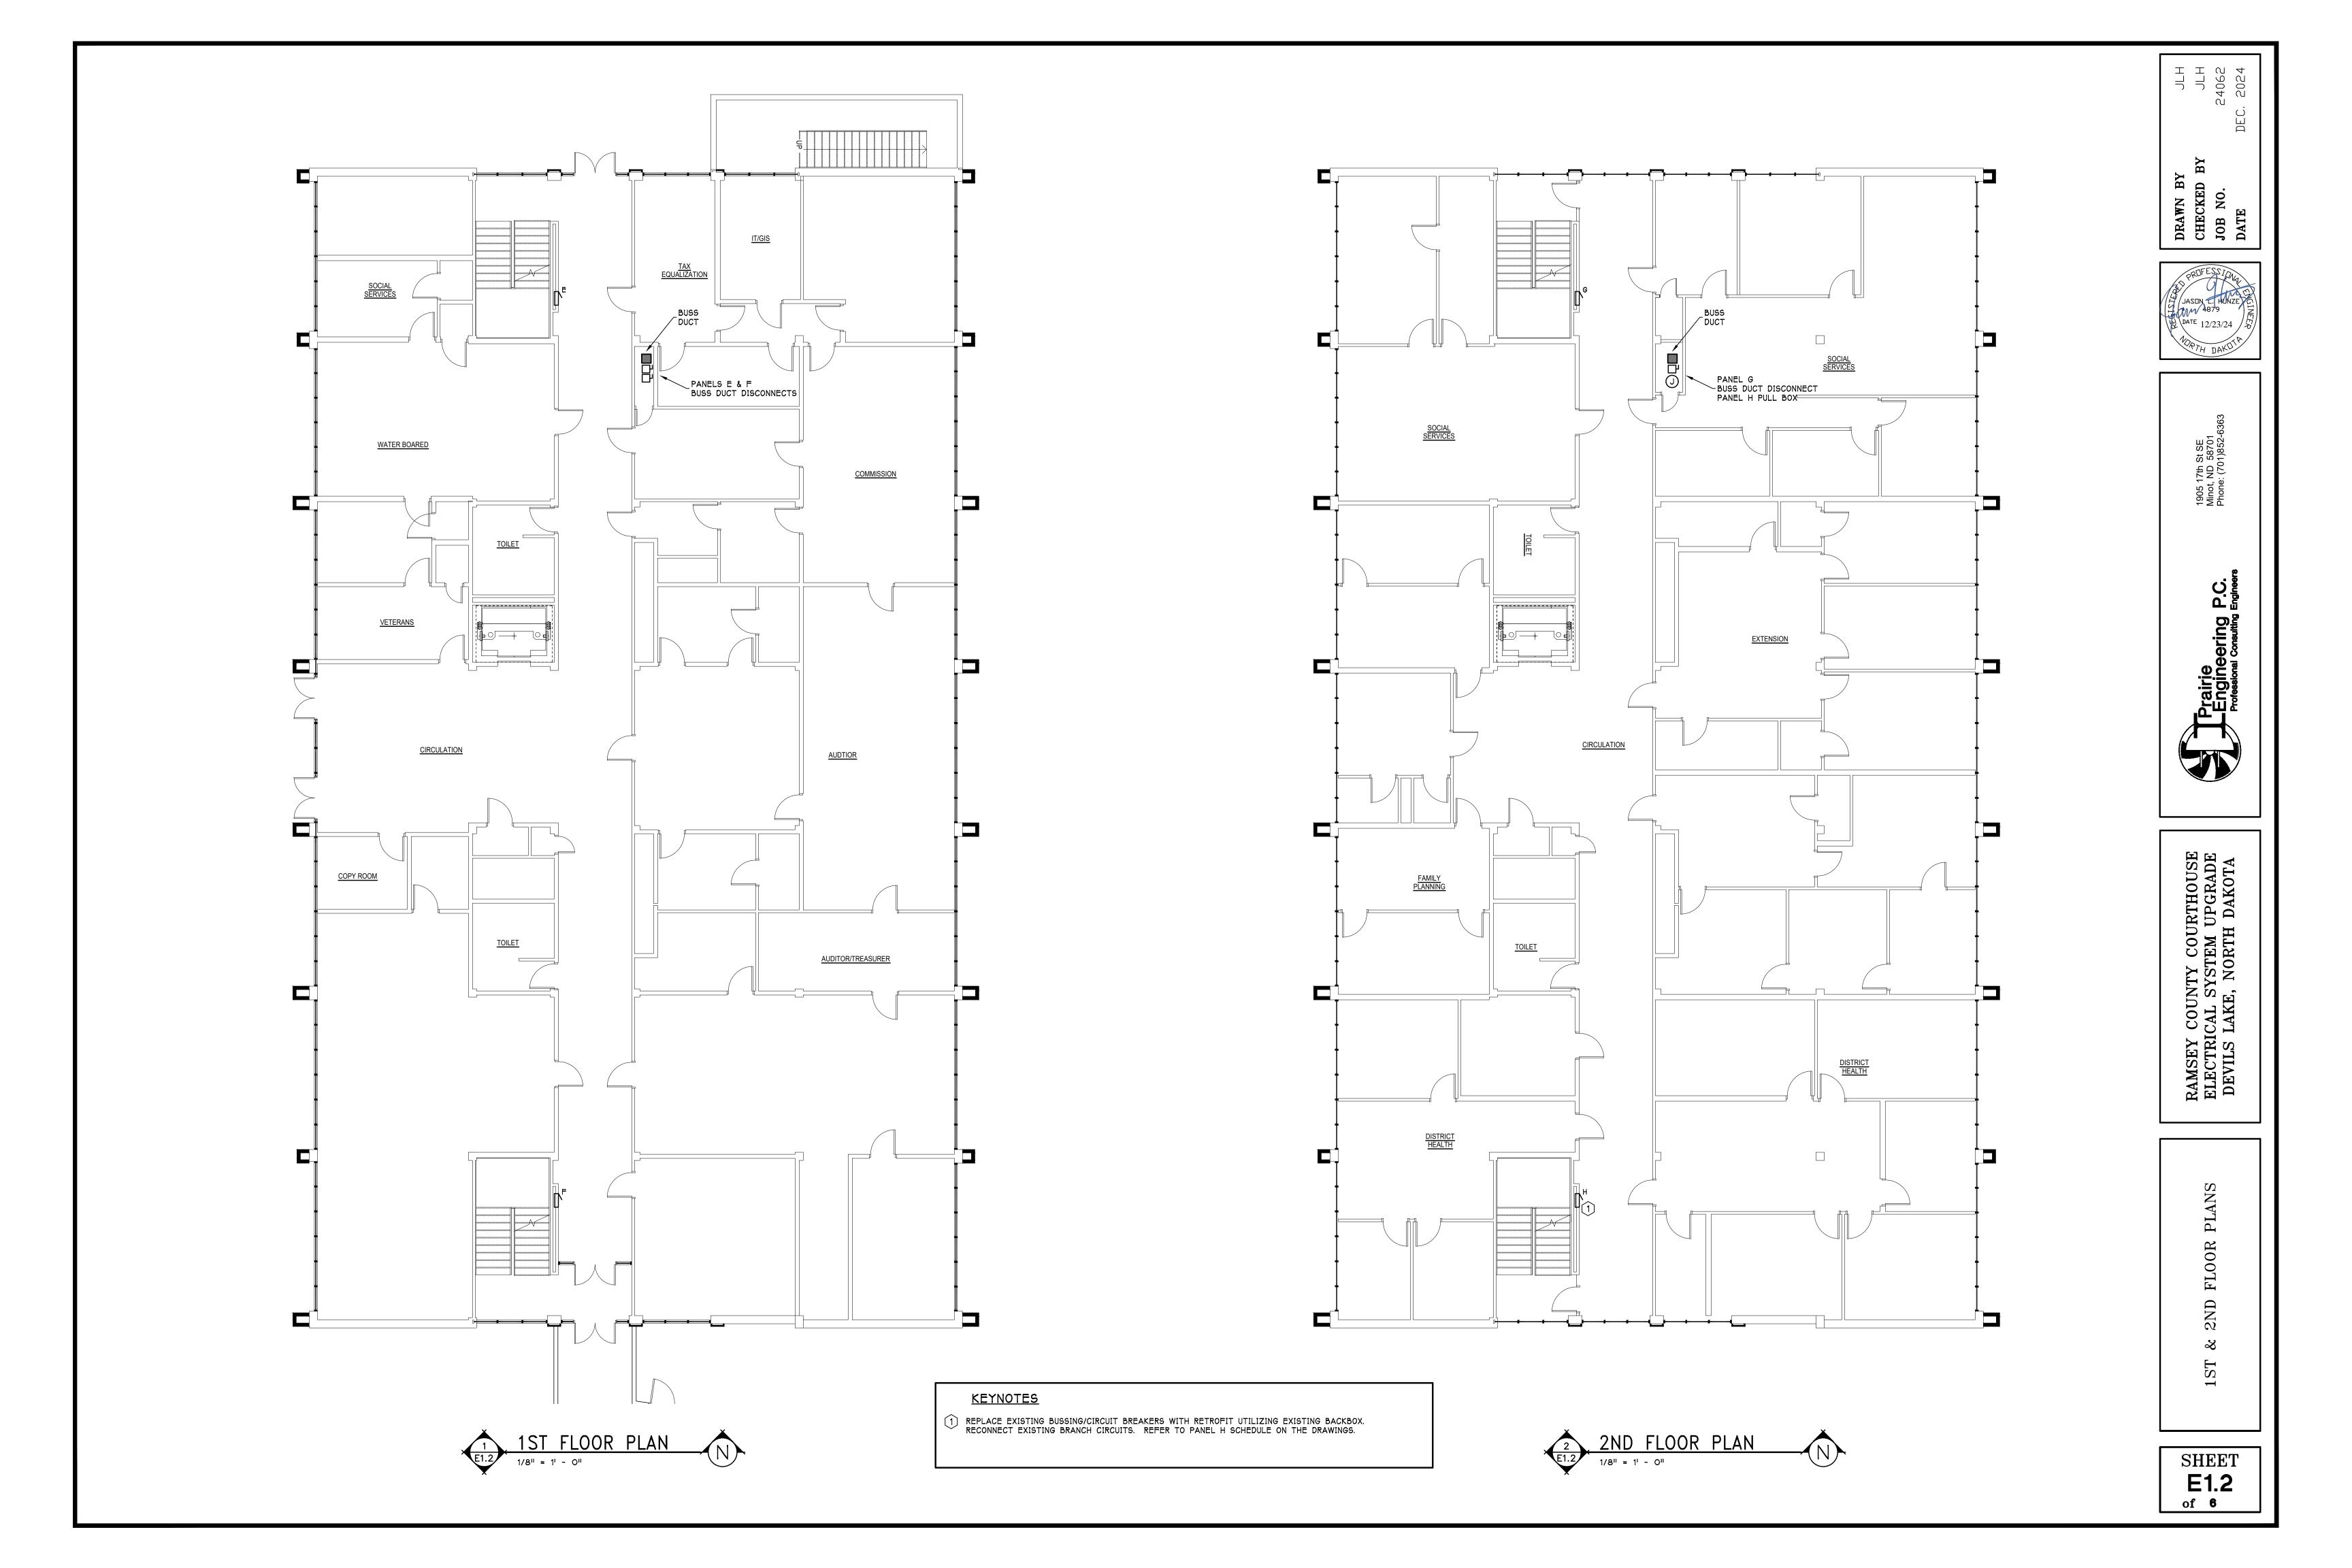

PENTHOUSE PLAN

1/8" = 1' - 0"

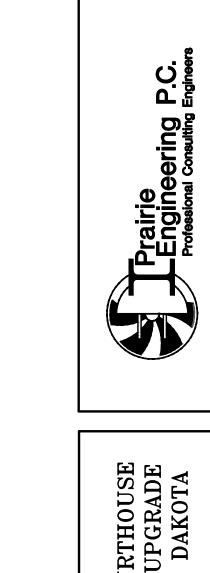


RAMSEY COUNTY COURTHOUSE ELECTRICAL SYSTEM UPGRADE DEVILS LAKE, NORTH DAKOTA

DRAWN BY
CHECKED BY
JOB NO.
DATE


1905 17th St SE Minot, ND 58701 Phone: (701)852-6


3RD FLOOR PENTHOUSE PLANS AND

SHEET **E1.3**

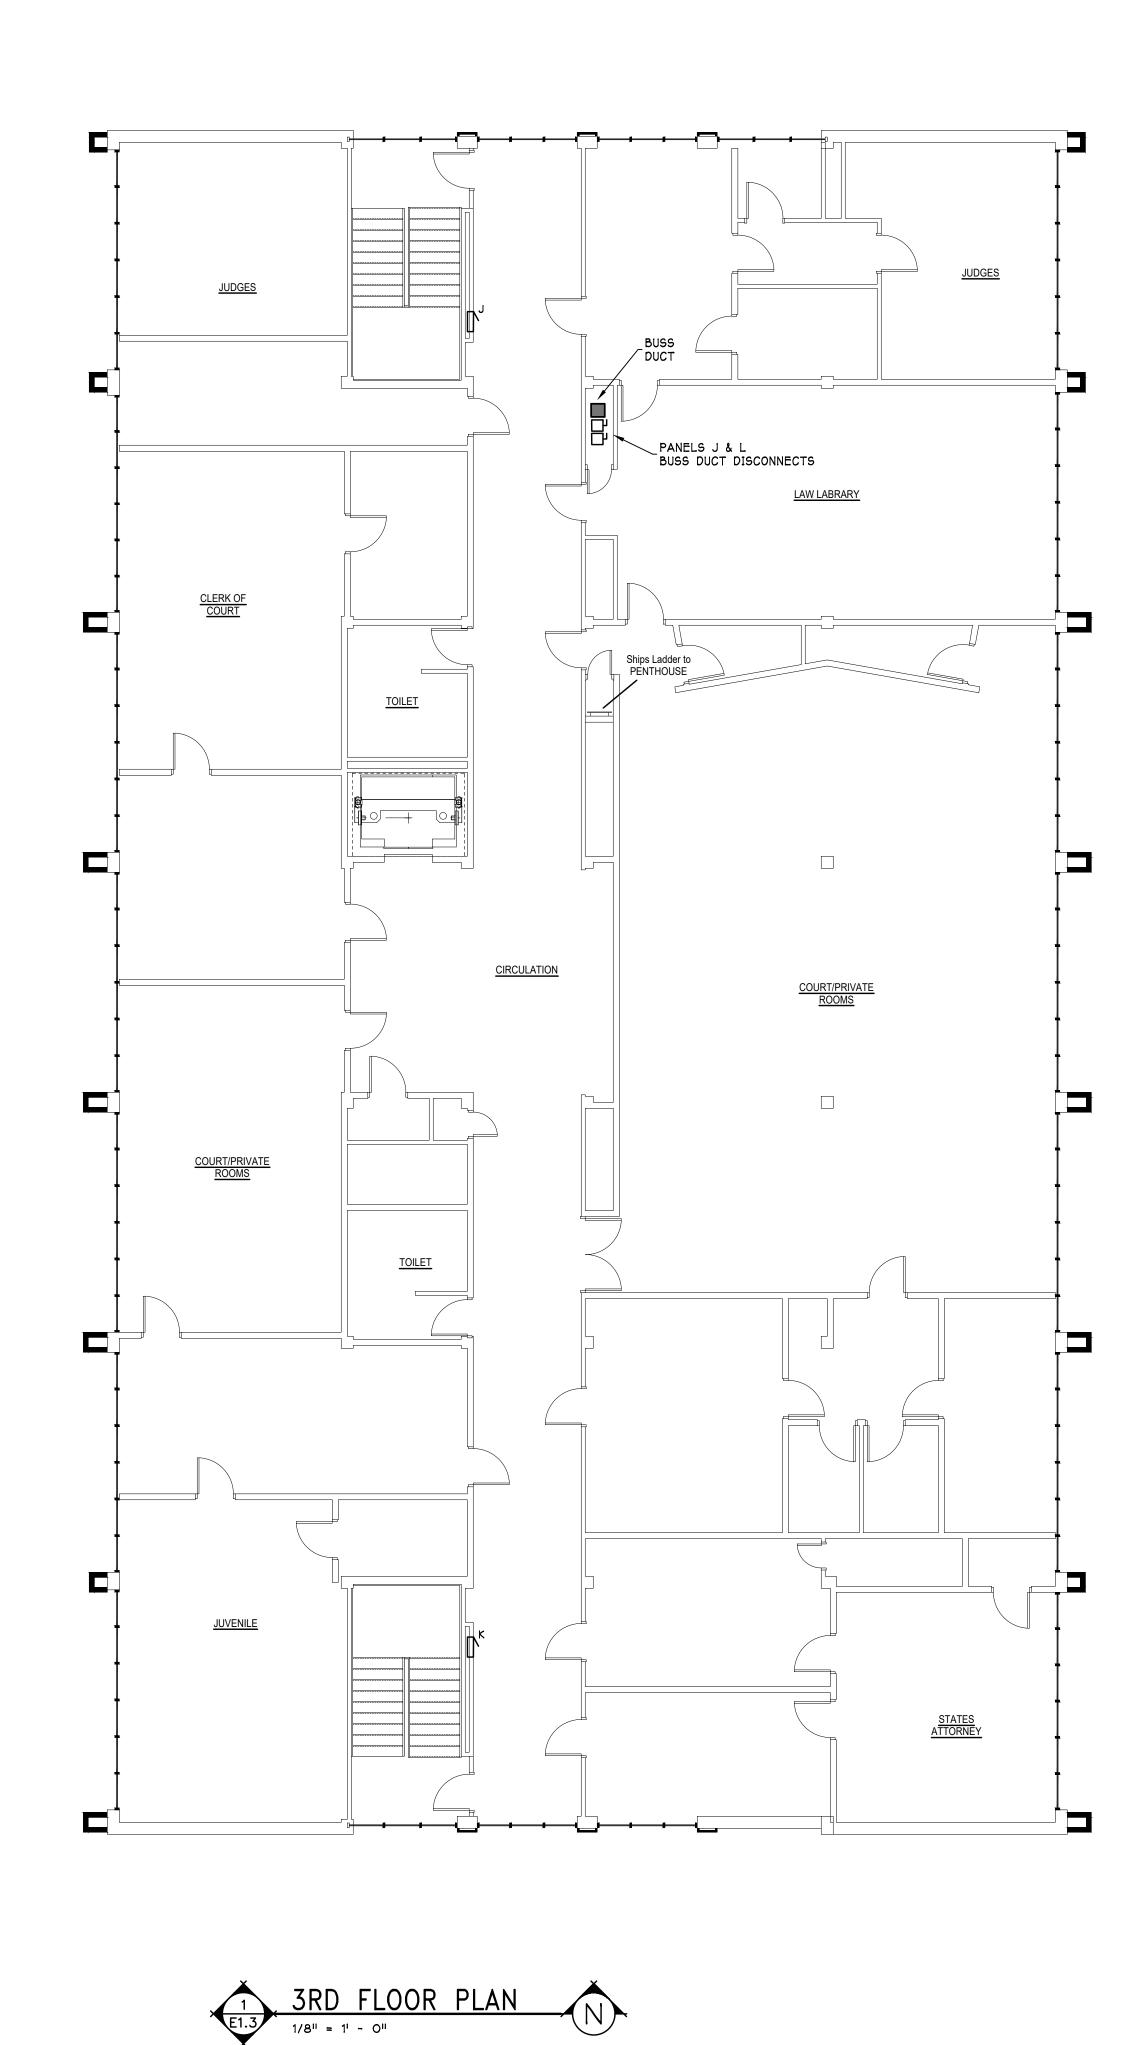




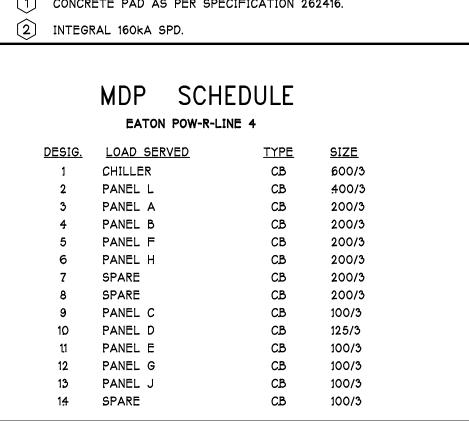

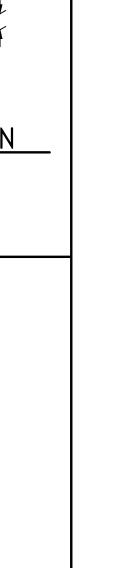

		PA	NEL	A SCI	HEDU	ILE		
120/208 V	OLTS 3	PH 4	4 W 2	25 A	MLC	SU	RFACE A	MOUNTED
	EA ⁻	TON	POV	/-R-L	INE :	SER:	ŒS	
	CKT	GF	CKT		CKT	GF	c_{KT}	
DESCRIPTION	BKR	CI	#	PH.	#	CI	BKR	DESCRIPTION
XISTING	20/1		1	Α	2		20/1	EXSITING
XISTING	20/1		3	В	4		20/1	EXSITING
XISTING	20/1		5	С	6		20/1	EXSITING
XISTING	20/1		7	Α	8		20/1	EXSITING
XISTING	20/1		9	В	10		20/1	EXSITING
XISTING	20/1		11	С	12		20/1	EXSITING
XISTING	20/1		13	Α	14		20/1	EXSITING
XISTING	15/3		15	В	16		20/1	EXSITING
XISTING	-		17	С	18		30/2	EXSITING
XISTING	-		19	Α	20		-	EXSITING
XISTING PNL X	20/2		21	В	22		15/1	EXSITING PNL A1
XISTING PNL X	-		23	С	24		25/1	EXSITING PNL A1
XISTING PNL X	20/1		25	Α	26		20/1	EXSITING PNL A1
XISTING PNL X	20/1		27	В	28		20/1	EXSITING PNL A1
JMP 1	20/3		29	С	30		20/1	EXSITING PNL A1
JMP 1	-		31	Α	32		20/1	SPARE
JMP 1	-		33	В	34		20/1	SPARE
PARE	20/1		35	С	36		20/1	SPARE
PARE	20/1		37	Α	38		20/1	SPARE
PARE	20/1		39	В	40		20/1	SPARE
PARE	20/1		41	С	42		20/1	SPARE

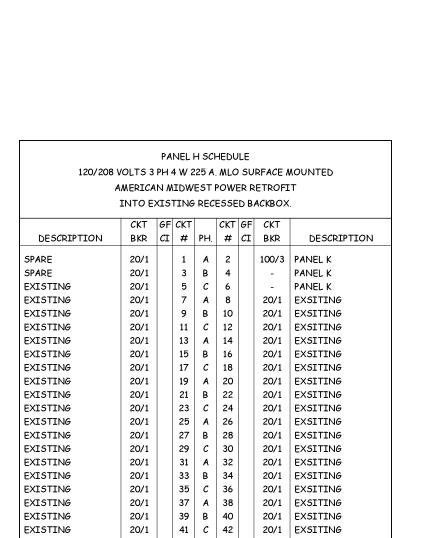



800A MCB [

LOAD SIDE

1 CONCRETE PAD AS PER SPECIFICATION 262416.

120/208V 3ø4W

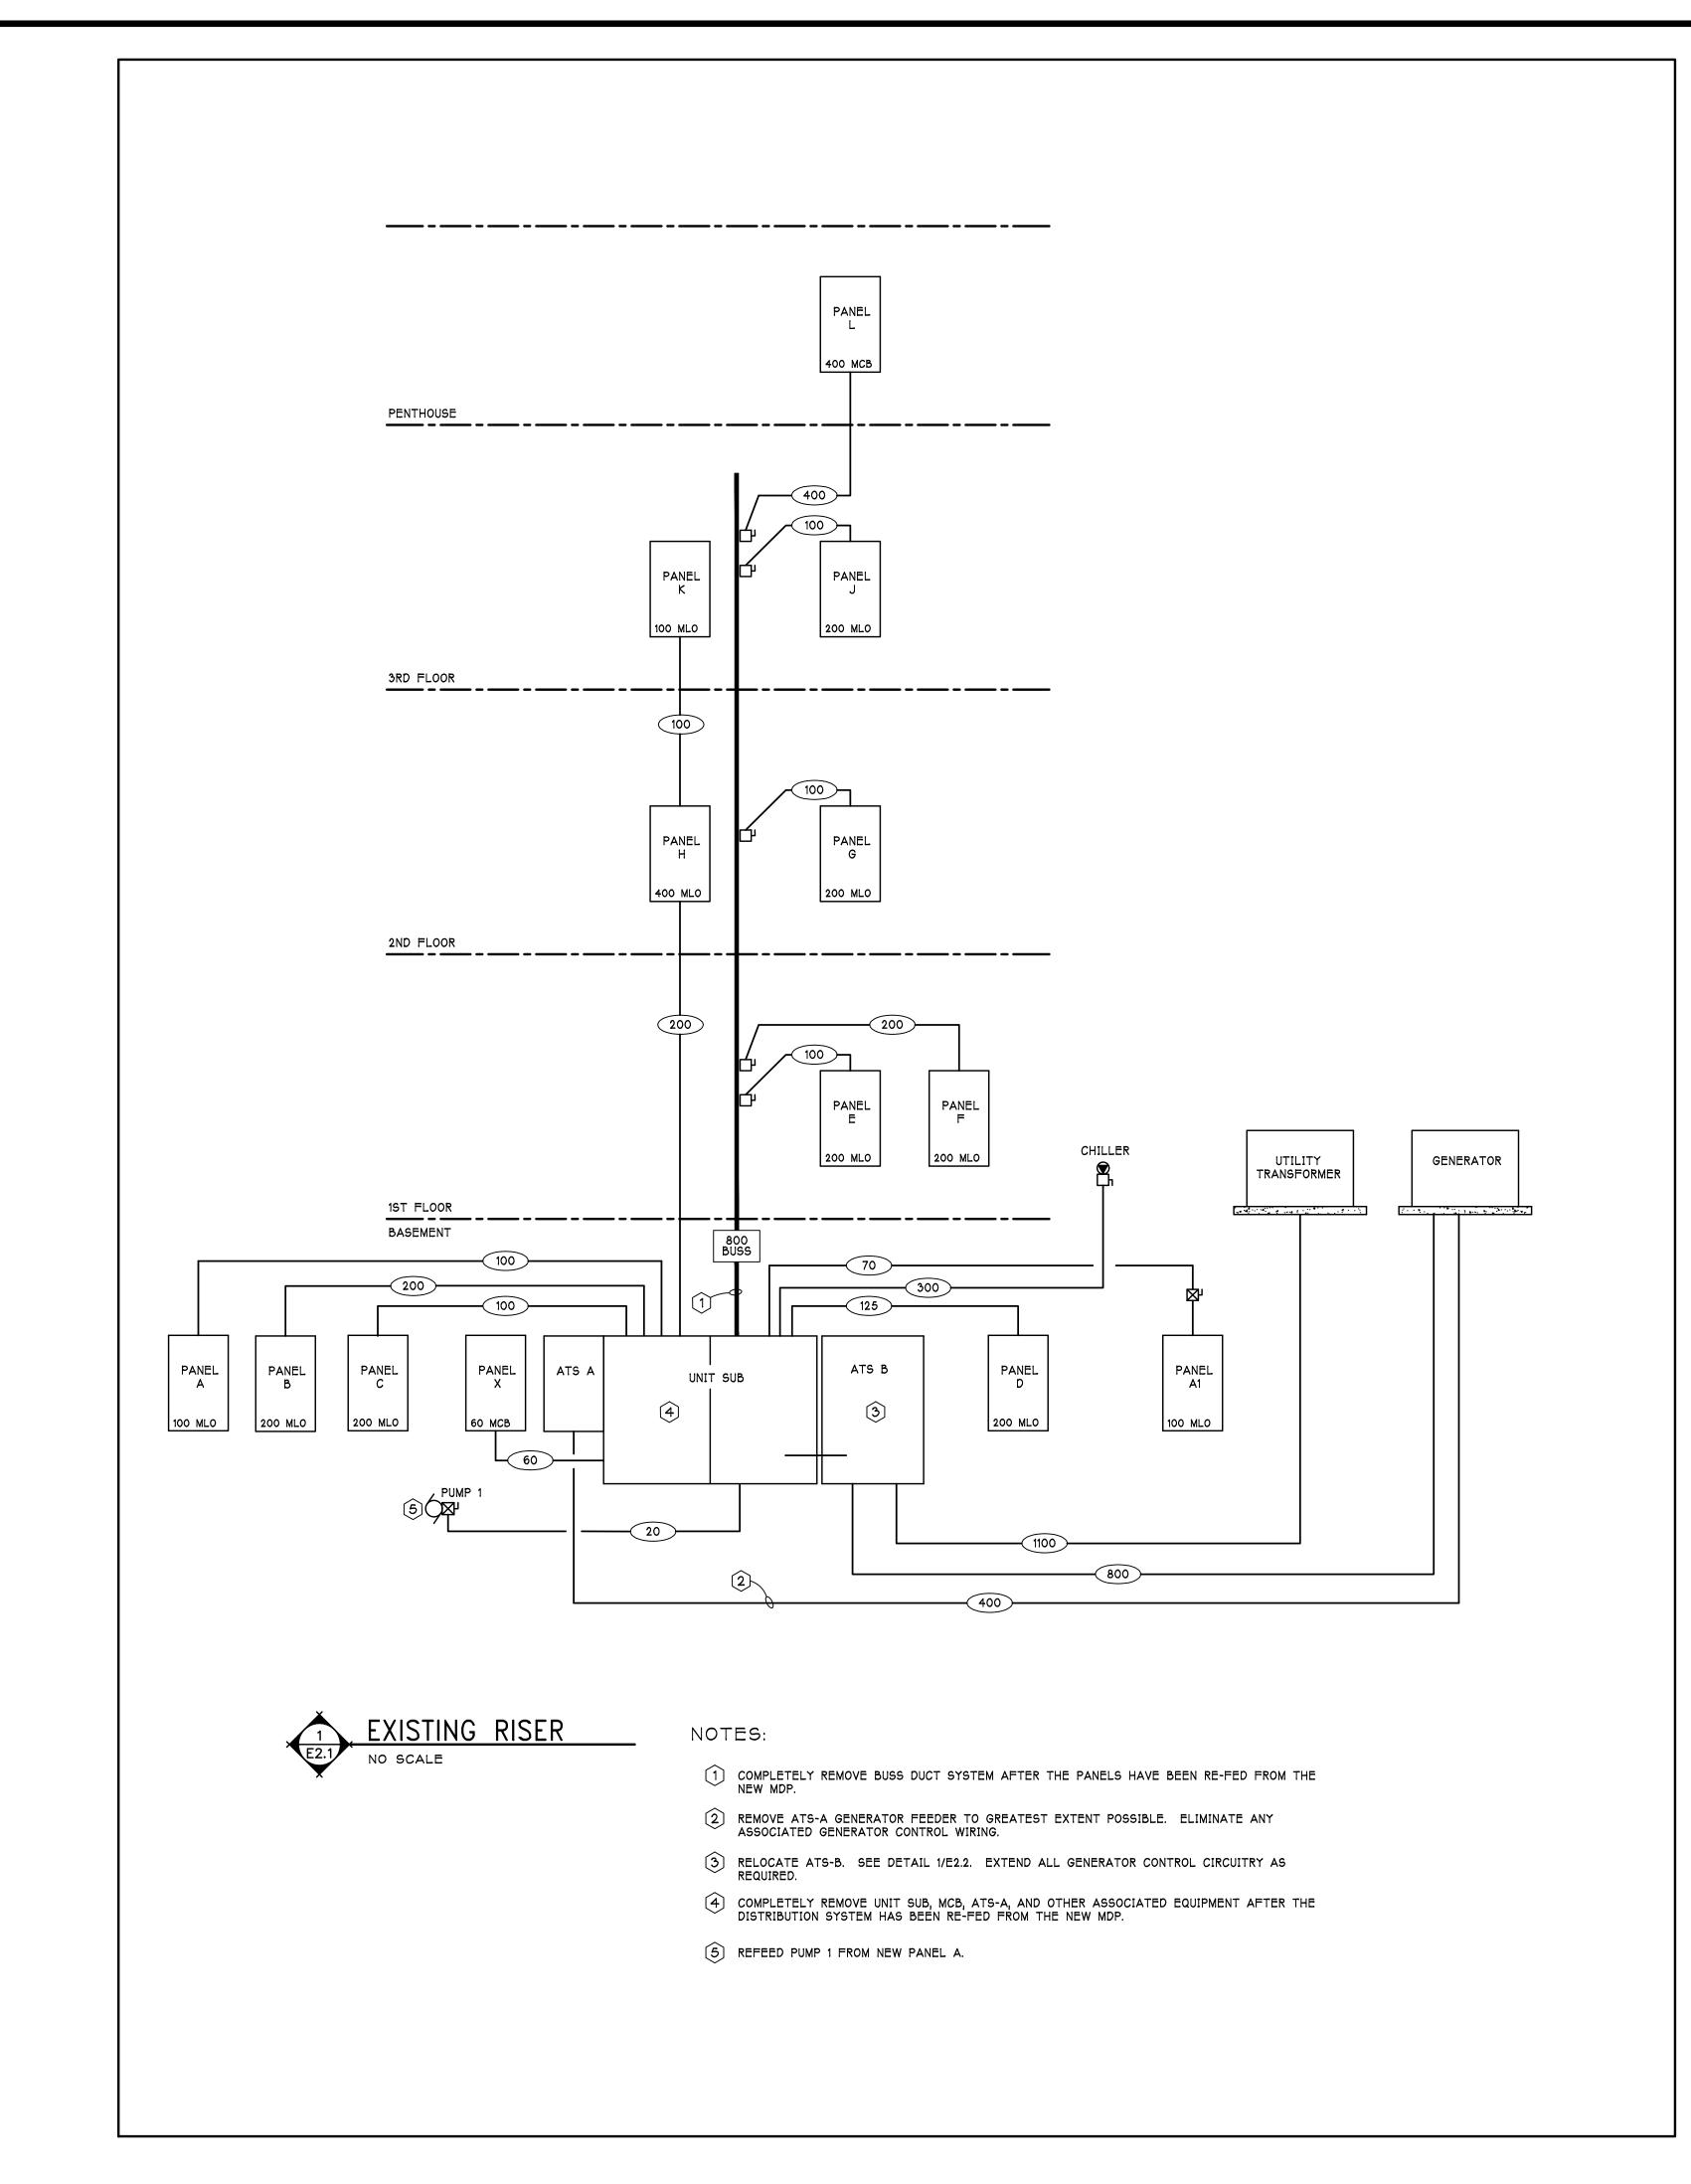

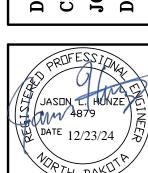



P.C. Prairie Engineering Frofessional Consulting E

RAMSEY COUNTY COURTHOUSE ELECTRICAL SYSTEM UPGRADE DEVILS LAKE, NORTH DAKOTA

SHEET

of **6**


SET THE NEW MCB AND MDP IN PLACE ON NEW HOUSEKEEPING PAD.

2. SCHEDULED OUTAGE #1 DE-ENERGIZE ELECTRIC SERVICE. DISCONNECT SERVICE FEEDER FROM UNIT SUB AND RE-TERMINATE IN MCB.

RELOCATE ATS-B.
INSTALL NEW FEEDERS BETWEEN ATS-B, MCB, AND MDP.
RE-TERMINATE GENERATOR FEEDER TO ATS-B.
PROVIDE TEMPORARY WIRING FROM MDP TO UNIT SUB.
RE-ENERGIZE ELECTRIC SERVICE. NOTE: IT MAY BE POSSIBLE TO UTILIZE ATS-A TO KEEP PART OF THE BUILDING OPERATIONAL DURING THIS OUTAGE.

- ONCE THE NEW MDP IS ON-LINE, COORDINATE LOCALIZED OUTAGES WITH THE OWNER FOR EXTENDING EACH INDIVIDUAL DISTRIBUTION FEEDER FROM THE UNIT SUB AND BUSS DUCT TO THE MDP, ONE-BY-ONE.
- 4. AFTER ALL DISTRIBUTION SYSTEM EQUIPMENT HAS BEEN TRANSFERRED OVER TO THE NEW MDP, SCHEDULE A SHORT OUTAGE TO REMOVE THE TEMPORARY
- 5. REMOVE THE OLD EQUIPMENT NO LONGER IN USE.

DRAWN BY CHECKED JOB NO. DATE

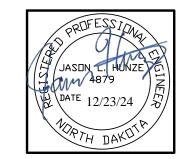

P.C.

Prairie Engineering



(400N)

(100N)

8 100N

(200N)

-(800N)-

(100N)

PANEL

100 MLO

(100N)

PANEL H

200 MLO

200N

PENTHOUSE

3RD FLOOR

2ND FLOOR

1ST FLOOR BASEMENT

_____000N

PANEL

200 MLO

PANEL

200 MLO

NEW

PANEL

200 MLO

PANEL

400 MCB

PANEL

200 MLO

PANEL

200 MLO

r-----

[8] PANEL

RELOCATED

-(800N)-

_----

PANEL

200 MLO

PANEL

200 MLO

L----J----

CHILLER


UTILITY

TRANSFORMER

GENERATOR

DEGIO	CONETCU	PEOUTPED	CONDUC	CTOR SIZE (NOTE 3)		NOMENCLATURE: 400 N S - 1	
DESIG- CONFIGU- NATION RATION		REQUIRED AMPACITY	PHASE	NEUTRAL	EGC		
800N	3ø 4W	800	(2) 500 KCMIL	(2) 500 KCMIL	(2) #3	(2) 3-1/2"	AMPACITY / / /
400N	3ø 4W	400	500 KCMIL	500 KCMIL	#3	3-1/2"	N - NEUTRAL REQ'D
200N	3ø 4W	200	3/0	3/0	#6	2"	BLANK NOT REQ'D / /
125N	3ø 4W	125	1/0	1/0	#6	1-1/2"	SPECIALTY INDICATOR _
100N	3ø 4W	100	#2	#2	#8	1-1/4"	S - SERVICE FEEDER
20	3ø 3W	20	#12	NR	#12	3/4"	1- SINGLE PHASE ∫ BLANK3-PHASE



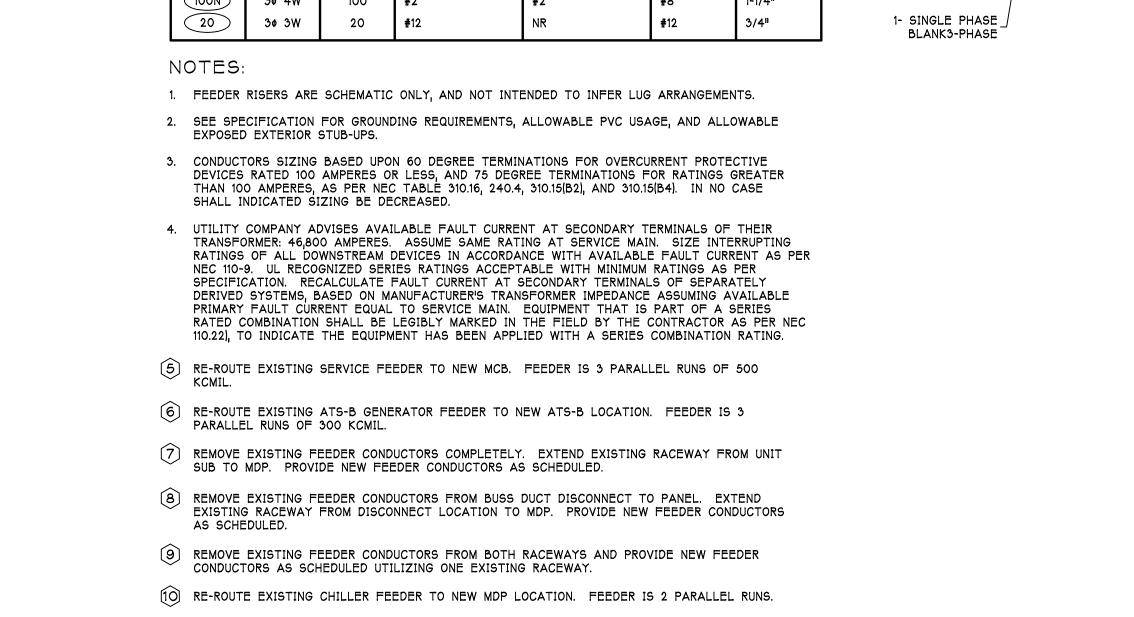

RAMSEY COUNTY COURTHOUSE ELECTRICAL SYSTEM UPGRADE DEVILS LAKE, NORTH DAKOTA

UPGRADED

SHEET