

TURTLE MOUNTAIN
COMMUNICATIONS NEW
BUILDING
BOTTINEAU, NORTH DAKOTA

ICON

ARCHITECTURAL GROUP

222 EAST MAIN STREET, SUITE B
MANDAN, ND 58554
(701) 751.0430 OFFICE
WWW.ICONARCHITECTS.COM

STRUCTURAL

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MECHANICAL

MBN ENGINEERING, INC.
503 7TH STREET NORTH, SUITE 200
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(701) 478.6336 OFFICE

ELECTRICAL

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TURTLE MOUNTAIN COMMUNICATIONS NEW BUILDING BOTTINEAU, ND

DRAWING HISTORY

NO.	DESCRIPTION	DATE
1	CONSTRUCTION DOCUMENTS	01/15/2025

DRAWN BY: BZ

JN: 24-054



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DRAWN BY: Author JN: 24-054

Code Study

SHEET

G002

CODE STUDY -
2021 INTERNATIONAL BUILDING CODE
Project Name UTMA OFFICE AND SHOP BUILDING
Project Location BOTTINEAU, ND

Item	Description	Code Section
Occupancy	B Business, S-1 Storage	Chapter 3
Gross Square Footage	1st Floor 12,682 sf B Occupancy 5,005 sf S-1 Occupancy 7,677 sf Total 12,682 sf	See Plan
Constr. Type	Type IIB Construction	602.2
General Building Heights And Areas	Group B NS = 3 stories @ 23,000 sf Max 55 ft. in height above grade plane Group S-1 NS = 2 stories @ 17,500 sf Max 55 ft. in height above grade plane	Table 504.3 Table 504.4 Table 506.2
Required Separation of Occupancies	B to S-1 requires no separation	Table 508.4
Mixed Occupancy Area Determination	1st Floor Actual SF of B: 5,005/23,000 = .218 Actual SF of S-1: 7,677/17,500 = .439 .218 + .439 = .657 < 1 = ok	508.4.2
Fire Resistance Rating Requirement For Building Elements (In Hours)	Type IIB 0 Hour for Primary Structural Framing 0 Hour for Interior and Exterior Bearing Walls 0 Hour for Floor Construction 0 Hour for Roof Construction	Table 601
Corridors	Corridors shall be fire-resistance rated in accordance with Table 1020.2. The corridor walls required to be fire-resistance rated shall comply with 708 for fire partitions.	1020.2
Corridor Fire-Resistance Rating	B Occupancy with Occupant Load larger than 30 in a non-sprinklered condition	Table 1020.2
Fire Walls	None Required	706
Fire Barriers / Shaft Enclosures	None Required	707
Fire Partitions	Corridors - 0.5 Hr	708.3 Exception 1
Fire Extinguisher Requirements	Fire Extinguishers For Class A Fire Hazards: Minimum Rated Single Extinguisher = 2-A Maximum Floor Area Per Unit Of A = 3,000 SF Minimum Rated Single Extinguisher = 2-A Maximum Floor Area Per Unit Of A = 3,000 SF (3) Provided in Garage portion of building (2) Provided in Office portion of building	906
Automatic Sprinkler System	Not required in an S-1 Occupancy that is less than 12,000 sf fire area does not require a sprinkler system. Garage is S-1 rather than S-2 since it is a private parking area with no commercial vehicle repair, rather than a public parking area. There are no requirements for a B Occupancy fire area size.	903.2.9
Manual Fire Alarm	Not Required in Group B or S-1 Application	907.2.2
Emergency Alarm Systems	Not Required in a Group B or S-1 Application	908
Automatic Smoke Detection System	Not Required in a Group B or S-1 Application	909
Exit Access Travel Distance	200 Feet without NFPA 13 Sprinkler System	Table 1017.2

EXIT DATA

1st Floor Occupancy Load = 34 Office 38 Shop

Exit No.	Occupant Load	Exit Width Per Occupant Served	Total Required Width of Exit	Actual Width
1	17	.2	3.4"	32"
2	17	.2	3.4"	32"
3	20	.2	3.8"	32"
4	20	.2	3.8"	32"

Exit Travel Requirements

Path No.	Travel Distance
1	90' - 3"
2	93' - 8"
3	58' - 1"
4	111' - 5"

Plumbing Counts
B Occupancy
34 Occupants
17 M
17 F
Toilets - 125 for first 50 and 1.50 for remainder M and F
Lavs - 1.40 for first 50 and 1.80 for remainder M and F

S-1 Occupancy
38 Occupants
19 M
19 F
Toilets - 1:100 M and F
Lavs - 1:100 M and F

Toilets Total
B - 17/25 = .68 M
B - 17/25 = .68 F
S-1 - 19/40 = .475 M
S-1 - 19/40 = .475 F
0.87 M
0.87 F
(3) provided

Lavs Total
B - 17/40 = .425 M
B - 17/40 = .425 F
S-1 - 19/80 = .2375 M
S-1 - 19/80 = .2375 F
.6625 M
.6624 F
(2) provided



(1) Utility Sink provided

Section 1110.2 Toilet and Bathing Facilities
Exception 3 - Where multiple single-user toilet rooms are clustered at a single location, at least 50 percent but not less than one room for each use at each cluster shall be accessible.

NOTES

- ALL STRUCTURAL STEEL TO BE COATED WITH INTUMESCENT PAINT TO ACHIEVE 1-HOUR FIRE RATING. SEE ASSEMBLIES X629 AND X680.

EXIT LEGEND

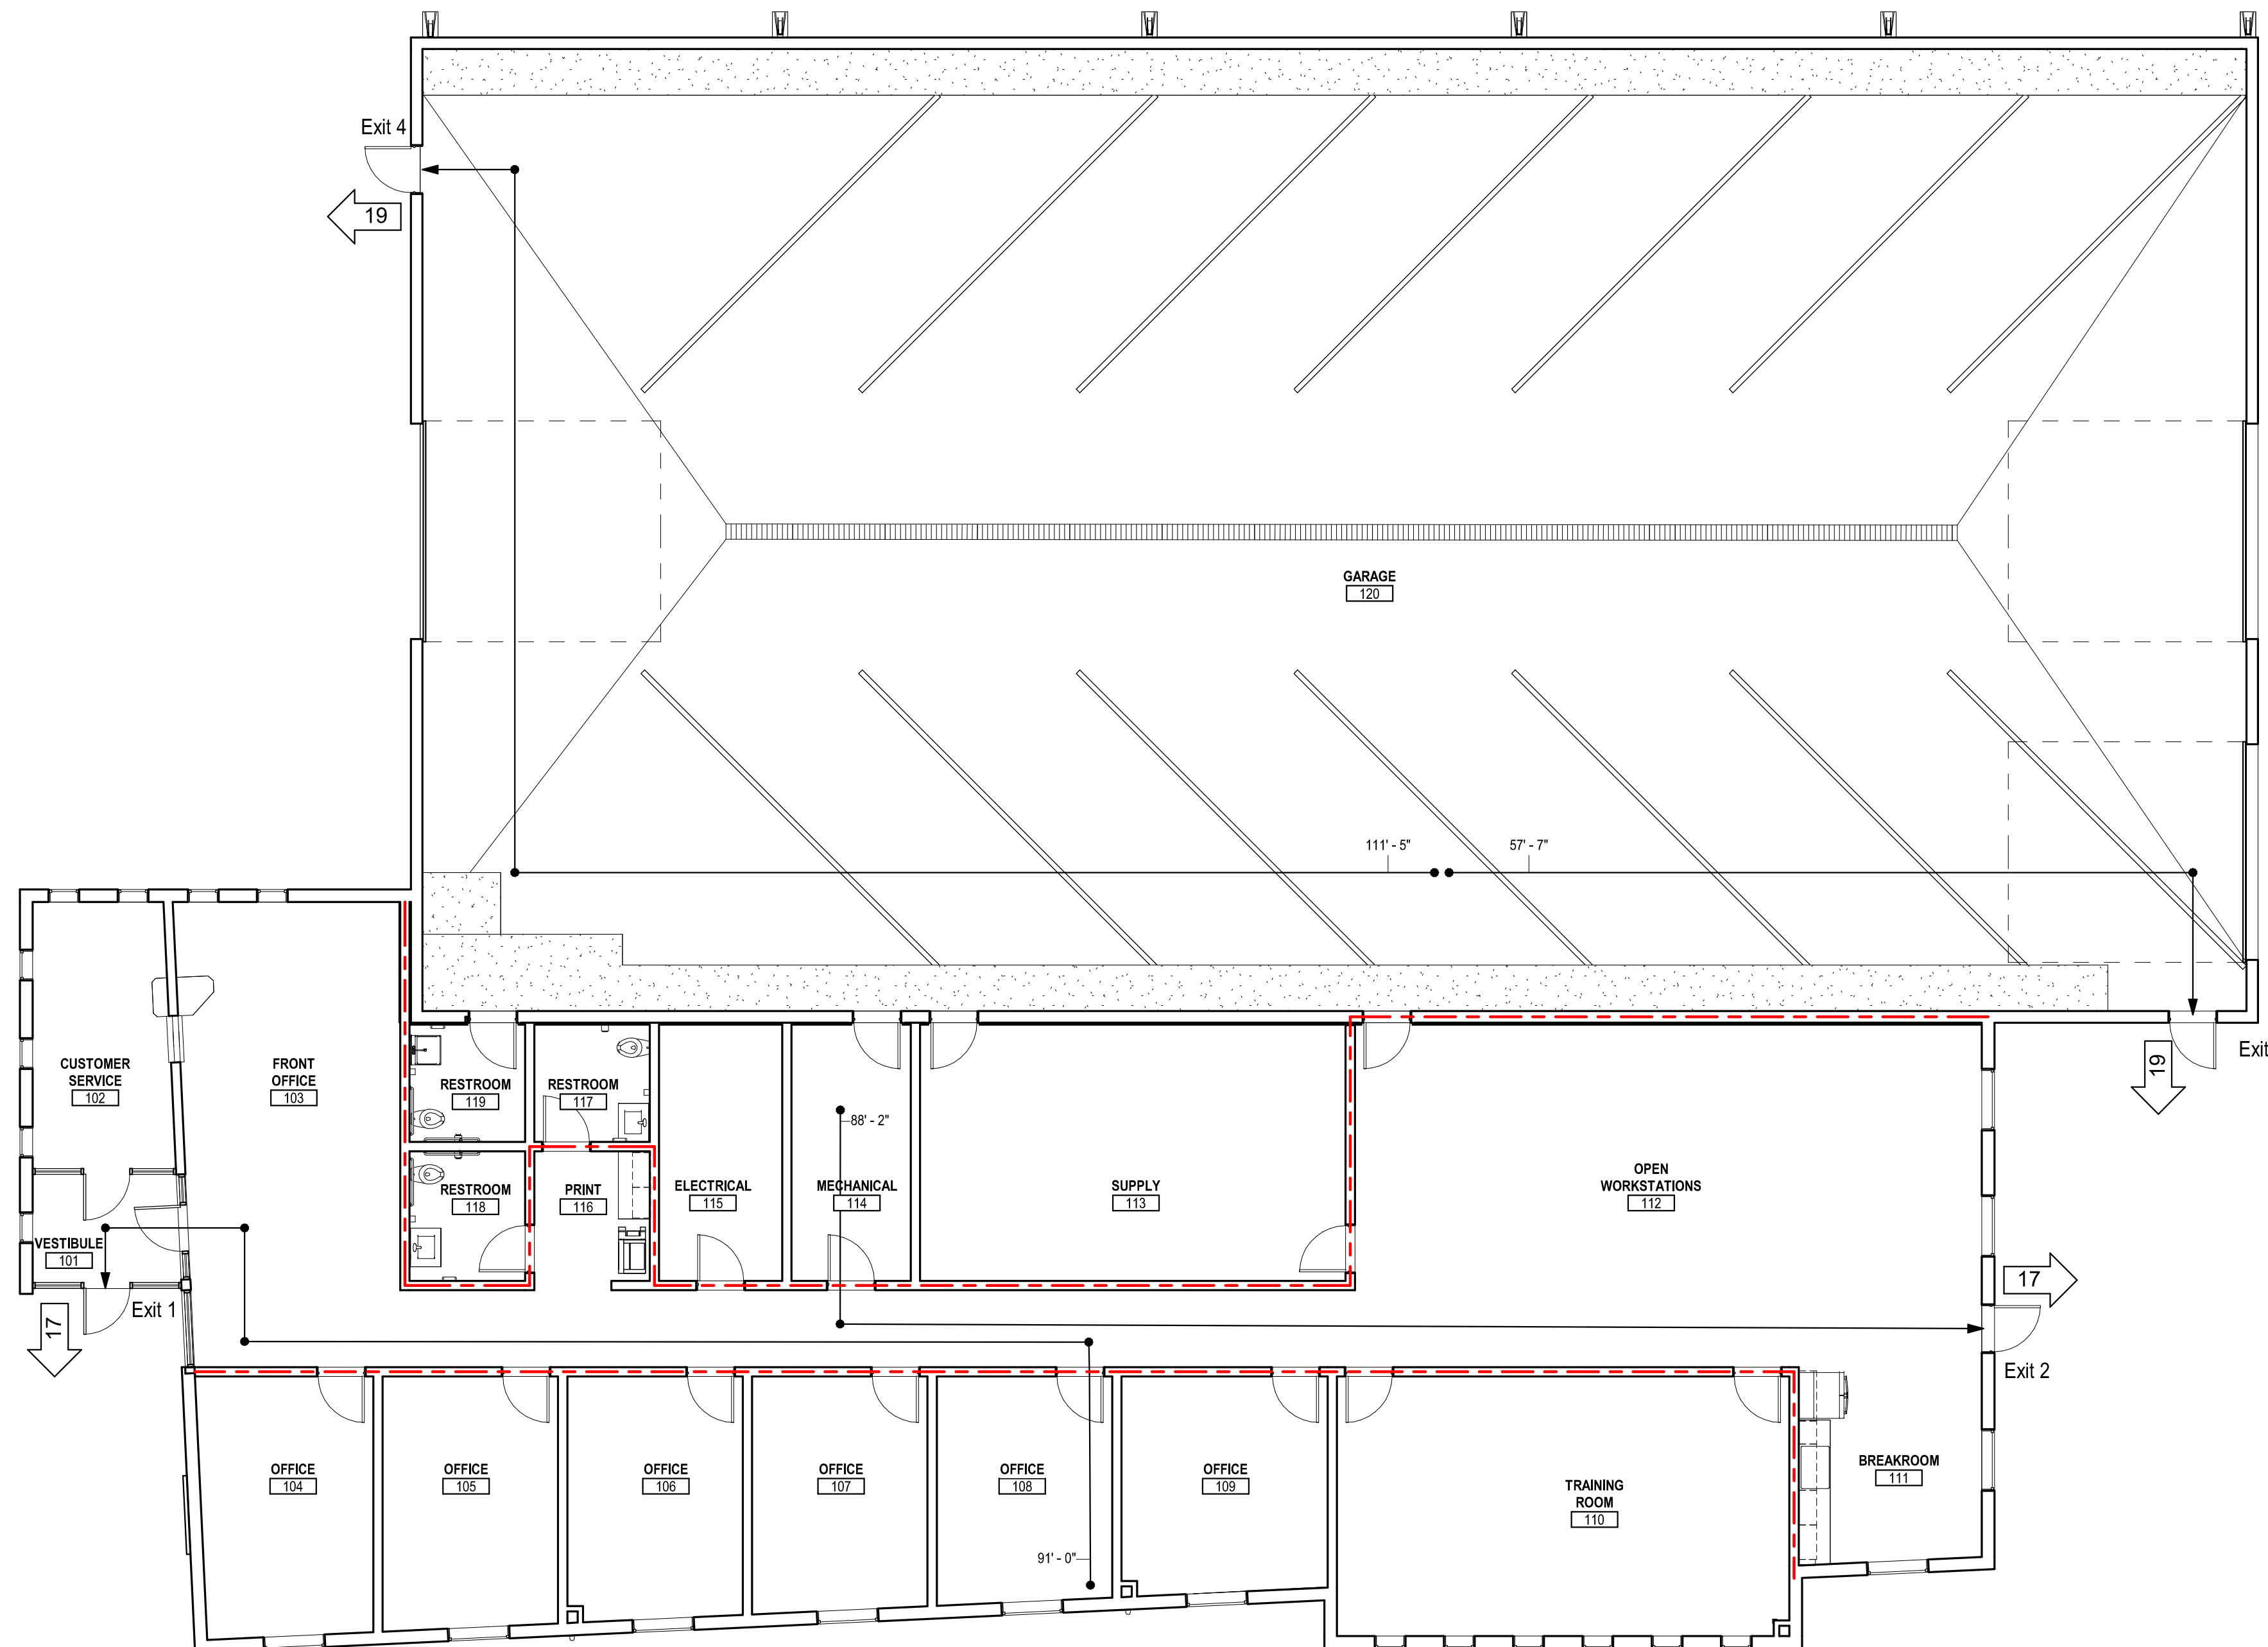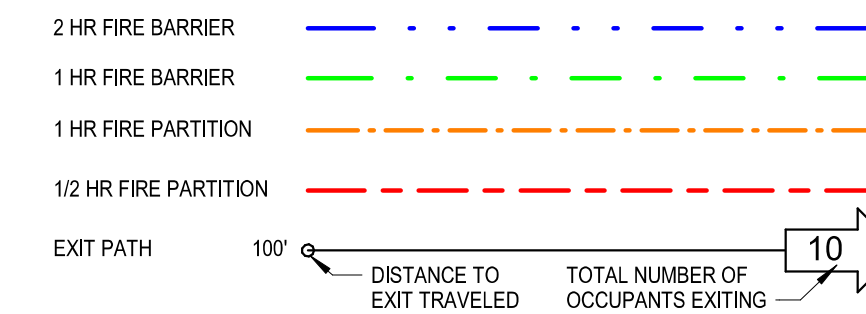



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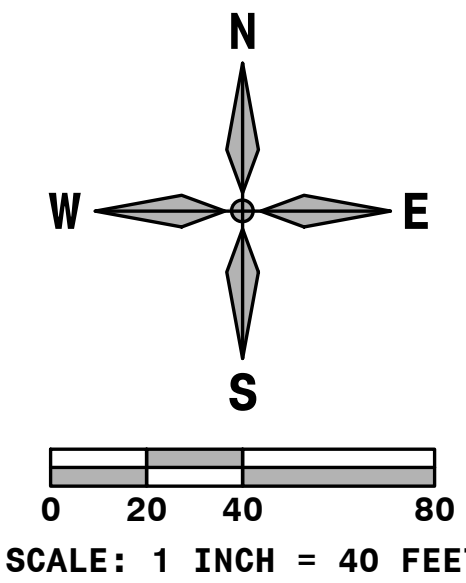
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SYMBOL LEGEND:

- EXISTING PROPERTY LINE
- - - EXISTING EASEMENT LINE
- >->- EXISTING STORM SEWER CULVERT
- >->- EXISTING SANITARY SEWER LINE
- - - EXISTING WATER LINE
- - - EXISTING ELECTRICAL LINE
- - - EXISTING COMMUNICATIONS LINE
- - - EXISTING FLARED END SECTION
- ⊕ EXISTING SANITARY SEWER MANHOLE
- ⊕ EXISTING HYDRANT
- ⊕ EXISTING WATER GATE VALVE
- ⊕ EXISTING LIGHT POLE
- ⊕ EXISTING POWER POLE
- ⊕ EXISTING ELECTRICAL PEDESTAL
- ⊕ EXISTING COMMUNICATIONS PEDESTAL
- - - EXISTING CONTOUR LINE
- - - REMOVE/RELOCATE EXISTING ELECTRICAL LINE
- ▨ REMOVE EXISTING GRAVEL

PLAN NOTES:

1. ALL WORK SHALL COMPLY WITH THE MOST RECENT CITY OF BOTTINEAU STANDARD SPECIFICATIONS FOR CONSTRUCTION OF PUBLIC UTILITIES.
2. CONTRACTOR SHALL NOTIFY UTILITY COMPANIES FOR UNDERGROUND LOCATIONS 48 HOURS PRIOR TO BEGINNING CONSTRUCTION. NORTH DAKOTA ONE CALL PHONE NUMBER: 1-800-795-0555
3. CONTRACTOR SHALL PROTECT ALL PROPERTY PINS. PROPERTY PINS DESTROYED OR DISTURBED SHALL BE REPLACED AT CONTRACTORS EXPENSE.
4. CONTRACTOR SHALL MAINTAIN TEMPORARY EROSION CONTROL UNTIL PERMANENT EROSION CONTROL IS ESTABLISHED.
5. CONTRACTOR SHALL ACQUIRE AN EROSION SEDIMENT CONTROL (ESC) PERMIT FROM THE CITY OF BOTTINEAU PRIOR TO START OF CONSTRUCTION.
6. IF THE LAND BOUNDARY DENOTED ON THE PLANS ENCOMPASSES ONE (1) ACRE OR MORE, A GENERAL PERMIT FOR THE AUTHORIZATION TO DISCHARGE STORM WATER ASSOCIATED WITH CONSTRUCTION ACTIVITY UNDER NATIONAL POLLUTANT DISCHARGE ELIMINATION SYSTEM/STATE DISPOSAL SYSTEM (NPDES/SDS) PERMIT SHALL BE ACQUIRED BY THE CONTRACTOR AND OWNER FROM THE NORTH DAKOTA DEPARTMENT OF ENVIRONMENTAL QUALITY A MINIMUM OF SEVEN (7) DAYS PRIOR TO CONSTRUCTION.
7. ALL PAVEMENT MARKED FOR DEMOLITION SHALL BE FULL DEPTH SAW CUT PRIOR TO REMOVAL.
8. ALL GRASSED AREAS DISTURBED BY CONSTRUCTION SHALL BE TOPSOILED (6" DEPTH), GRADED, SEEDED, AND HYDRO-MULCHED.
9. EXCAVATION OR OTHER WORK IN THE RIGHT-OF-WAY SHALL REQUIRE A TRAFFIC CONTROL PLAN THAT MEETS ALL MANUAL OF UNIFORM TRAFFIC CONTROL DEVICES (MUTCD) REQUIREMENTS. THIS PLAN IS REQUIRED BEFORE ANY PERMITS TO WORK IN THE RIGHT-OF-WAY WILL BE ISSUED.

SITE INFORMATION:

ADDRESS: 1109 11TH STREET E, BOTTINEAU, ND

LEGAL DESCRIPTION: PARCEL A OF LOT 1 OF BLOCK 1 OF COBBLESTONE ADDITION TO THE CITY OF BOTTINEAU

LOT SIZE: 2.14 ACRE (93,404 SF)

ZONING: B-2 (CENTRAL BUSINESS)


SETBACKS: NONE (SECTION 6, 6.0409.4)

EXISTING IMPERVIOUS: 7,636 SF

EXISTING PERVIOUS: 85,768 SF

PROPOSED IMPERVIOUS: 64,224 SF

DISTURBED AREA: 90,404 SF

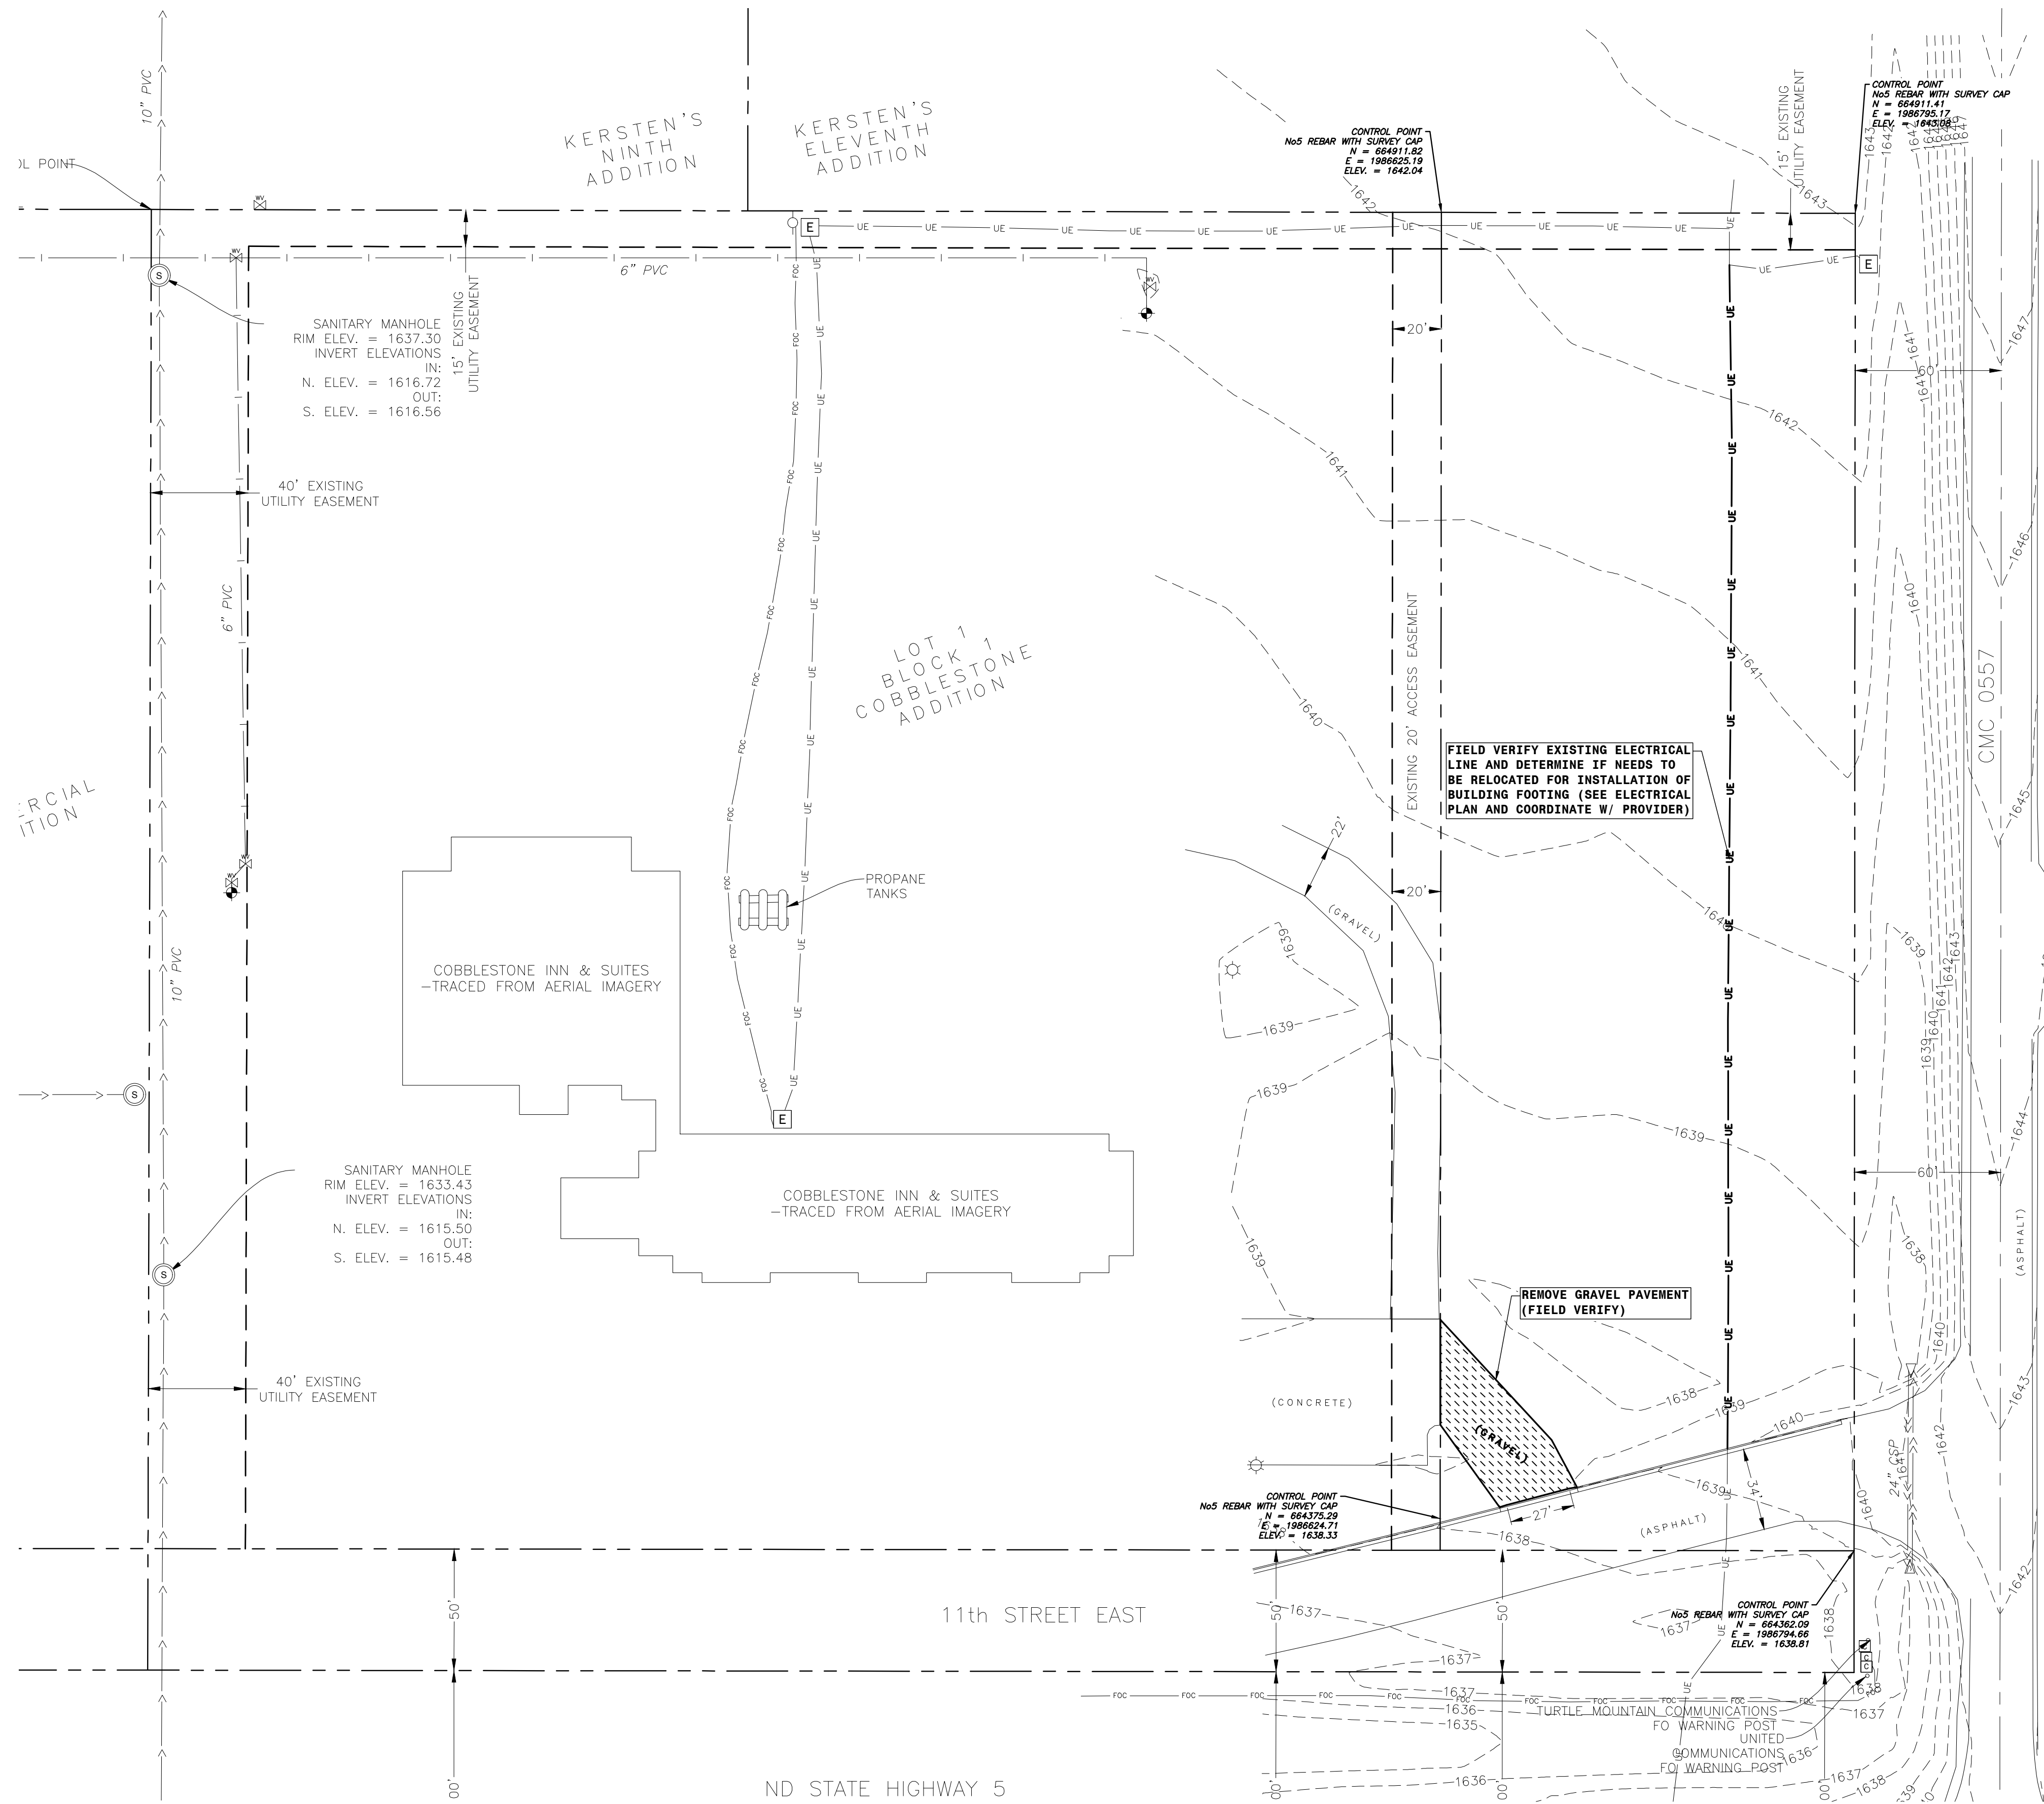

UTILITY COMPANIES LIST:

- | | |
|--|--|
| COMMUNICATIONS:
MIDCO
PO BOX 5010
SIOUX FALLS, SD 57117
1-800-888-1300 | ELECTRIC:
NORTH CENTRAL ELECTRIC COOPERATIVE
538 11TH STREET WEST, SUITE 1
BOTTINEAU, ND 58318
800-247-1197 |
| COMMUNICATIONS:
UNITED AND TURTLE MOUNTAIN COMMUNICATIONS
538 11TH ST. WEST, SUITE 2
BOTTINEAU, ND 58318
701-228-1101 | ELECTRIC:
OTTERTAIL POWER COMPANY
CUSTOMER SERVICE
215 SOUTH CASCADE STREET
FERGUS FALLS, MN 56537 |
| SEWER AND WATER:
CITY OF BOTTINEAU - PUBLIC WORKS
BUILDING
9851 COUNTY ROAD 47
BOTTINEAU, ND 58318
701-228-3620 | |



DRAWING HISTORY

NO.	DESCRIPTION	DATE
1	DESIGN DOCUMENTS	01/15/25

DRAWN BY: BRC JN: 24-054

EXISTING CONDITIONS /
DEMOLITION PLAN

SHEET

C100



UNITED AND TURTLE
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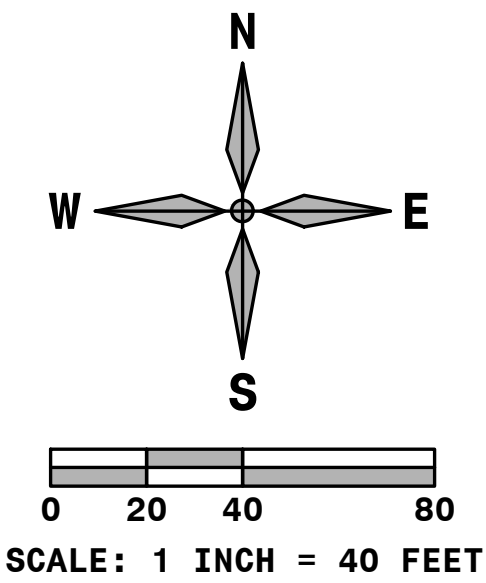
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SYMBOL LEGEND:

---	EXISTING PROPERTY LINE
---	EXISTING EASEMENT LINE
⊕	EXISTING FLARED END SECTION
⊕	EXISTING SANITARY SEWER MANHOLE
⊕	EXISTING HYDRANT
⊕	EXISTING WATER GATE VALVE
⊕	EXISTING LIGHT POLE
⊕	EXISTING POWER POLE
⊕	EXISTING ELECTRICAL PEDESTAL
⊕	EXISTING COMMUNICATIONS PEDESTAL
⊕	NEW SIGN
⊕	NEW FLARED END SECTION
⊕	NEW SANITARY MANHOLE
⊕	NEW SANITARY CLEANOUT
⊕	NEW FIRE HYDRANT
⊕	NEW GATE VALVE
⊕	NEW CURB STOP
⊕	NEW FENCE LINE
⊕	NEW BIO ROLL
⊕	NEW SILT FENCE
⊕	NEW SEEDING/HYDRO-MULCH AREA
⊕	NEW ROCK-MULCH AREA
⊕	NEW RIPRAP (NDDOT CLASS II)
⊕	PROPOSED 20' UTILITY EASEMENT

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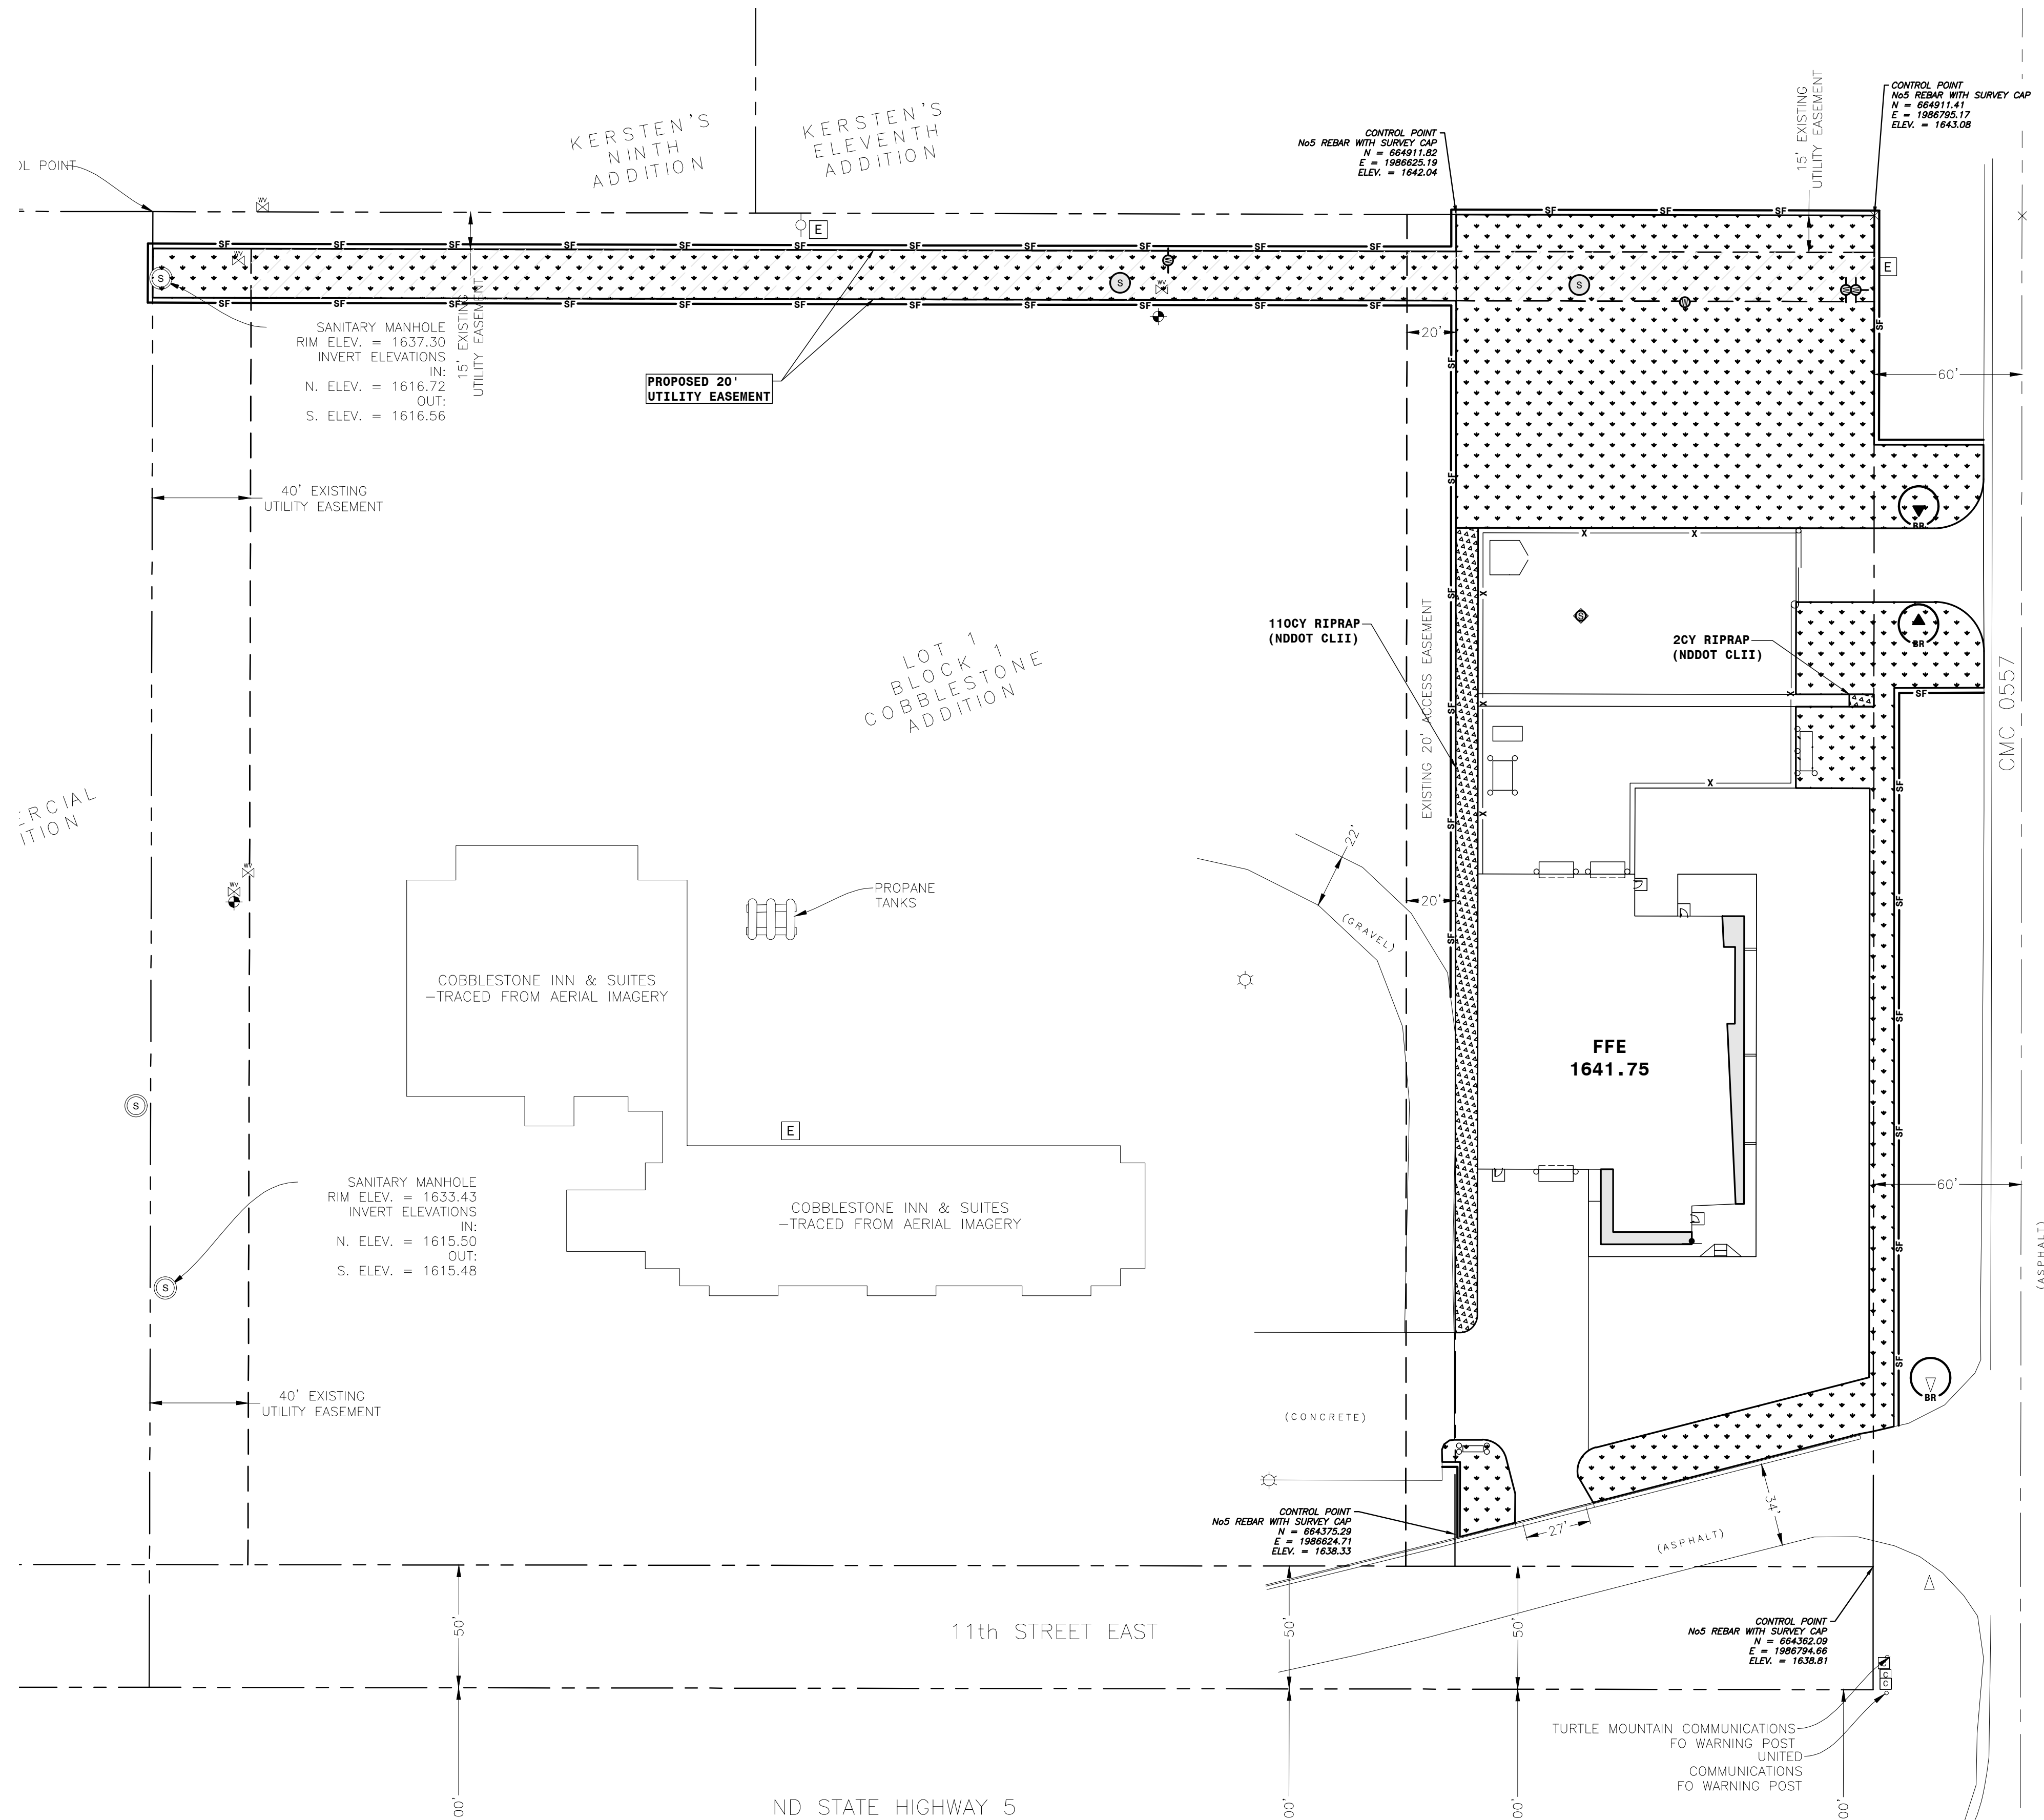
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DRAWN BY: BRC JN: 24-054

EROSION CONTROL PLAN

SHEET

C200





UNITED AND TURTLE
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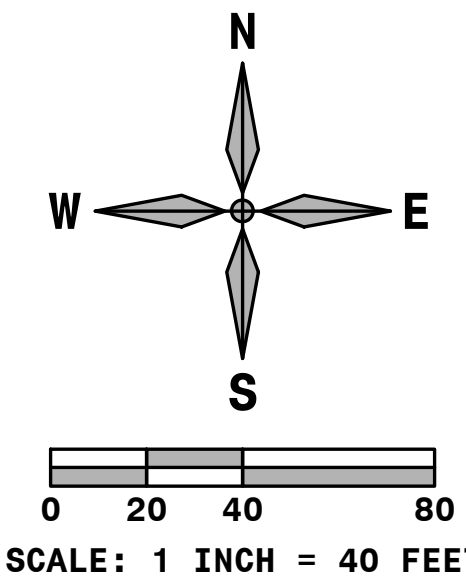
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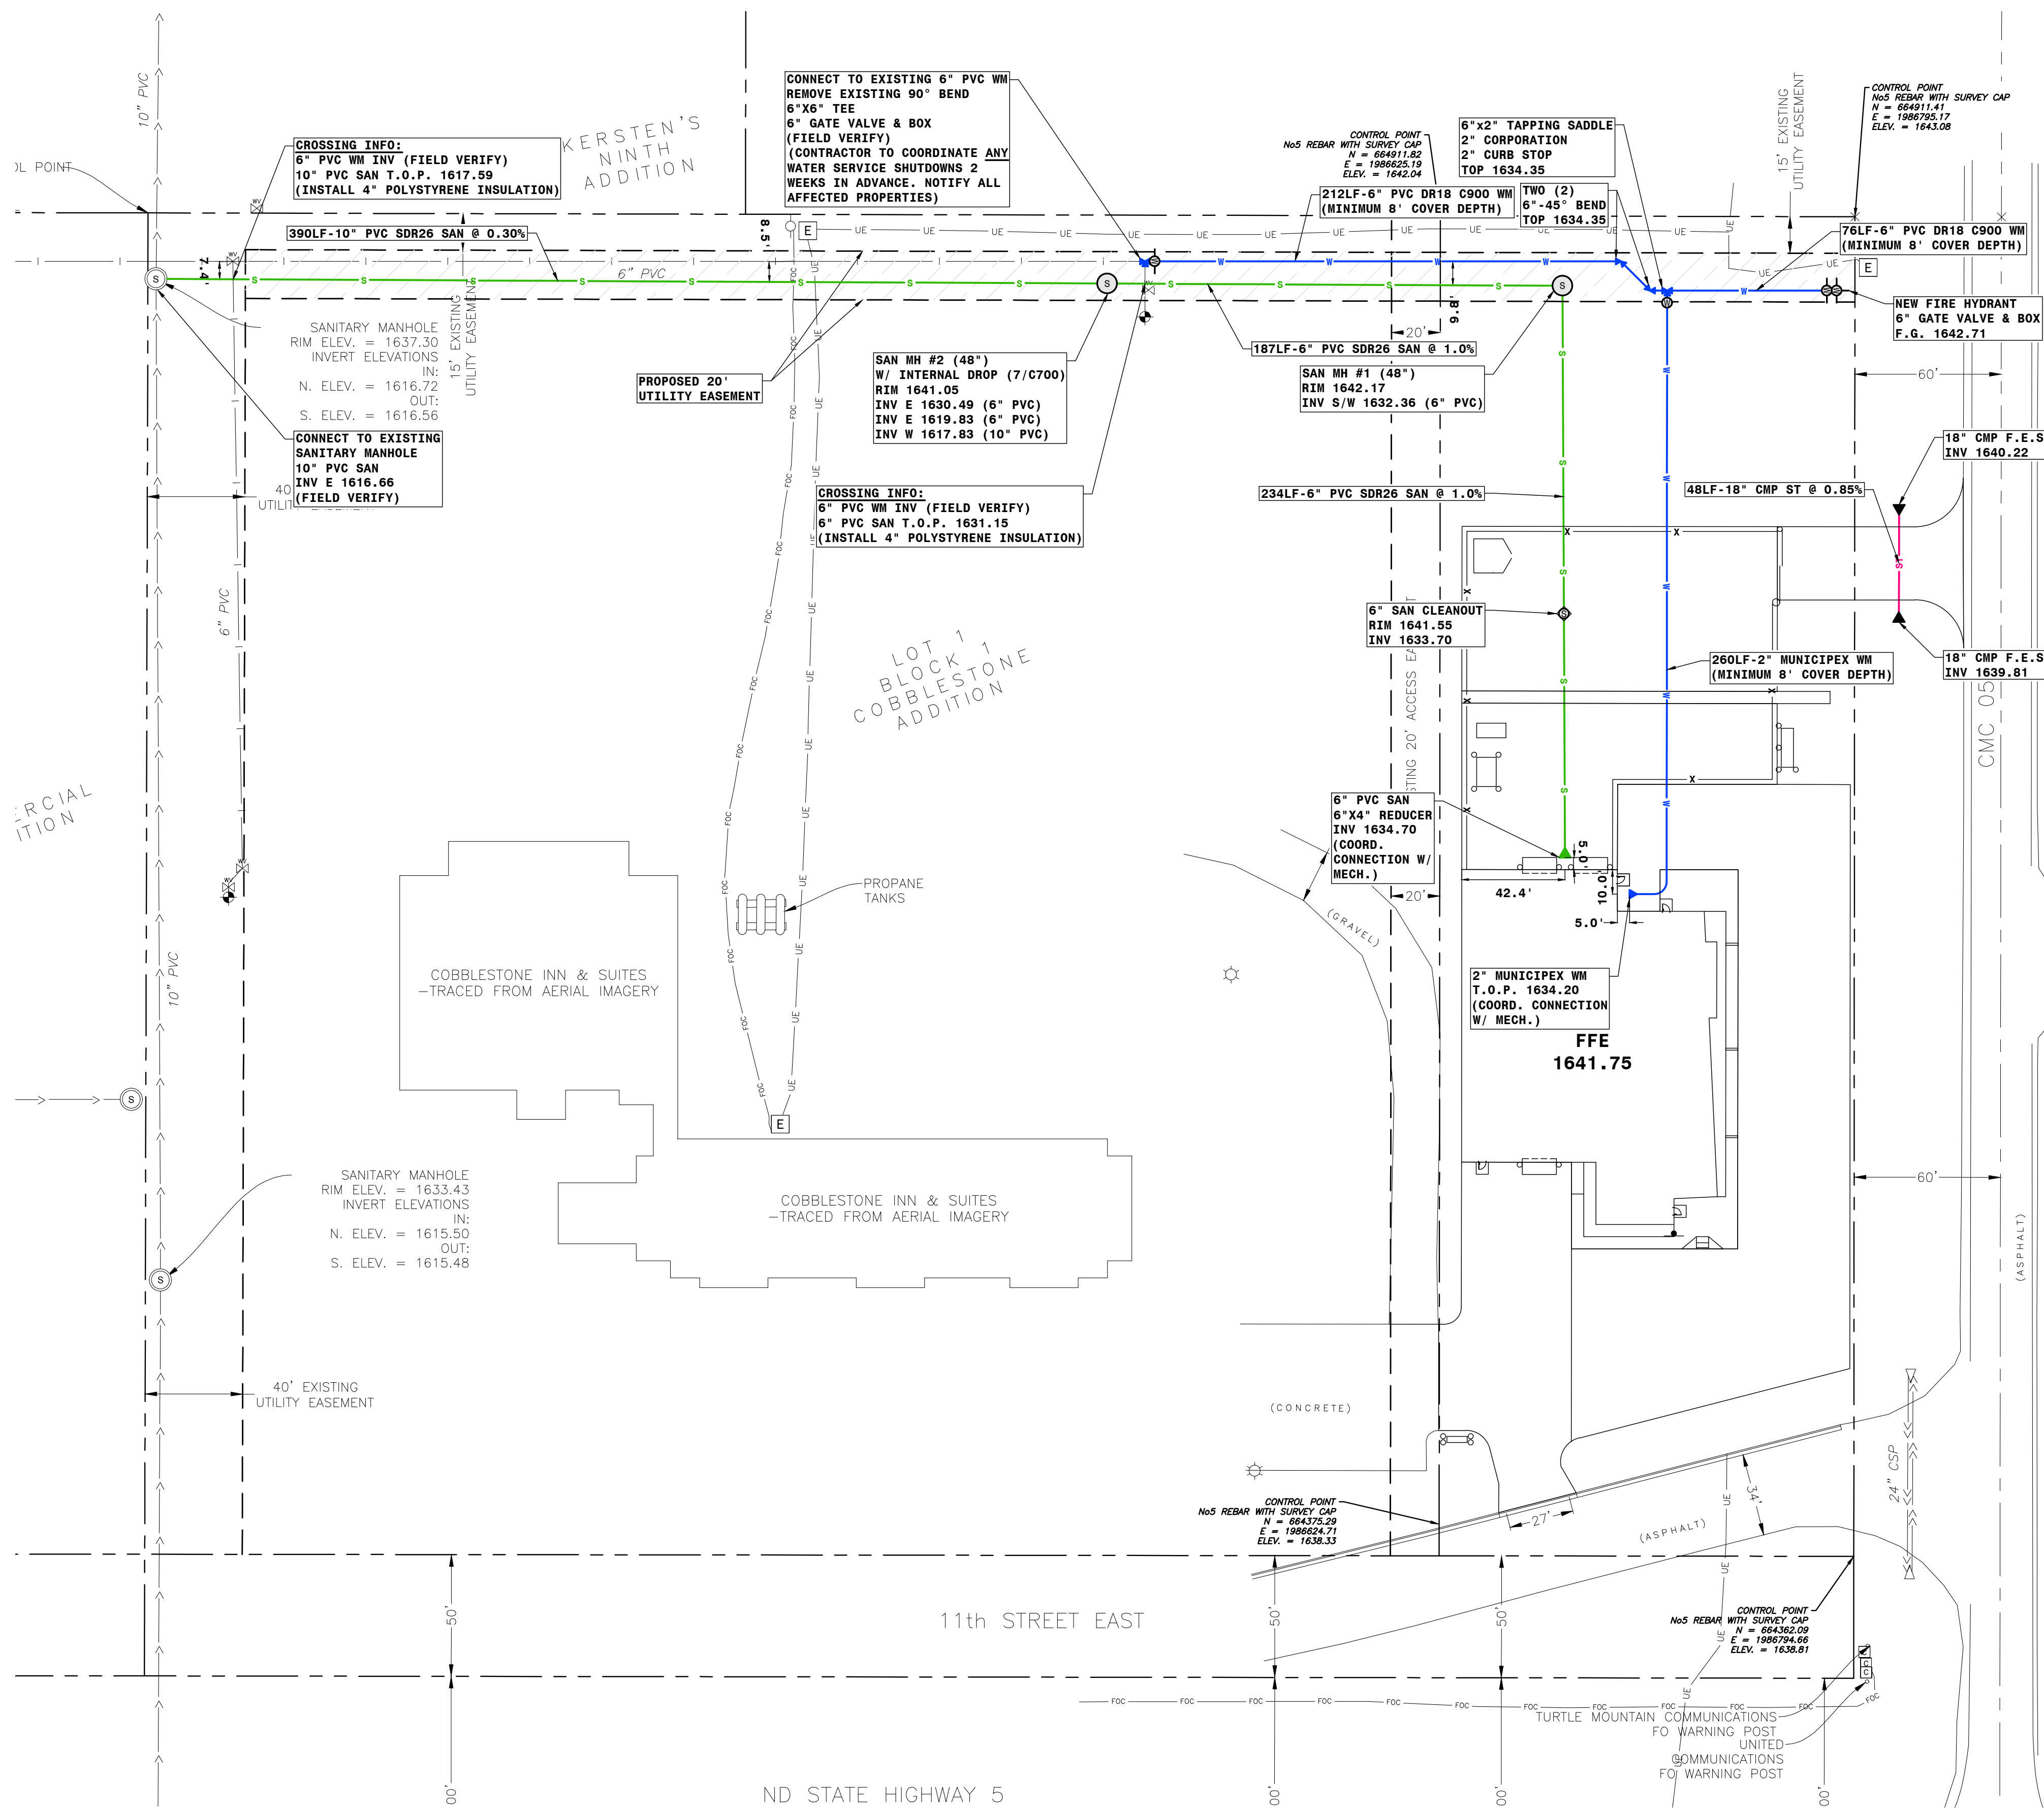
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	NEW FIRE HYDRANT
	NEW GATE VALVE
	NEW CURB STOP
	NEW FENCE LINE
	NEW STORM SEWER LINE
	NEW SANITARY SEWER LINE
	NEW WATERMAIN LINE
	PROPOSED UTILITY EASEMENT

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DISTURBED AREA:	90,404 SF



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COMMUNICATIONS: MIDCO PO BOX 5010 SIOUX FALLS, SD 57117 1-800-888-1300	ELECTRIC: NORTH CENTRAL ELECTRIC COOPERATIVE 539 11TH STREET WEST, SUITE 1 BOTTINEAU, ND 58318 800-247-1197
COMMUNICATIONS: UNITED AND TURTLE MOUNTAIN COMMUNICATIONS 538 11TH ST. WEST, SUITE 2 BOTTINEAU, ND 58318 701-228-1101	ELECTRIC: OTTERTAIL POWER COMPANY CUSTOMER SERVICE 215 SOUTH CASCADE STREET FERGUS FALLS, MN 56537
SEWER AND WATER: CITY OF BOTTINEAU - PUBLIC WORKS BUILDING 9851 COUNTY ROAD 47 BOTTINEAU, ND 58318 701-228-3620	

DRAWING HISTORY

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UTILITY PLAN

SHEET

C300



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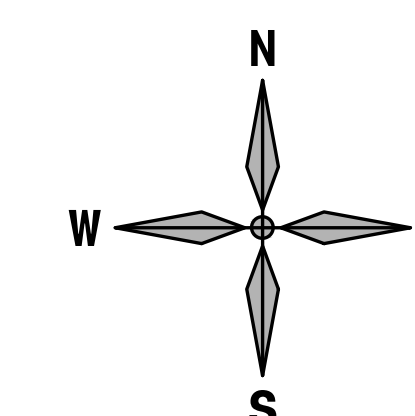
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0 20 40 80
SCALE: 1 INCH = 40 FEET

SYMBOL LEGEND:

---	EXISTING PROPERTY LINE
---	EXISTING EASEMENT LINE
---	EXISTING FLARED END SECTION
⊙	EXISTING SANITARY SEWER MANHOLE
⊕	EXISTING HYDRANT
⊗	EXISTING WATER GATE VALVE
⊛	EXISTING LIGHT POLE
⊙	EXISTING POWER POLE
⊙	EXISTING ELECTRICAL PEDESTAL
⊙	EXISTING COMMUNICATIONS PEDESTAL
---	EXISTING CONTOUR LINE
---	NEW SIGN
---	NEW FLARED END SECTION
⊙	NEW SANITARY MANHOLE
⊙	NEW SANITARY CLEANOUT
⊕	NEW FIRE HYDRANT
⊗	NEW GATE VALVE
⊙	NEW CURB STOP
x	NEW FENCE LINE
1640.50RIM	NEW RIM ELEVATION
1640.50INV	NEW INVERT ELEVATION
1640.50TP	NEW TOP OF PAVEMENT ELEVATION
1640.50G	NEW GUTTER ELEVATION
1640.50FG	NEW FINISHED GRADE ELEVATION
1640.50ME	MATCH EXISTING ELEVATION
1.00%	NEW SLOPE & DIRECTION OF FLOW
1640	NEW CONTOUR LINE
---	PROPOSED UTILITY EASEMENT

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- EXCAVATION OR OTHER WORK IN THE RIGHT-OF-WAY SHALL REQUIRE A TRAFFIC CONTROL PLAN THAT MEETS ALL MANUAL OF UNIFORM TRAFFIC CONTROL DEVICES (MUTCD) REQUIREMENTS. THIS PLAN IS REQUIRED BEFORE ANY PERMITS TO WORK IN THE RIGHT-OF-WAY WILL BE ISSUED.

SITE INFORMATION:

ADDRESS:	1109 11TH STREET E, BOTTINEAU, ND
LEGAL DESCRIPTION:	PARCEL A OF LOT 1 OF BLOCK 1 OF COBBLESTONE ADDITION TO THE CITY OF BOTTINEAU
LOT SIZE:	2.14 ACRE (93,404 SF)
ZONING:	B-2 (CENTRAL BUSINESS)
SETBACKS:	NONE (SECTION 6, 6.0409.4)
EXISTING IMPERVIOUS:	7,636 SF
EXISTING PERVIOUS:	85,768 SF
PROPOSED IMPERVIOUS:	64,224 SF
DISTURBED AREA:	90,404 SF


NO.	DESCRIPTION	DATE
1	DESIGN DOCUMENTS	01/15/25

DRAWN BY: BRC JN: 24-054

GRADING PLAN

SHEET

C400

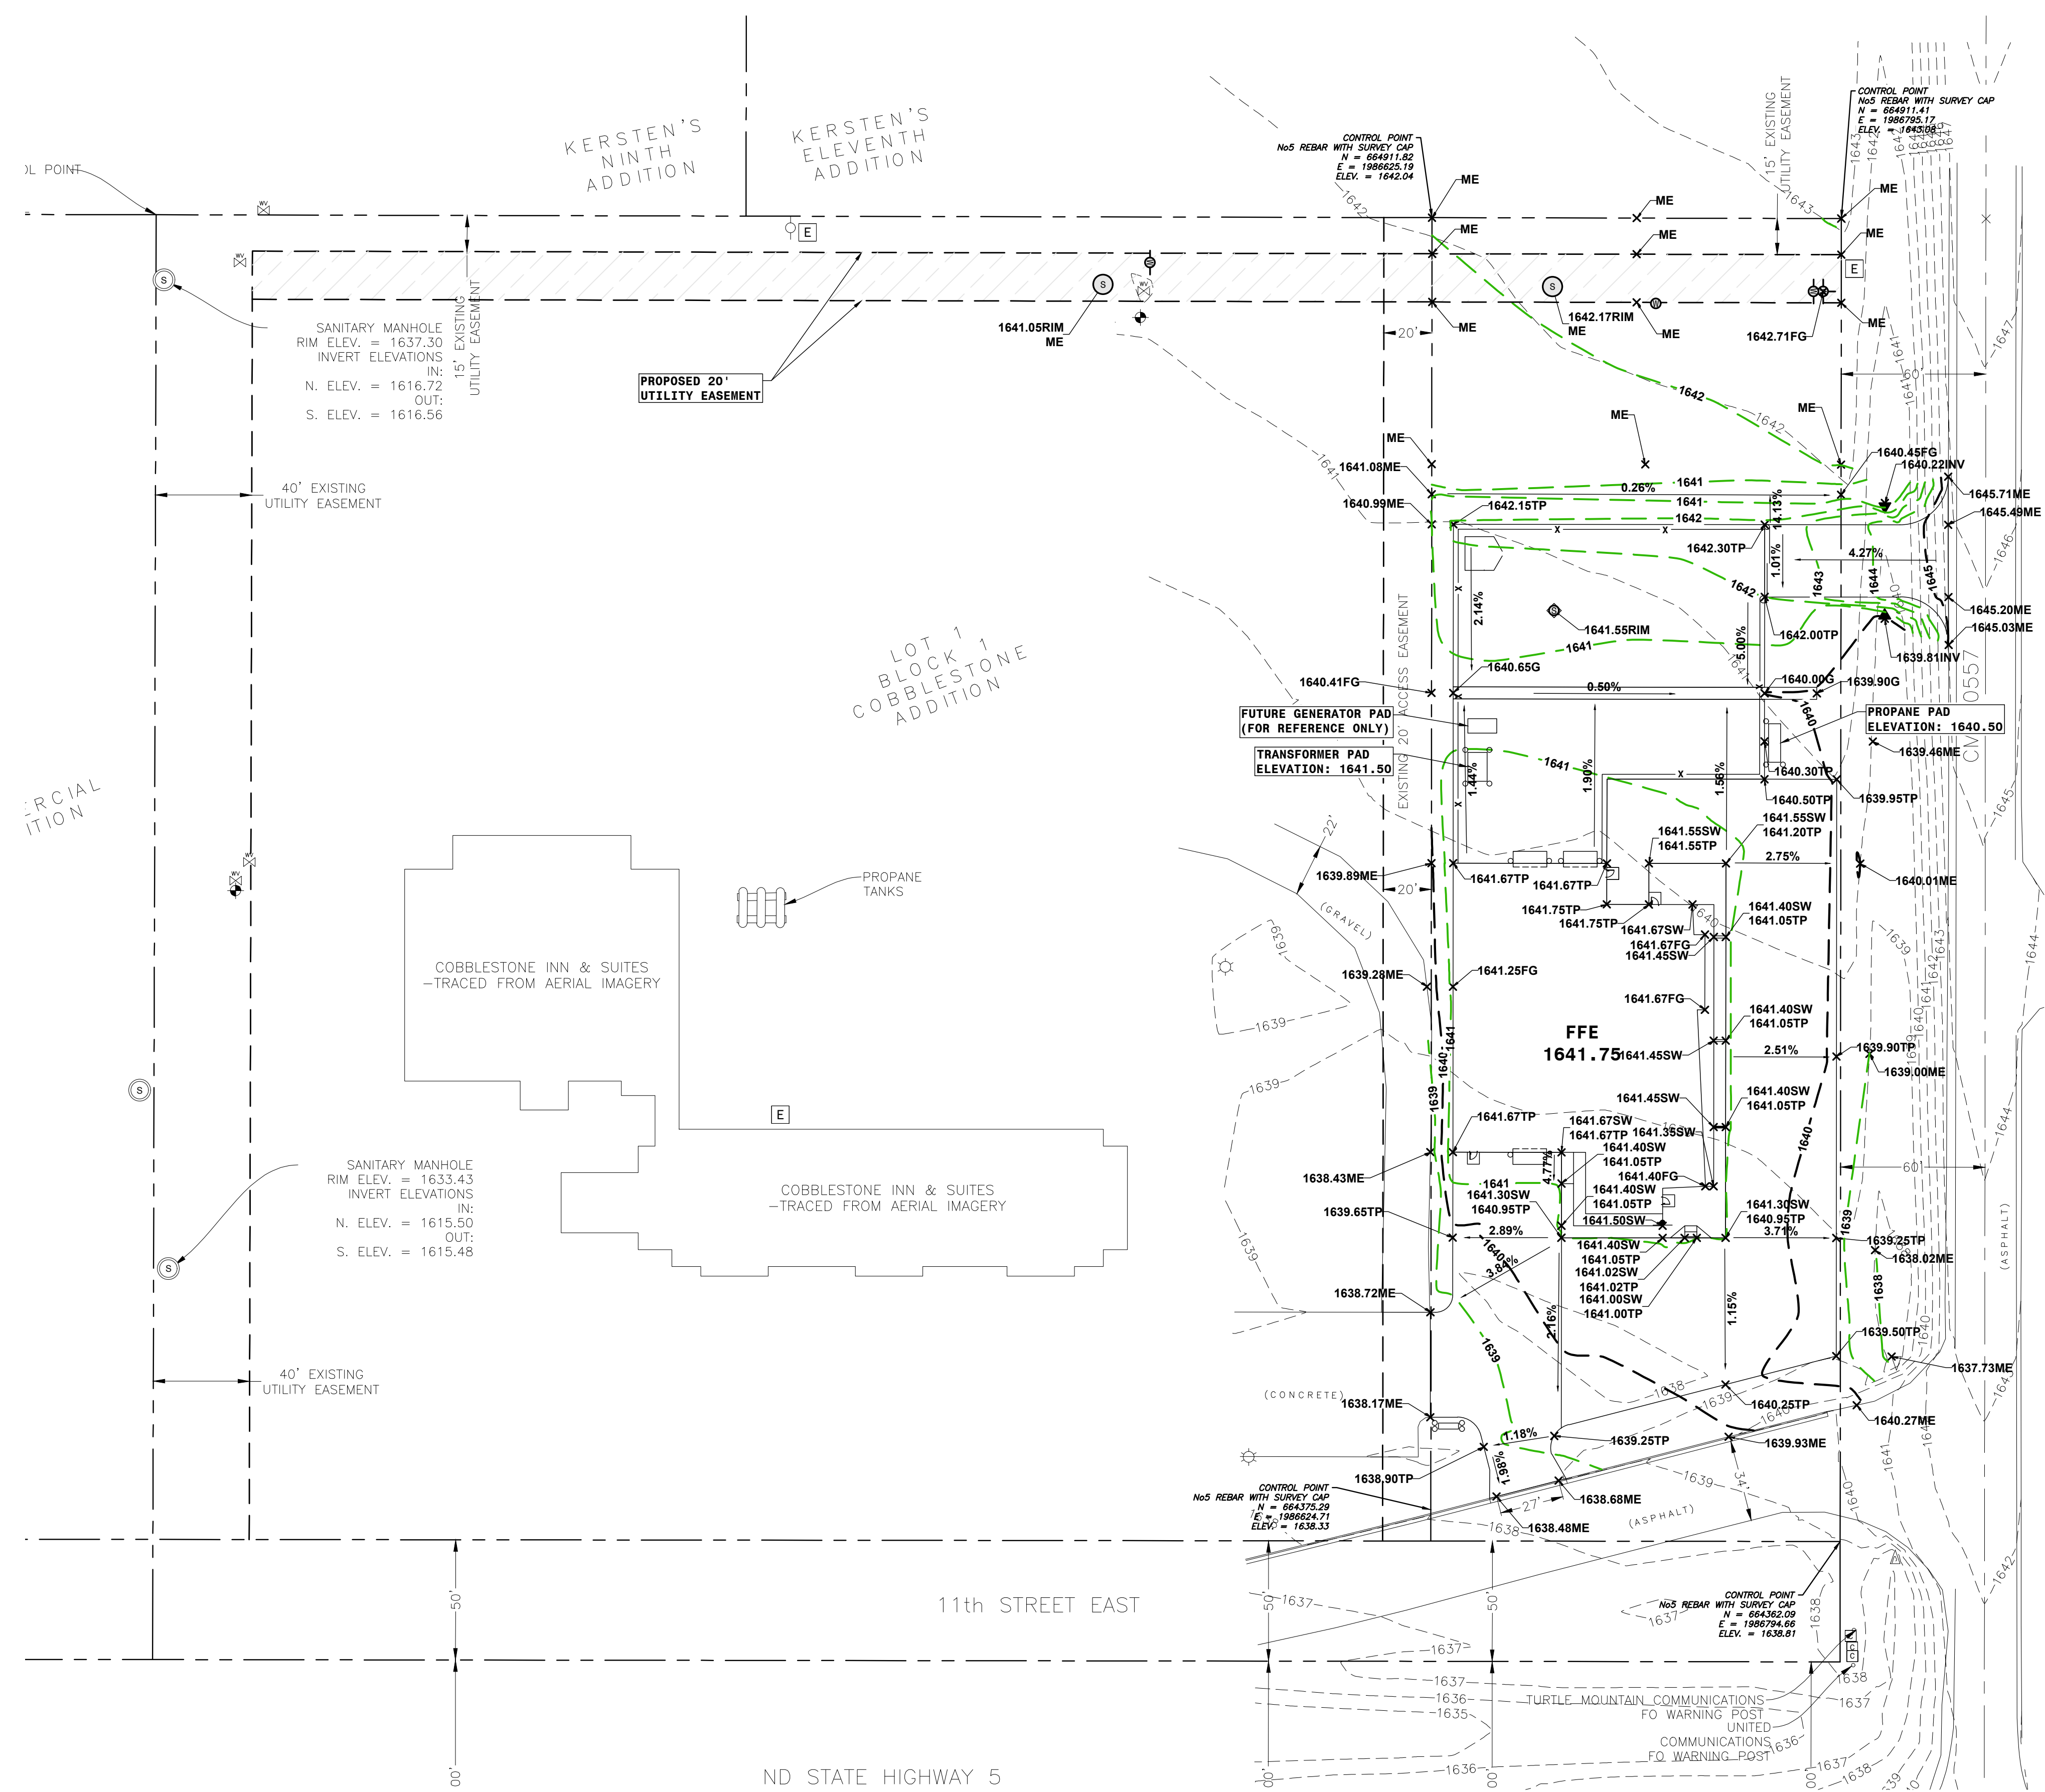

ND STATE HIGHWAY 5

TURTLE MOUNTAIN COMMUNICATIONS
FO WARNING POST
UNITED COMMUNICATIONS
FO WARNING POST


COMMERCIAL
ADDITION

SANITARY MANHOLE
RIM ELEV. = 1637.30
INVERT ELEVATIONS
IN:
N. ELEV. = 1616.72
OUT:
S. ELEV. = 1616.56

PROPOSED 20'
UTILITY EASEMENT

LOT 1
BLOCK 1
COBBLESTONE
ADDITION

COBBLESTONE INN & SUITES
-TRACED FROM AERIAL IMAGERY

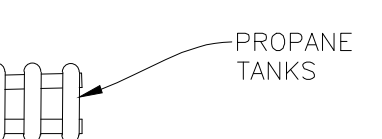

PROPANE
TANKS

SANITARY MANHOLE
RIM ELEV. = 1633.43
INVERT ELEVATIONS
IN:
N. ELEV. = 1615.50
OUT:
S. ELEV. = 1615.48

COBBLESTONE INN & SUITES
-TRACED FROM AERIAL IMAGERY

40' EXISTING
UTILITY EASEMENT

50'
00'

CONTROL POINT
NO.5 REBAR WITH SURVEY CAP
N = 664375.39
E = 198624.71
ELEV. = 1638.33

CONTROL POINT
NO.5 REBAR WITH SURVEY CAP
N = 664382.09
E = 1986794.66
ELEV. = 1638.91

CONTROL POINT
NO.5 REBAR WITH SURVEY CAP
N = 664911.41
E = 1986795.17
ELEV. = 1642.04

CONTROL POINT
NO.5 REBAR WITH SURVEY CAP
N = 664911.41
E = 1986795.17
ELEV. = 1642.04

CONTROL POINT
NO.5 REBAR WITH SURVEY CAP
N = 664911.41
E = 1986795.17
ELEV. = 1642.04



UNITED AND TURTLE
MOUNTAIN
COMMUNICATIONS
BOTTINEAU, NORTH DAKOTA

STRUCTURAL

ICON ARCHITECTURAL GROUP
222 EAST MAIN STREET, SUITE B
MANDAN, ND 58554
(701) 751-0430 OFFICE

MECHANICAL


MBN ENGINEERING, INC.
503 7TH STREET NORTH, SUITE 200
FARGO, ND 58102
(701) 478-6336 OFFICE

ELECTRICAL

MBN ENGINEERING, INC.
503 7TH STREET NORTH, SUITE 200
FARGO, ND 58102
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CIVIL

MBN ENGINEERING, INC.
503 7TH STREET NORTH, SUITE 200
FARGO, ND 58102
(701) 478-6336 OFFICE

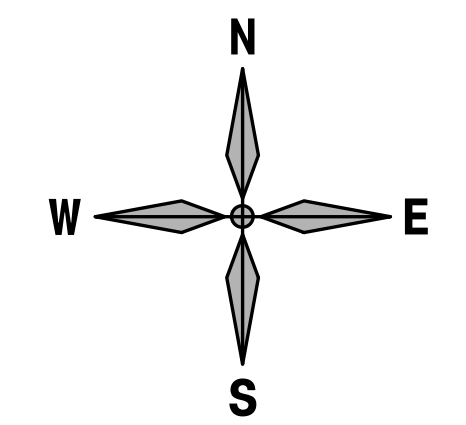

0 20 40 80
SCALE: 1 INCH = 40 FEET

SYMBOL LEGEND:

	EXISTING PROPERTY LINE
	EXISTING EASEMENT LINE
	EXISTING FLARED END SECTION
	EXISTING SANITARY SEWER MANHOLE
	EXISTING HYDRANT
	EXISTING WATER GATE VALVE
	EXISTING LIGHT POLE
	EXISTING POWER POLE
	EXISTING ELECTRICAL PEDESTAL
	EXISTING COMMUNICATIONS PEDESTAL
	NEW SIGN
	NEW FLARED END SECTION
	NEW SANITARY MANHOLE
	NEW SANITARY CLEANOUT
	NEW FIRE HYDRANT
	NEW GATE VALVE
	NEW CURB STOP
	NEW FENCE LINE
	NEW THICKENED EDGE CONCRETE SIDEWALK
	NEW 4" ASPHALT PAVEMENT (BASE BID) (SEE DETAIL X/C701)
	NEW 5" ASPHALT PAVEMENT (BASE BID) (SEE DETAIL X/C701)
	NEW 12" GRAVEL AREA
	NEW VALLEY GUTTER
	PROPOSED UTILITY EASEMENT

PLAN NOTES:

- ALL WORK SHALL COMPLY WITH THE MOST RECENT CITY OF BOTTINEAU STANDARD SPECIFICATIONS FOR CONSTRUCTION OF PUBLIC UTILITIES.
- CONTRACTOR SHALL NOTIFY UTILITY COMPANIES FOR UNDERGROUND LOCATIONS 48 HOURS PRIOR TO BEGINNING CONSTRUCTION. NORTH DAKOTA ONE CALL PHONE NUMBER: 1-800-795-0555
- CONTRACTOR SHALL PROTECT ALL PROPERTY PINS. PROPERTY PINS DESTROYED OR DISTURBED SHALL BE REPLACED AT CONTRACTORS EXPENSE.
- CONTRACTOR SHALL MAINTAIN TEMPORARY EROSION CONTROL UNTIL PERMANENT EROSION CONTROL IS ESTABLISHED.
- CONTRACTOR SHALL ACQUIRE AN EROSION SEDIMENT CONTROL (ESC) PERMIT FROM THE CITY OF BOTTINEAU PRIOR TO START OF CONSTRUCTION.
- IF THE LAND BOUNDARY DENOTED ON THE PLANS ENCOMPASSES ONE (1) ACRE OR MORE, A GENERAL PERMIT FOR THE AUTHORIZATION TO DISCHARGE STORM WATER ASSOCIATED WITH CONSTRUCTION ACTIVITY UNDER NATIONAL POLLUTANT DISCHARGE ELIMINATION SYSTEM/STATE DISPOSAL SYSTEM (NPDES/SDS) PERMIT SHALL BE ACQUIRED BY THE CONTRACTOR AND OWNER FROM THE NORTH DAKOTA DEPARTMENT OF ENVIRONMENTAL QUALITY A MINIMUM OF SEVEN (7) DAYS PRIOR TO CONSTRUCTION.
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ZONING:	B-2 (CENTRAL BUSINESS)
SETBACKS:	NONE (SECTION 6, 6.0409.4)
EXISTING IMPERVIOUS:	7,636 SF
EXISTING PERVIOUS:	85,768 SF
PROPOSED IMPERVIOUS:	64,224 SF
DISTURBED AREA:	90,404 SF

DRAWING HISTORY


NO.	DESCRIPTION	DATE
1	DESIGN DOCUMENTS	01/15/25

DRAWN BY: BRC JN: 24-054

PAVING PLAN

SHEET

C500

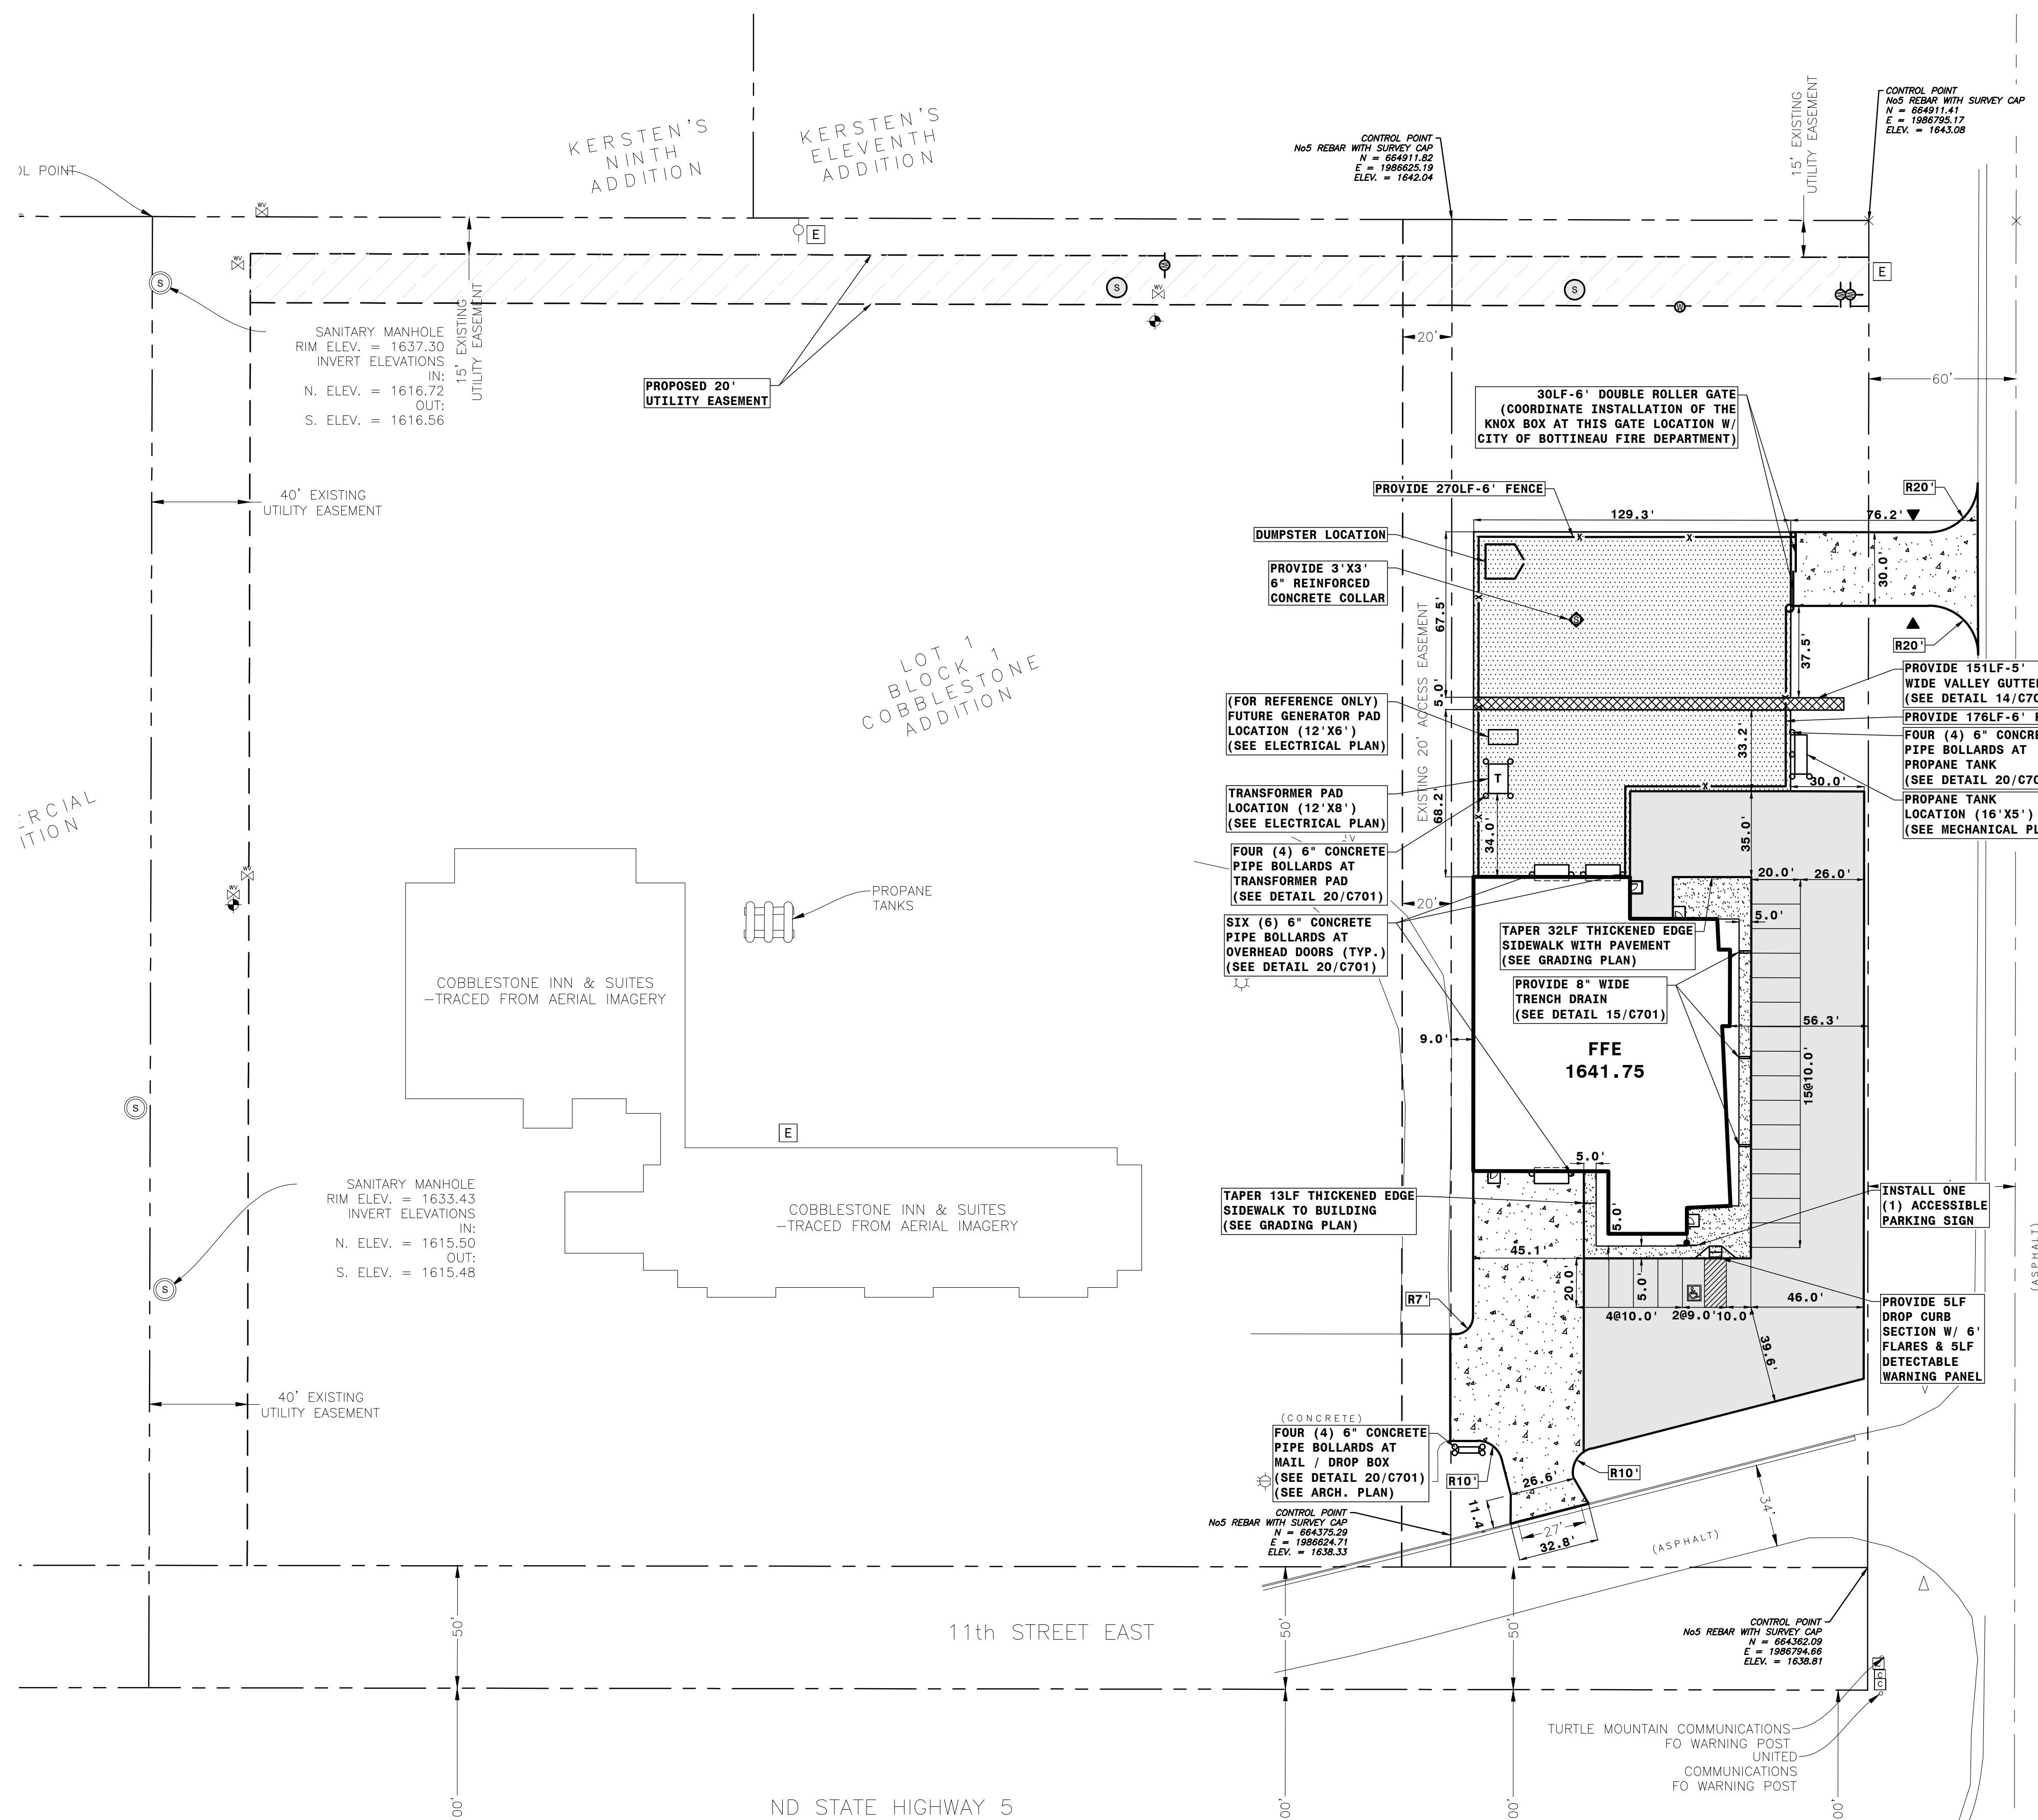

ARCIAL
ITION

COBBLESTONE INN & SUITES
-TRACED FROM AERIAL IMAGERY

PROPANE
TANKS

COBBLESTONE INN & SUITES
-TRACED FROM AERIAL IMAGERY

ND STATE HIGHWAY 5

TURTLE MOUNTAIN COMMUNICATIONS
FO WARNING POST
UNITED
COMMUNICATIONS
FO WARNING POST



UNITED AND TURTLE
MOUNTAIN
COMMUNICATIONS
BOTTINEAU, NORTH DAKOTA

STRUCTURAL

ICON ARCHITECTURAL GROUP
222 EAST MAIN STREET, SUITE B
MANDAN, ND 58554
(701) 751-0430 OFFICE

MECHANICAL


MBN ENGINEERING, INC.
503 7TH STREET NORTH, SUITE 200
FARGO, ND 58102
(701) 478-6336 OFFICE

ELECTRICAL

MBN ENGINEERING, INC.
503 7TH STREET NORTH, SUITE 200
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CIVIL

MBN ENGINEERING, INC.
503 7TH STREET NORTH, SUITE 200
FARGO, ND 58102
(701) 478-6336 OFFICE

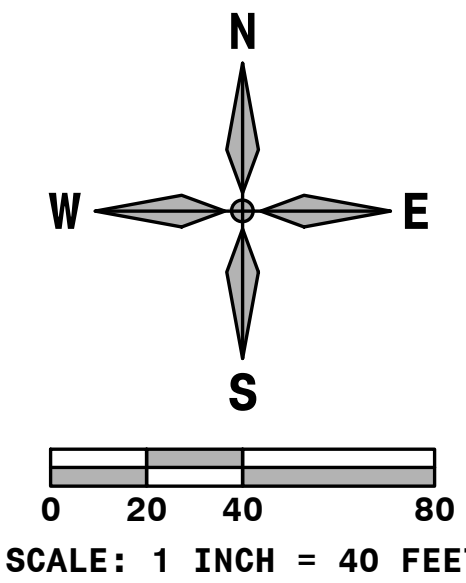

SYMBOL LEGEND:

	EXISTING PROPERTY LINE
	EXISTING EASEMENT LINE
	EXISTING FLARED END SECTION
	EXISTING SANITARY SEWER MANHOLE
	EXISTING HYDRANT
	EXISTING WATER GATE VALVE
	EXISTING LIGHT POLE
	EXISTING POWER POLE
	EXISTING ELECTRICAL PEDESTAL
	EXISTING COMMUNICATIONS PEDESTAL
	NEW SIGN
	NEW FLARED END SECTION
	NEW SANITARY MANHOLE
	NEW SANITARY CLEANOUT
	NEW FIRE HYDRANT
	NEW GATE VALVE
	NEW CURB STOP
	NEW FENCE LINE
	NEW 5" REINFORCED CONCRETE PAVEMENT (ALTERNATE) (SEE DETAIL X/C701)
	NEW 6" REINFORCED CONCRETE PAVEMENT (ALTERNATE) (SEE DETAIL X/C701)
	NEW TIED CONSTRUCTION JOINT
	NEW CONSTRUCTION JOINT
	NEW ISOLATION JOINT
	PROPOSED UTILITY EASEMENT

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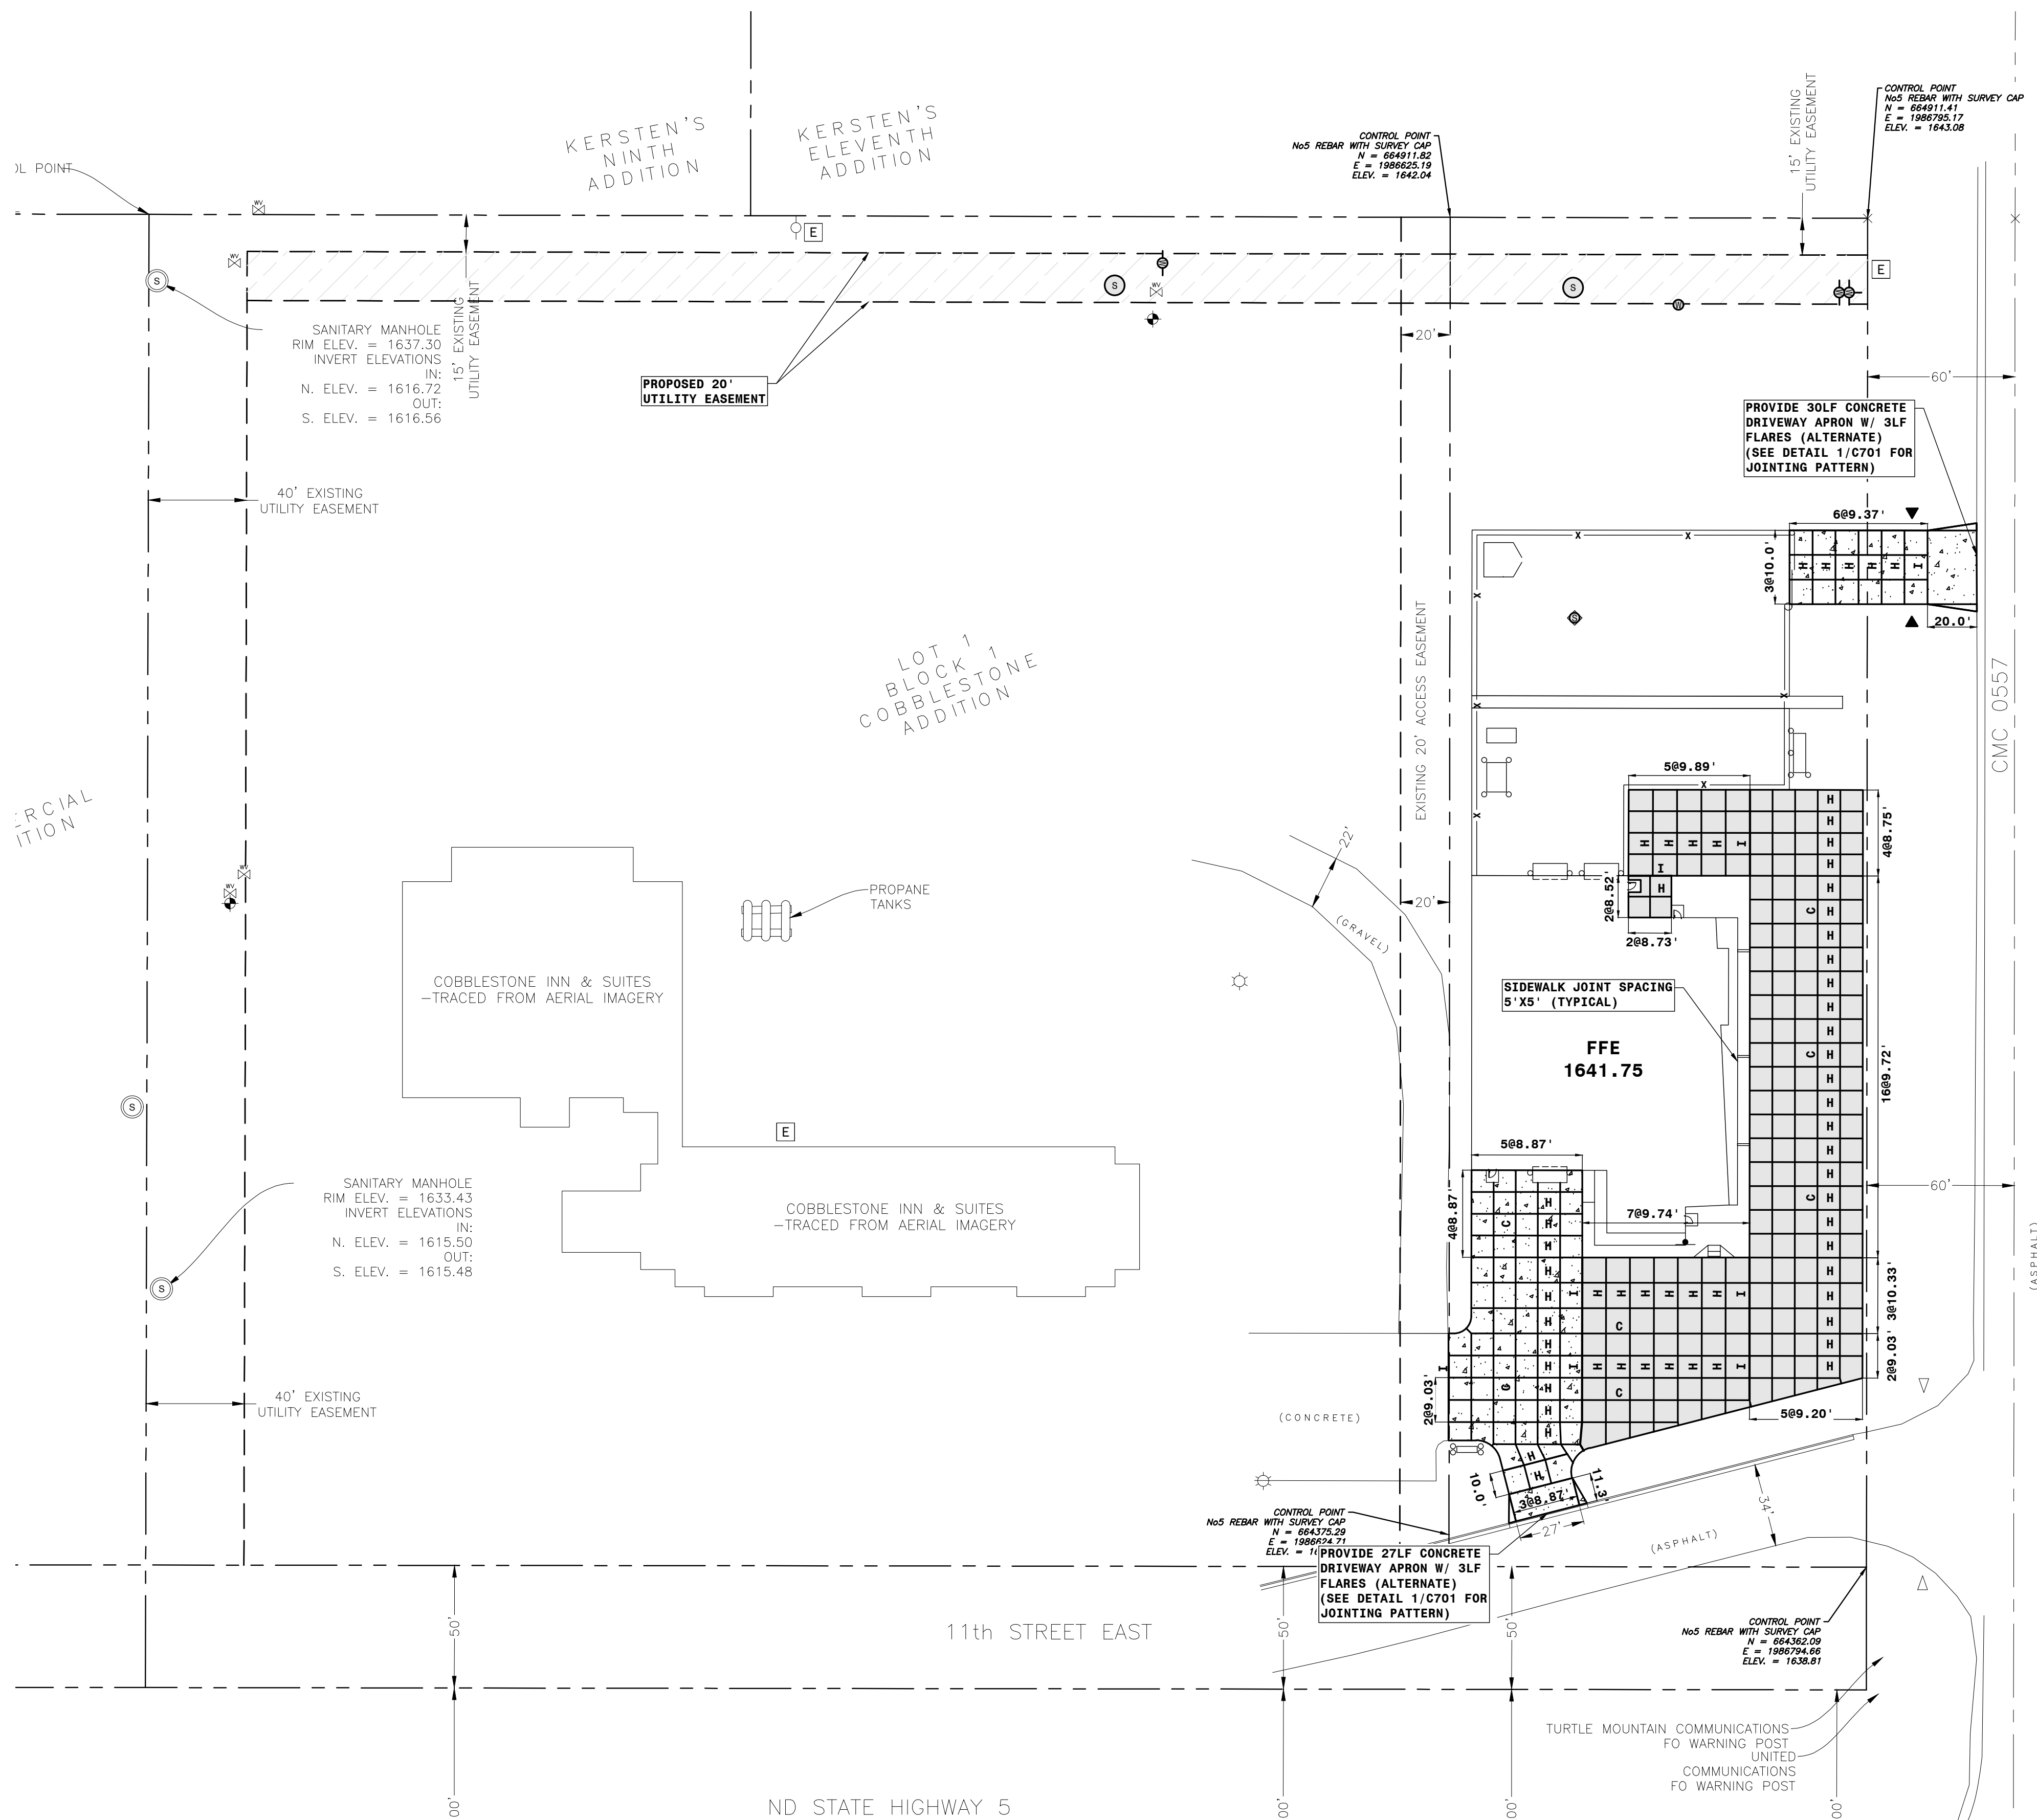
DRAWING HISTORY		
NO.	DESCRIPTION	DATE
1	DESIGN DOCUMENTS	01/15/25

DRAWN BY: BRC JN: 24-054

JOINING PLAN

SHEET

C600





STRUCTURAL

ICON ARCHITECTURAL GROUP
222 EAST MAIN STREET, SUITE B
MANDAN, ND 58554
(701) 751-0430 OFFICE

MECHANICAL


MBN ENGINEERING, INC.
503 7TH STREET NORTH, SUITE 200
FARGO, ND 58102
(701) 478-6336 OFFICE

ELECTRICAL


MBN ENGINEERING, INC.
503 7TH STREET NORTH, SUITE 200
FARGO, ND 58102
(701) 478-6336 OFFICE

CIVIL

MBN ENGINEERING, INC.
503 7TH STREET NORTH, SUITE 200
FARGO, ND 58102
(701) 478-6336 OFFICE

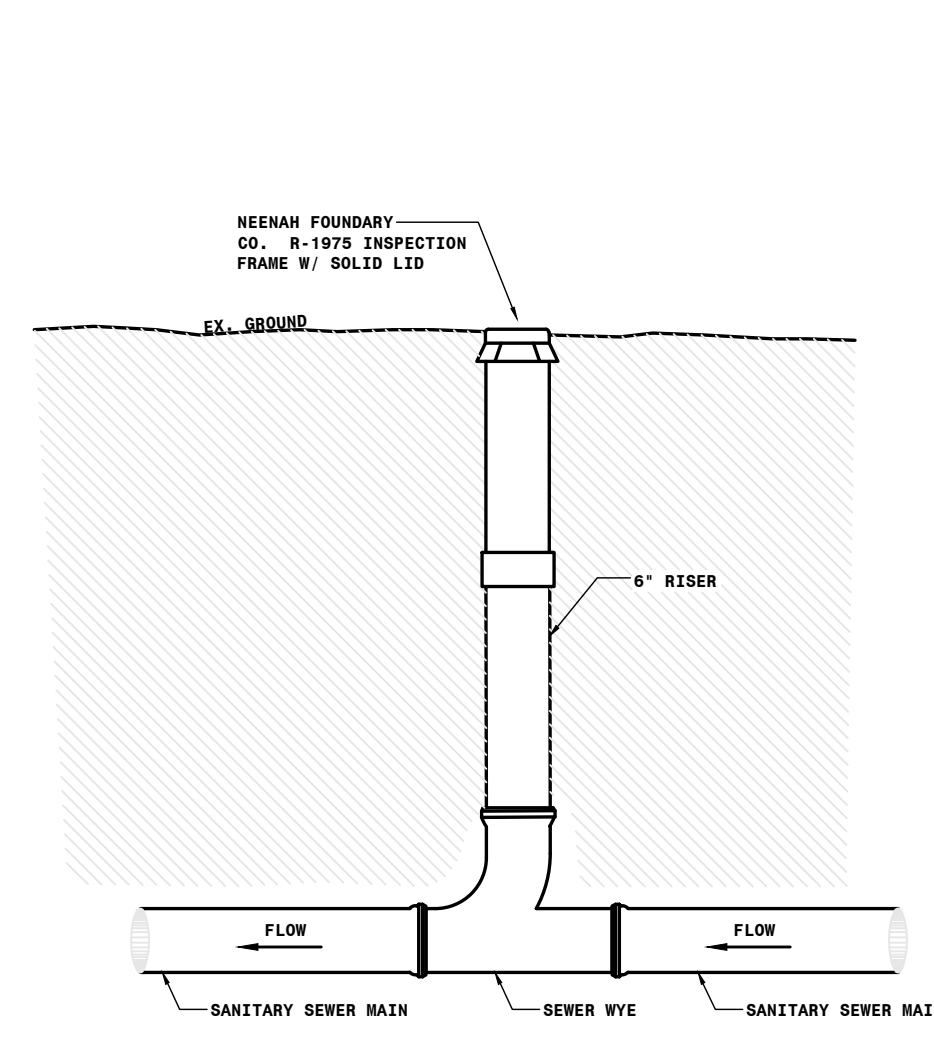

1 SANITARY SEWER CLEANOUT STANDARD DETAIL
C700 NOT-TO-SCALE

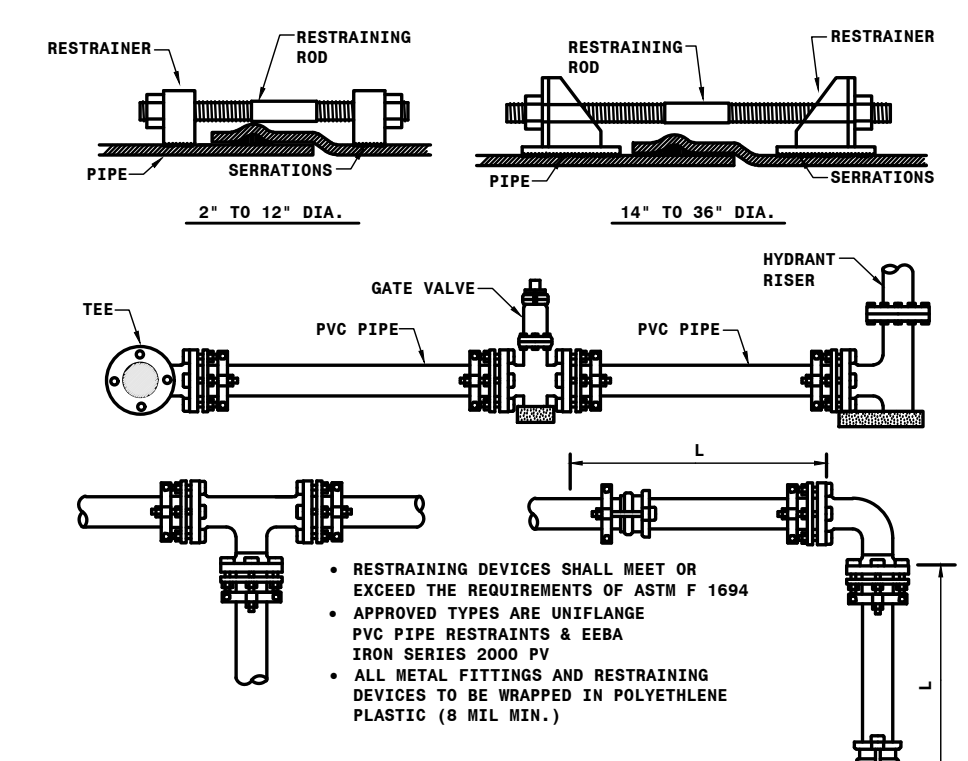

TYPICAL INSTALLATIONS
RESTRAINED LENGTHS OF PVC PIPE

PIPE SIZE (IN)	90° BEND (L)	45° BEND (L)	22.5° BEND (L)	11.25° BEND (L)	SIZE ON VALVE/TEE (L)	DEAD-END (L)
8"	12"	8"	5"	3"	3"	33"
10"	15"	10"	6"	4"	4"	45"
12"	18"	12"	8"	5"	5"	57"
16"	24"	16"	10"	6"	6"	75"

NOTE: ADDITIONAL LENGTH OF PIPE TO BE RESTRAINED ON EACH SIDE OF ANY RESTRAINED FITTINGS (SEE TABLE)

SIZE	45° VERT. OFFSET* (L)	22.5° VERT. OFFSET* (L)
6"	18"/8"	7"/4"
8"	18"/11"	9"/5"
10"	23"/13"	11"/6"
12"	27"/15"	13"/7"
16"	35"/20"	17"/10"

* FIRST NUMBER IS THE RECOMMENDED RESTRAINED LENGTH ON EACH SIDE OF THE DOWN BEND; THE SECOND NUMBER IS THE LENGTH FOR EACH SIDE OF THE UP BEND.

2 RESTRAINT DEVICE FOR PVC PIPE BELL JOINTS DETAIL
C700 NOT-TO-SCALE



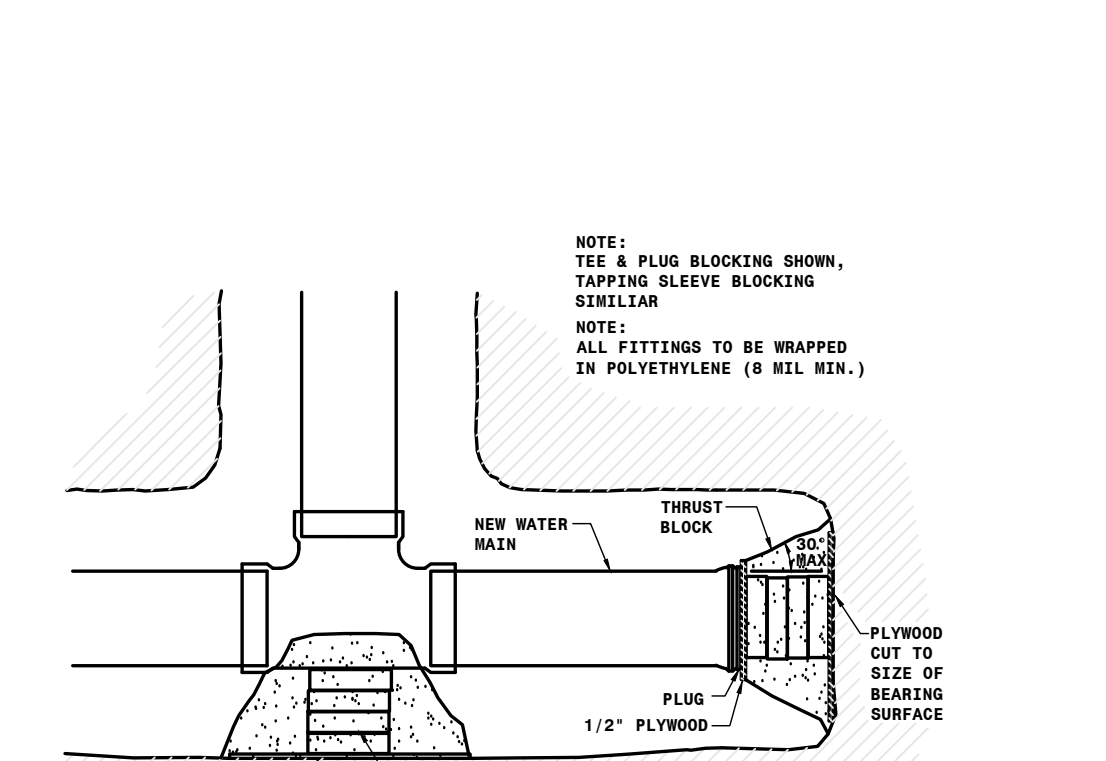


TABLE OF REQUIRED BEARING AREAS


PIPE SIZE	90° BEND	45° BEND	22.5° BEND	11.25° BEND	1 1/4" TEE
4"	2' 0"	2' 0"	2' 0"	2' 0"	2' 0"
6"	3' 0"	2' 0"	2' 0"	2' 0"	3' 0"
8"	4' 0"	3' 0"	2' 0"	2' 0"	4' 0"
10"	5' 0"	4' 0"	3' 0"	2' 0"	5' 0"
12"	6' 0"	5' 0"	4' 0"	3' 0"	6' 0"
16"	8' 0"	7' 0"	6' 0"	5' 0"	8' 0"
18"	9' 0"	8' 0"	7' 0"	6' 0"	9' 0"

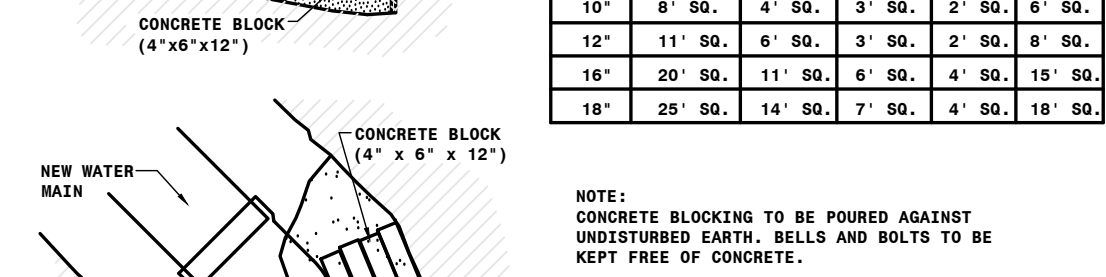


3 WATER MAIN THRUST BLOCKING DETAIL
C700 NOT-TO-SCALE

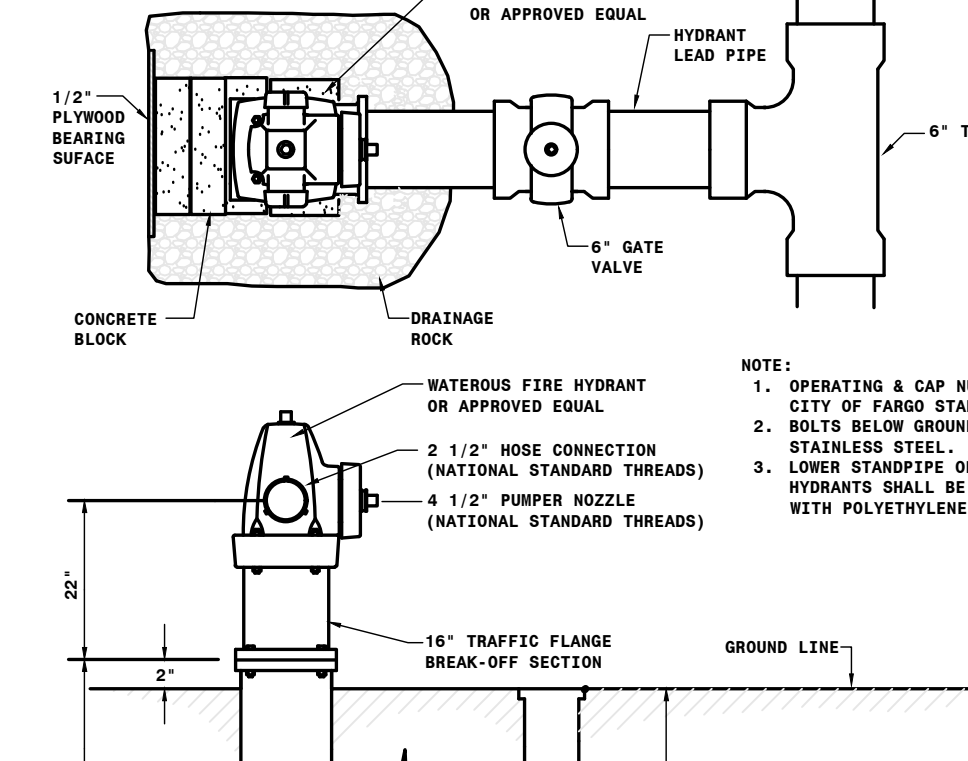


4 WATER MAIN HYDRANT DETAIL
C700 NOT-TO-SCALE

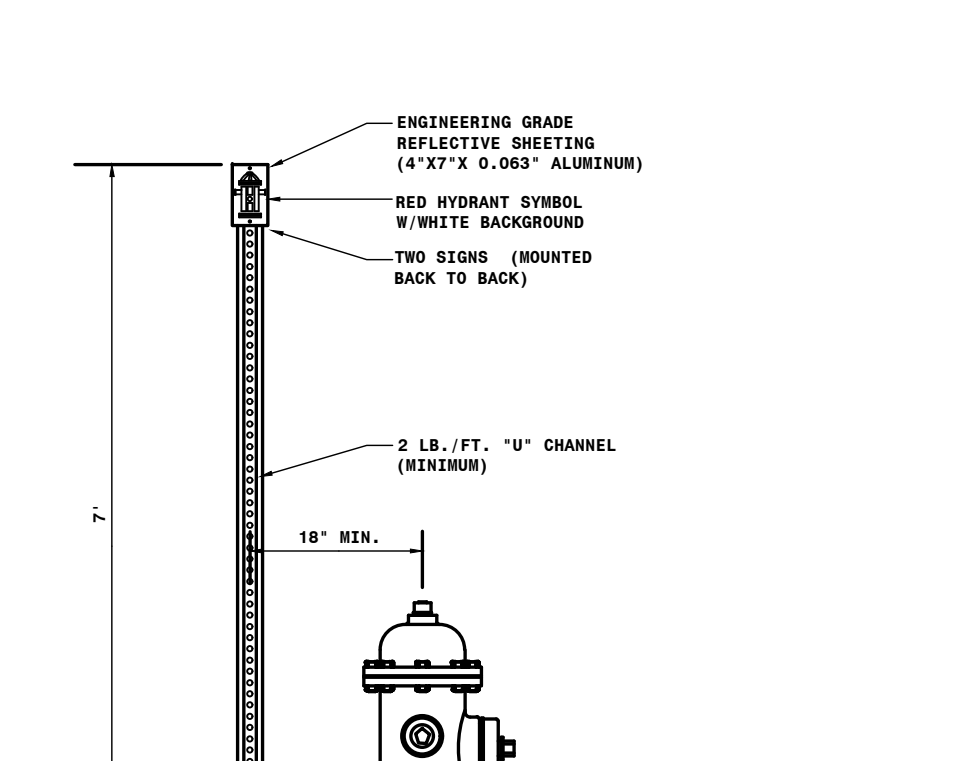


5 HYDRANT MARKER DETAIL
C700 NOT-TO-SCALE

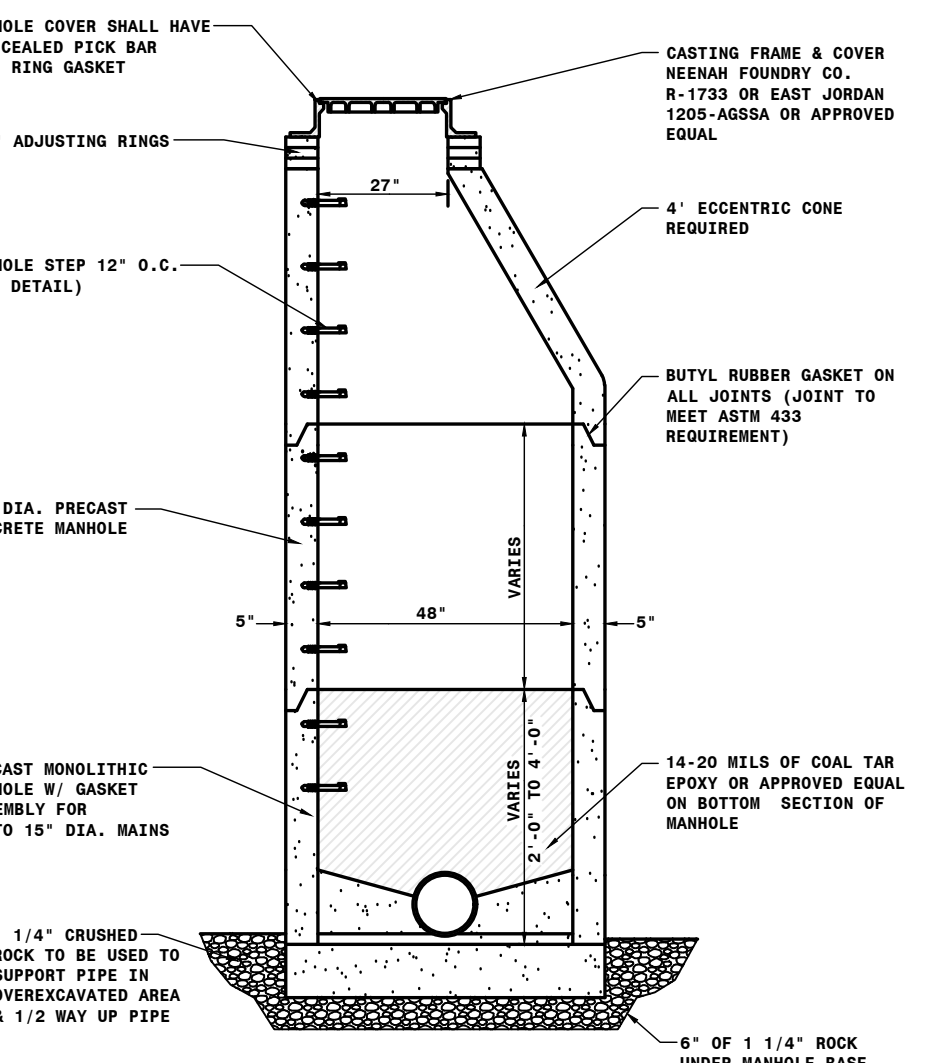


6 SANITARY SEWER MANHOLE (48") DETAIL
C700 NOT-TO-SCALE

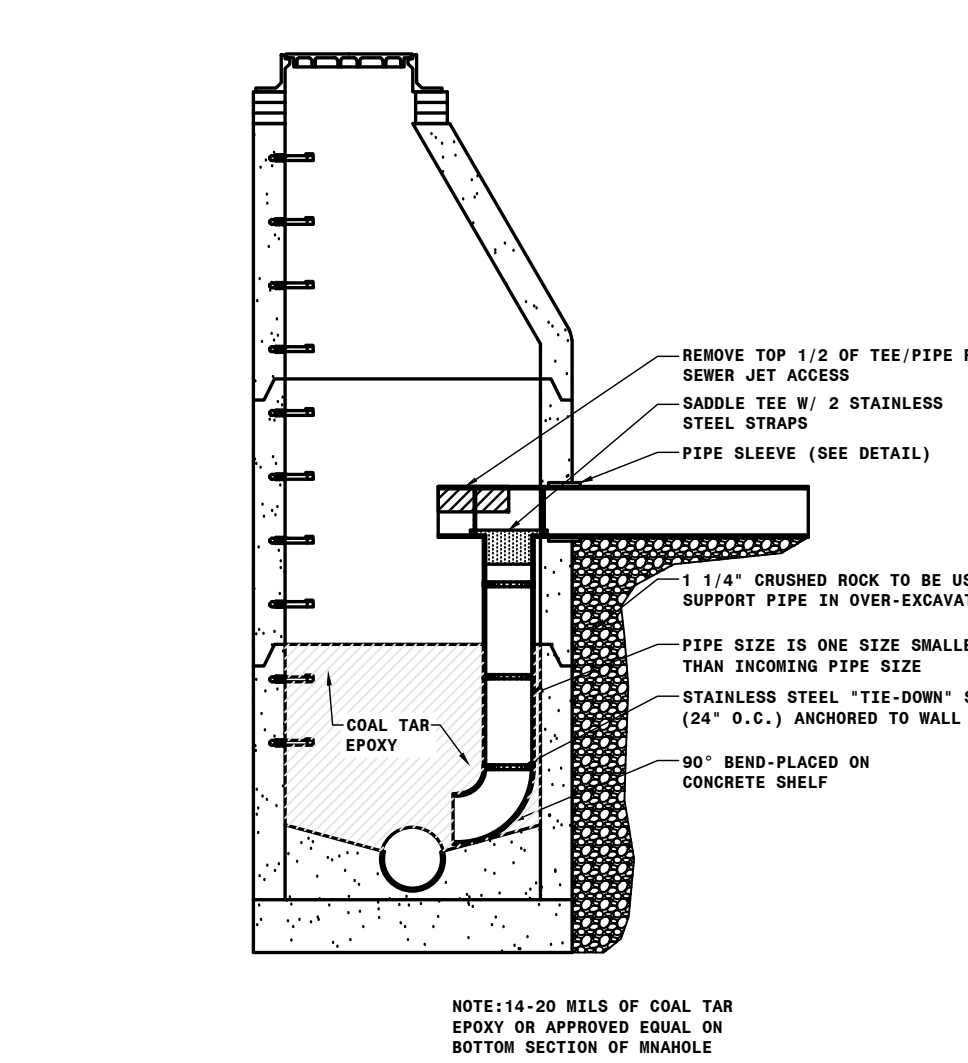


7 SANITARY SEWER MANHOLE (INTERIOR DROP CONNECTION) DETAIL
C700 NOT-TO-SCALE

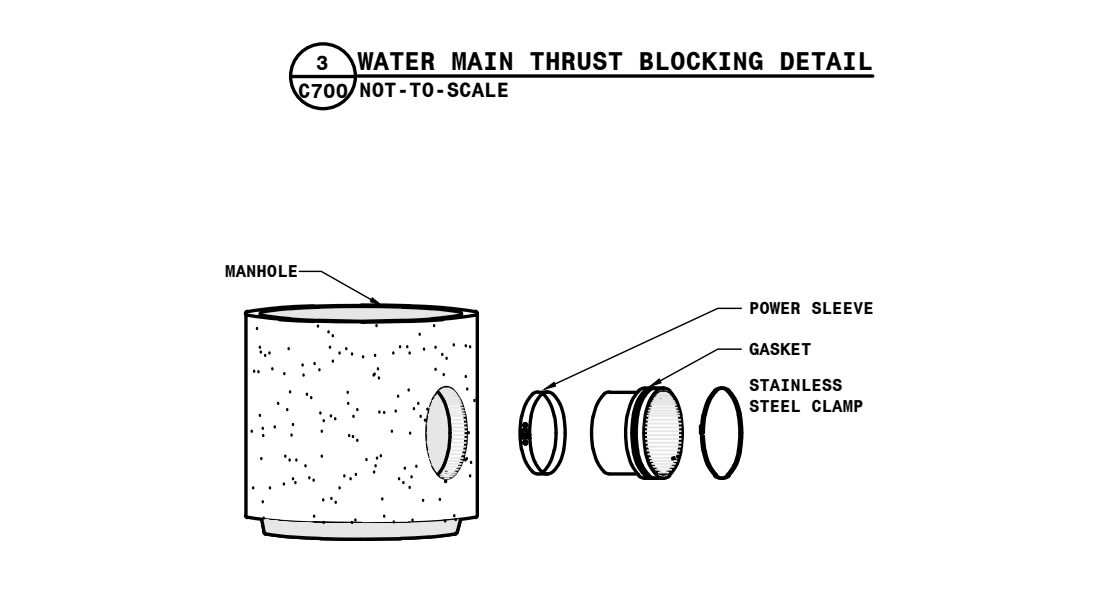


8 PIPE SLEEVE DETAIL
C700 NOT-TO-SCALE

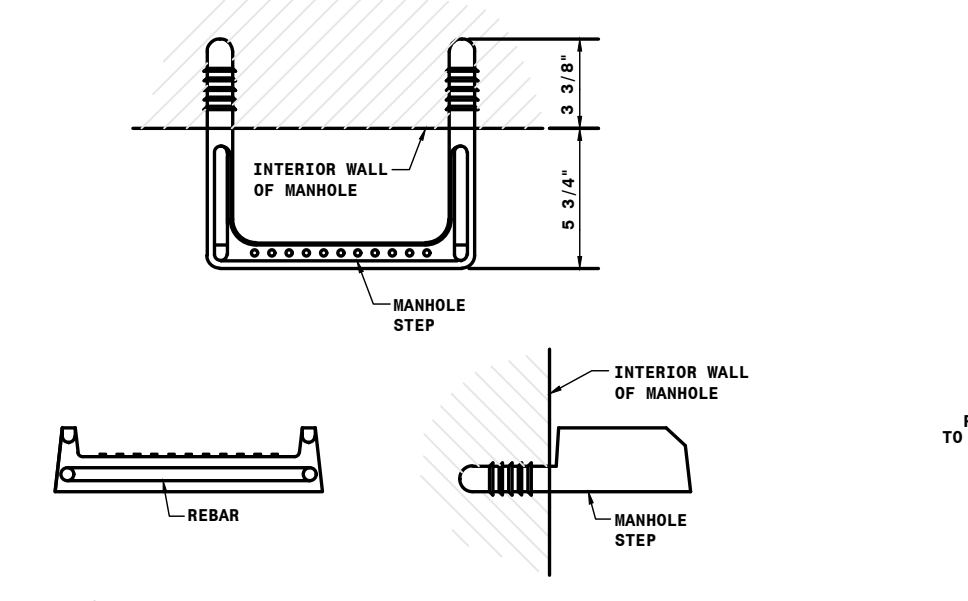


9 MANHOLE STEP DETAIL
C700 NOT-TO-SCALE

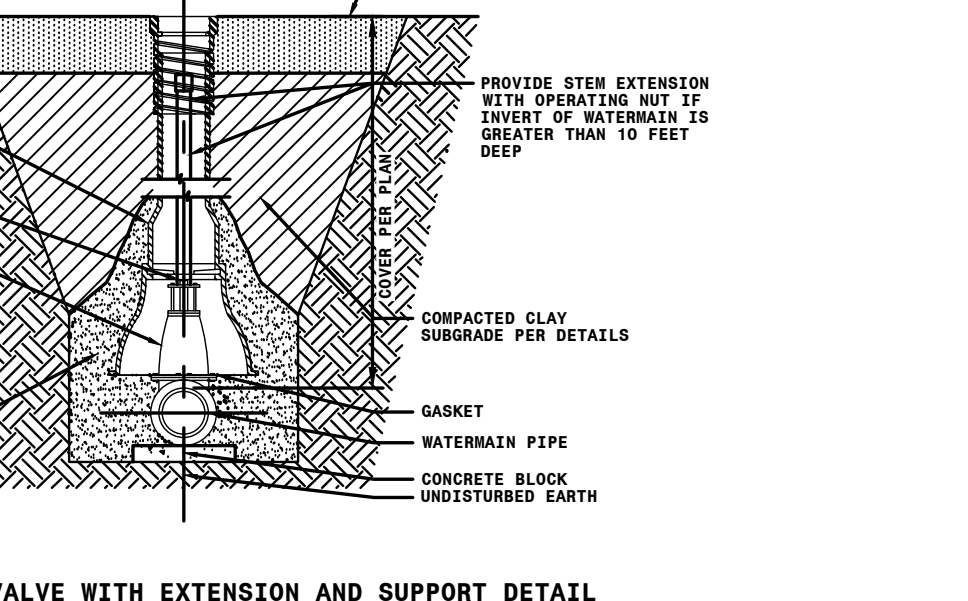


10 GATE VALVE WITH EXTENSION AND SUPPORT DETAIL
C700 NOT-TO-SCALE

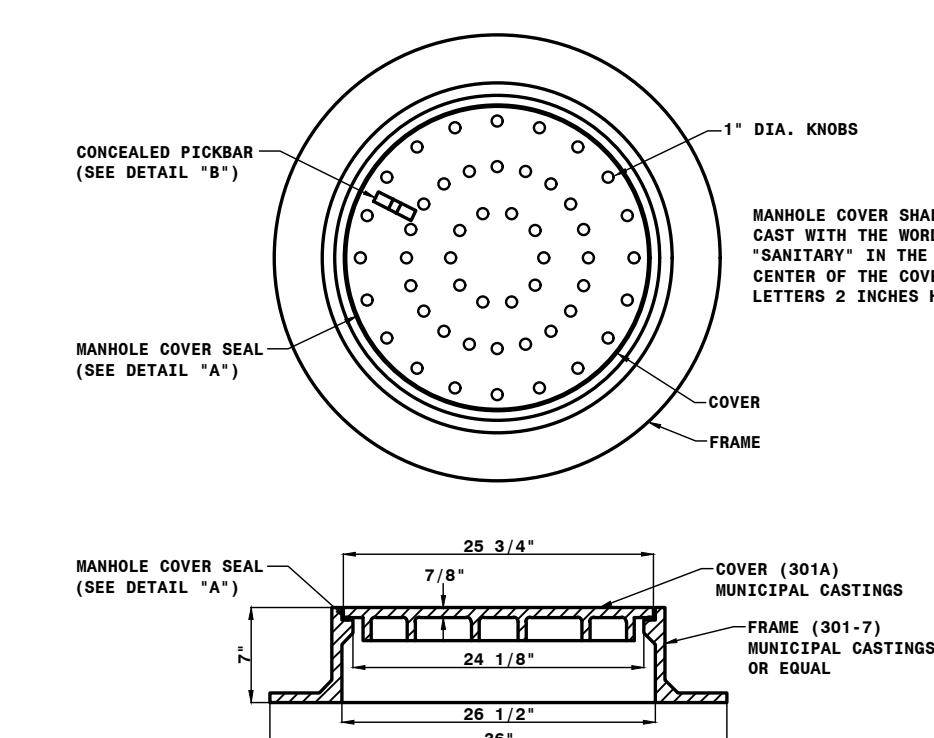


12 SANITARY MANHOLE COVER CASTING DETAIL
C700 NOT-TO-SCALE

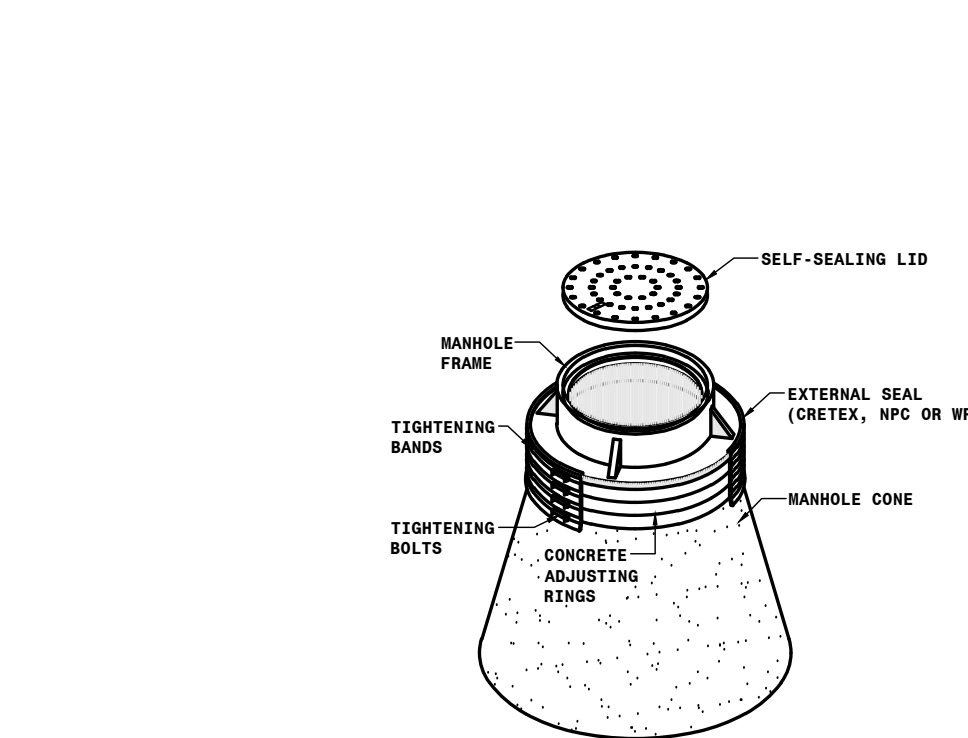


13 SANITARY MANHOLE SEALS DETAIL
C700 NOT-TO-SCALE

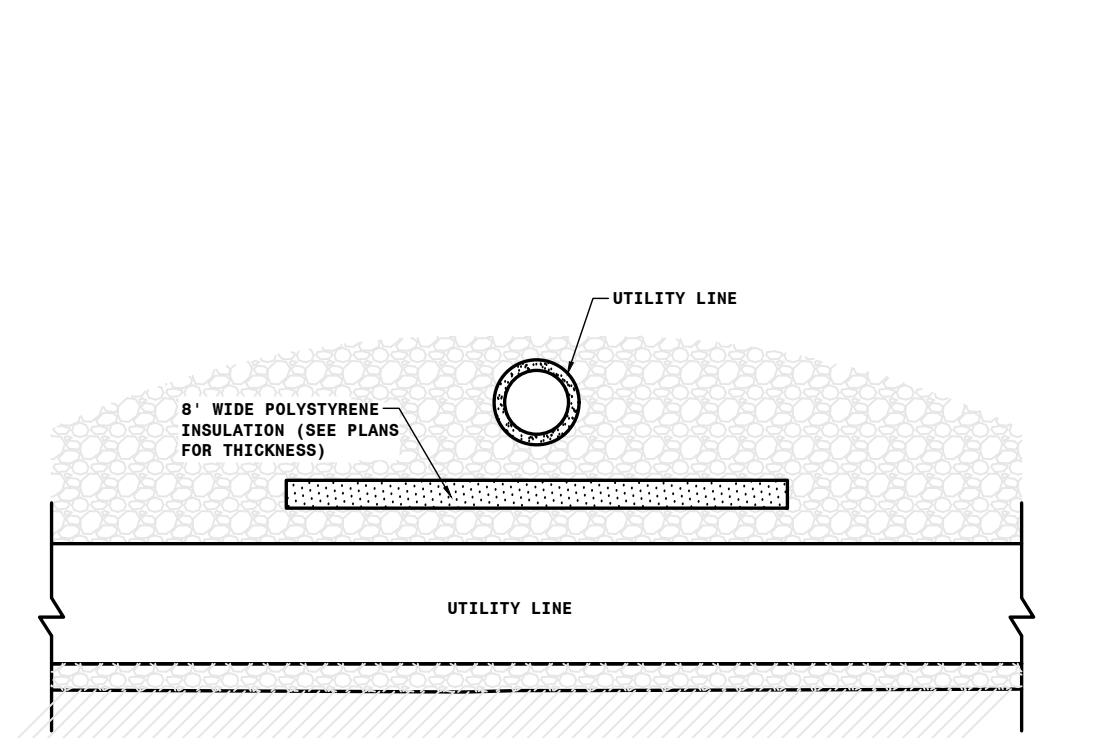

14 POLYSTYRENE INSULATION DETAIL
C700 NOT-TO-SCALE

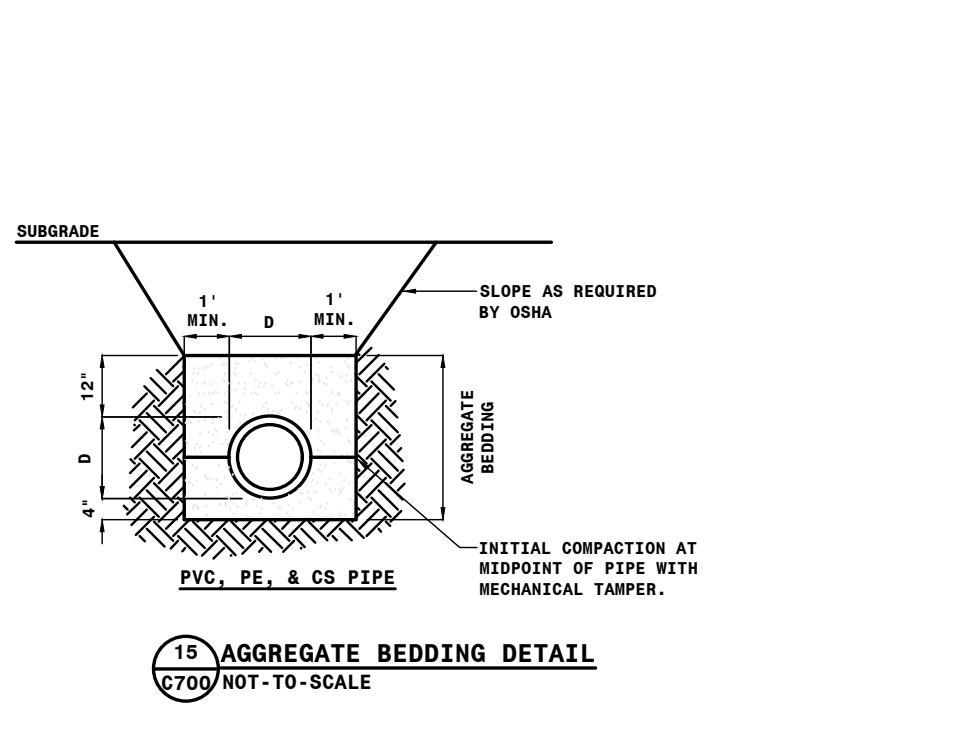

15 AGGREGATE BEDDING DETAIL
C700 NOT-TO-SCALE

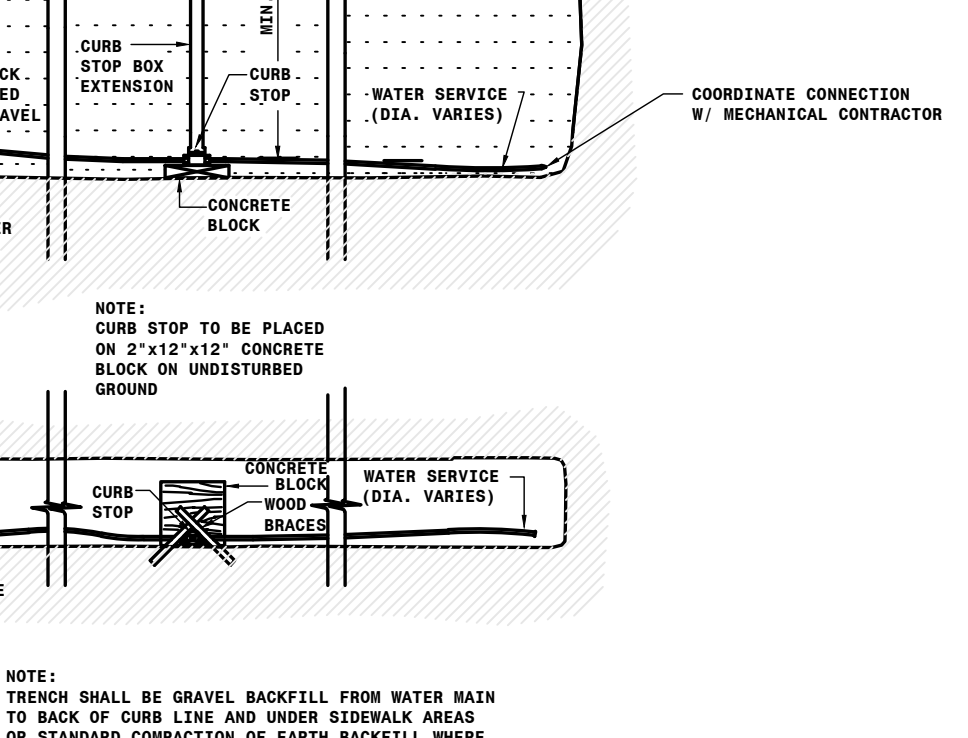

16 WATER MAIN SERVICE DETAIL
C700 NOT-TO-SCALE



DRAWING HISTORY

NO.	DESCRIPTION	DATE
1	DESIGN DOCUMENTS	01/15/25

DRAWN BY: BRC JN: 24-054

DETAILS

SHEET

C700



UNITED AND TURTLE
MOUNTAIN
COMMUNICATIONS
BOTTINEAU, NORTH DAKOTA

STRUCTURAL

ICON ARCHITECTURAL GROUP
222 EAST MAIN STREET, SUITE B
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MECHANICAL




MBN ENGINEERING, INC.
503 7TH STREET NORTH, SUITE 200
FARGO, ND 58102
(701) 478-6336 OFFICE

ELECTRICAL


MBN ENGINEERING, INC.
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CIVIL


MBN ENGINEERING, INC.
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FARGO, ND 58102
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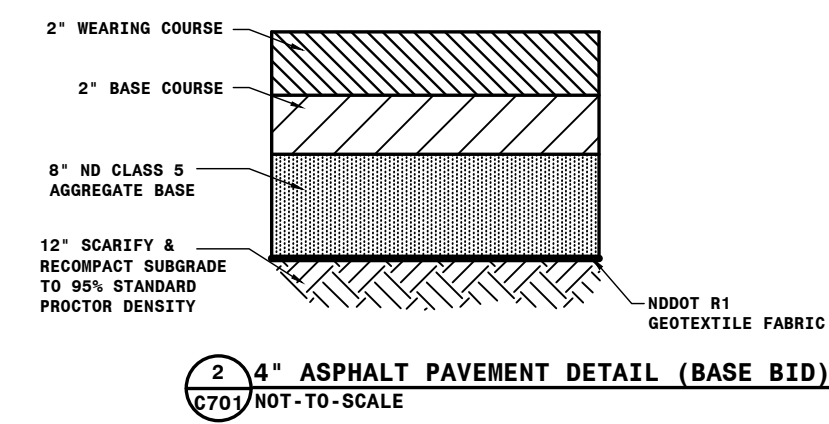
1 DRIVEWAY ABUTTING STANDARD CURB DETAIL (ALTERNATE)
C701/NOT-TO-SCALE

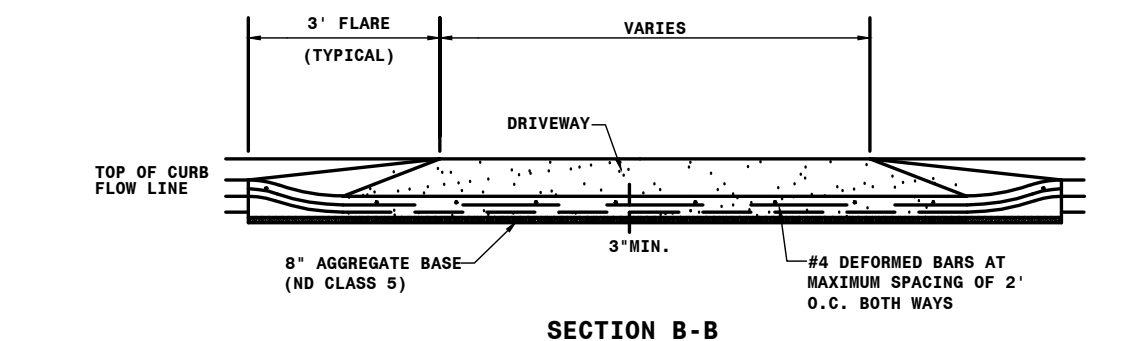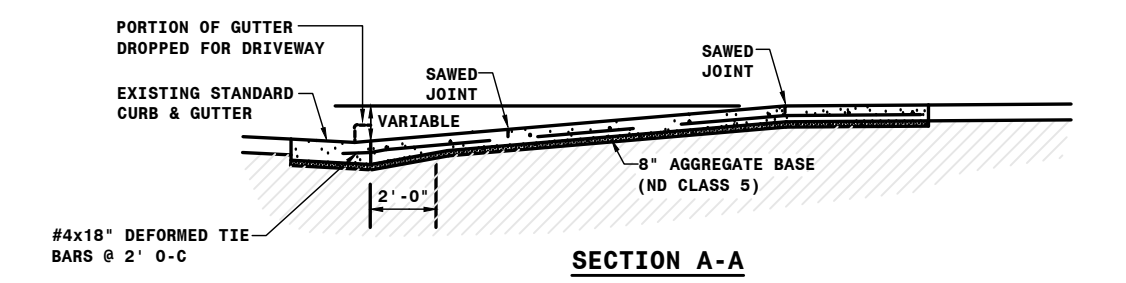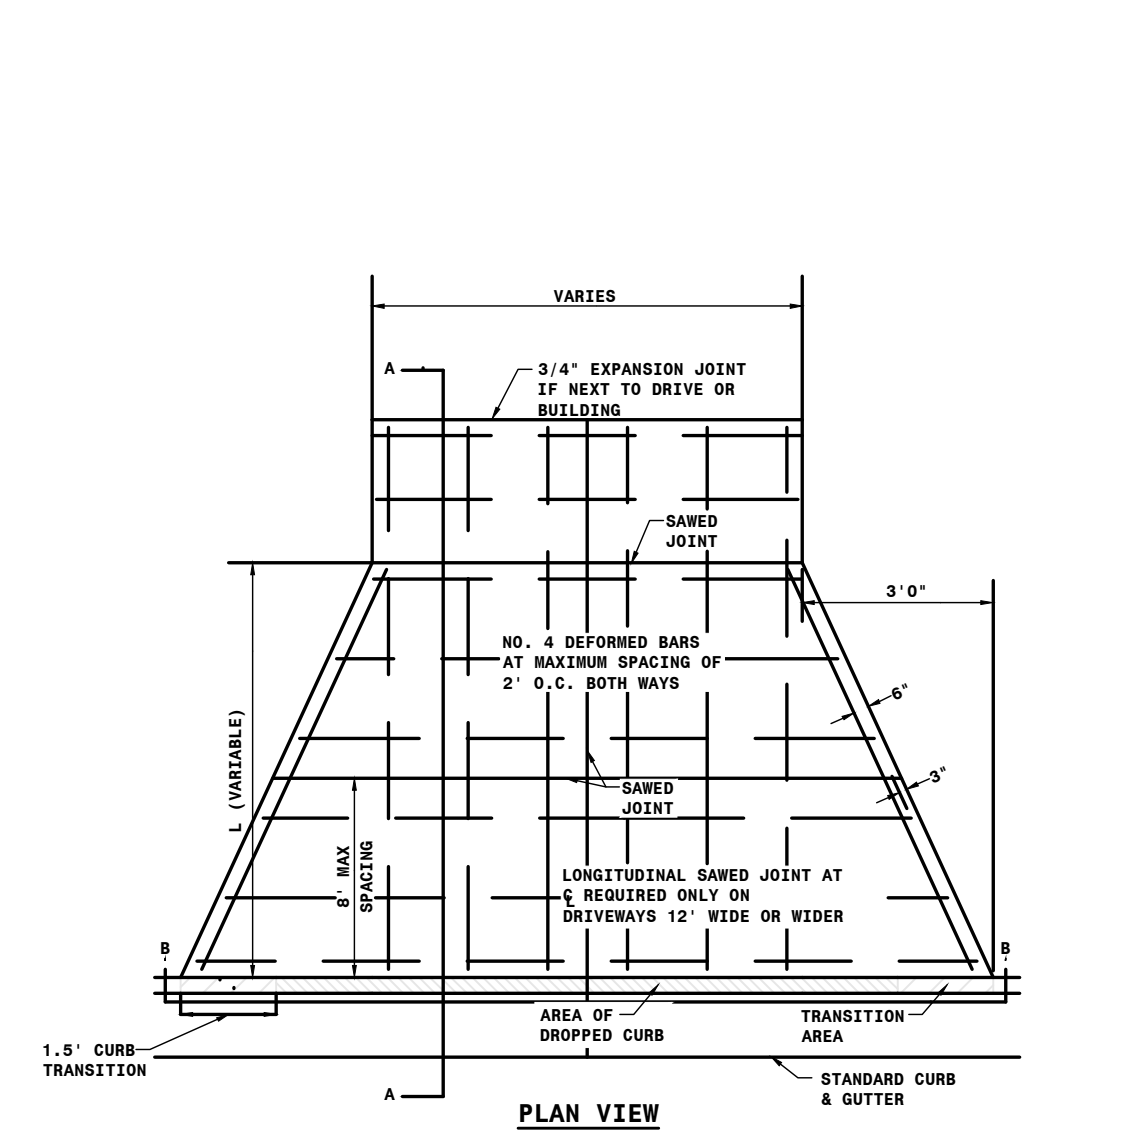


12 CHAIN LINK FENCE DETAIL W/ PRIVACY SCREEN
C701/NOT-TO-SCALE

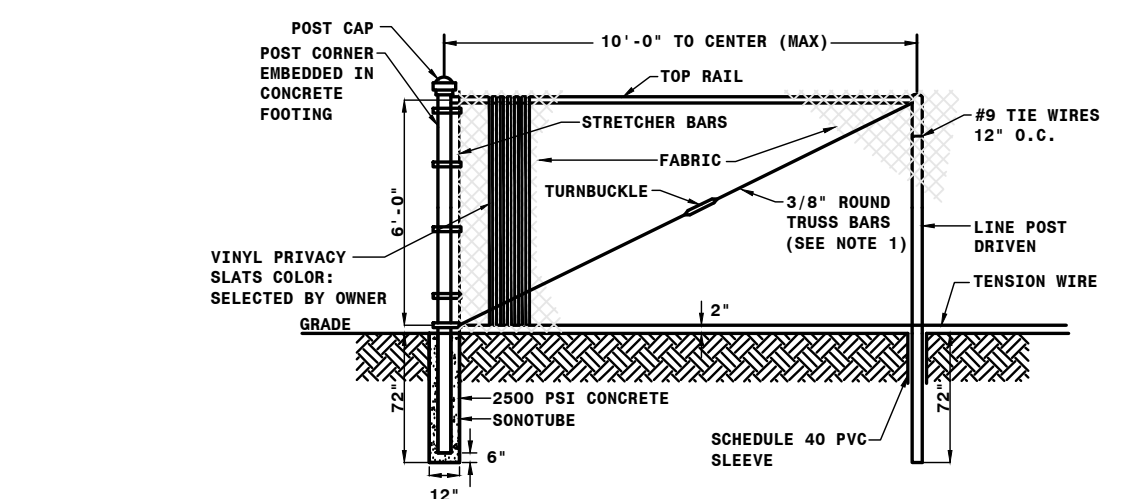


18 HIGH CHAINLINK FENCE W/ 15' WIDE DOUBLE ROLLER GATE W/ PRIVACY SCREEN DETAIL
C701/NOT-TO-SCALE

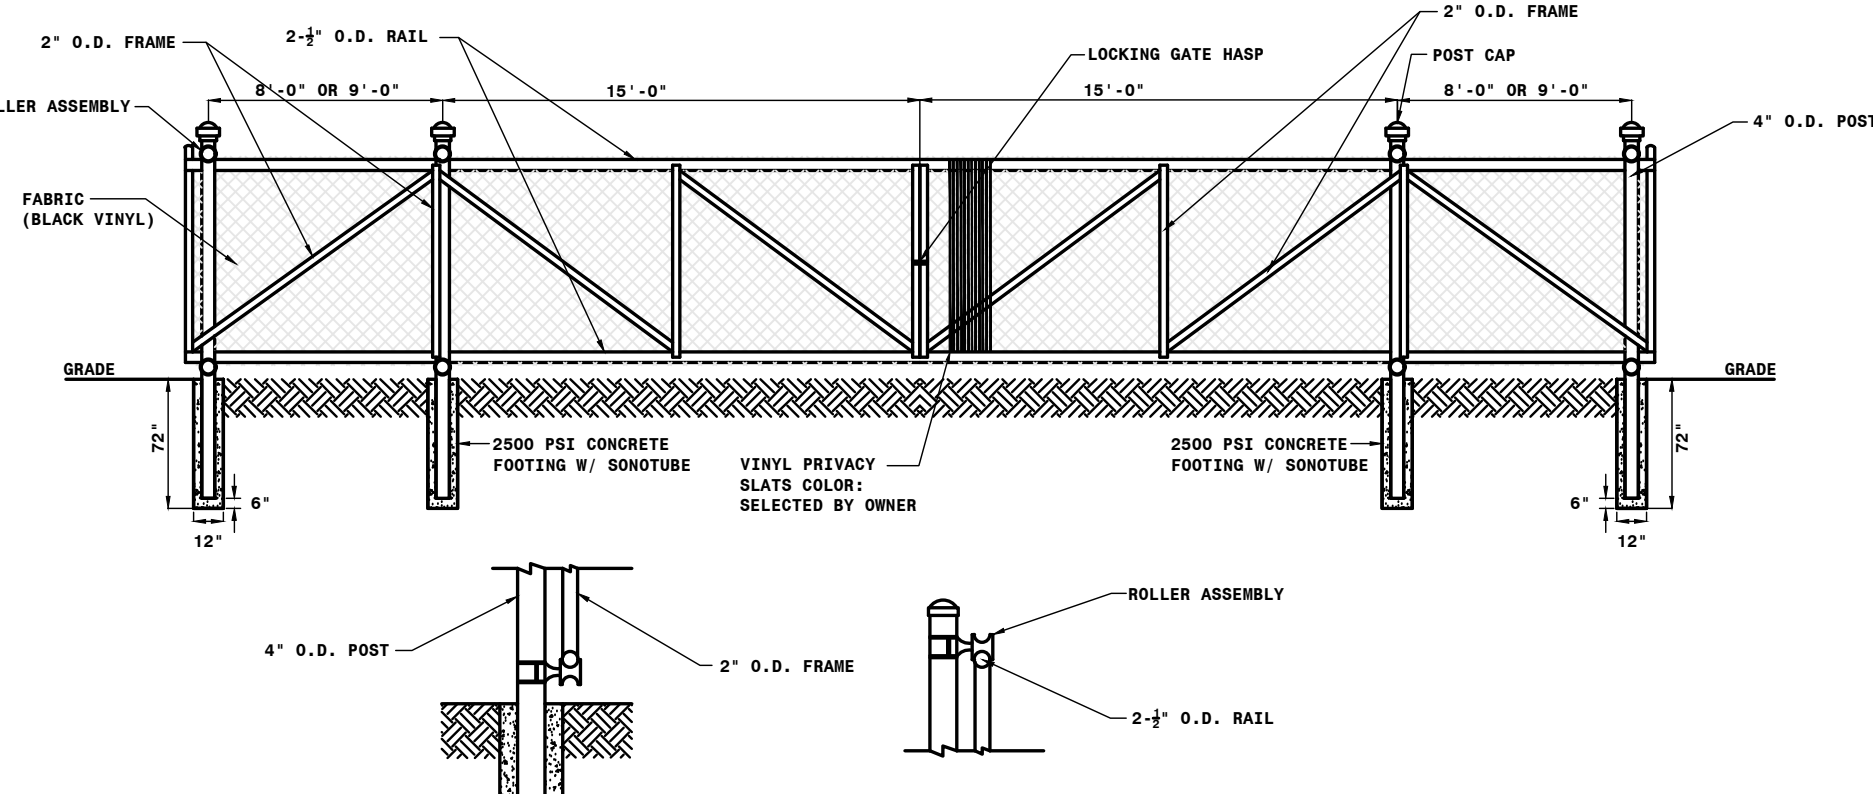


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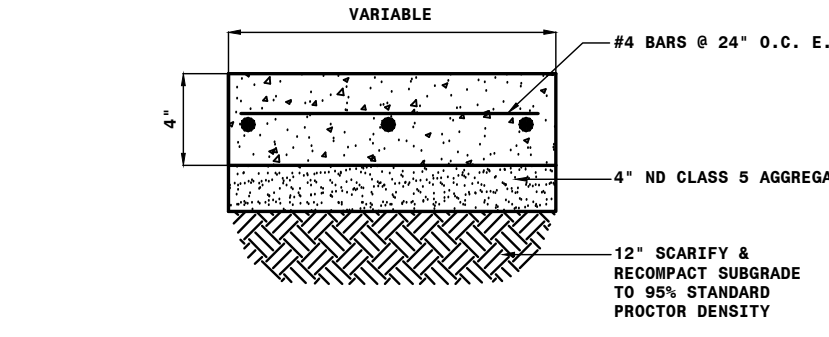
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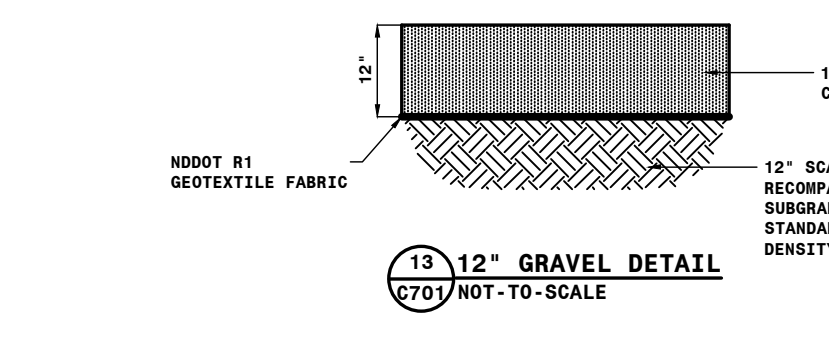
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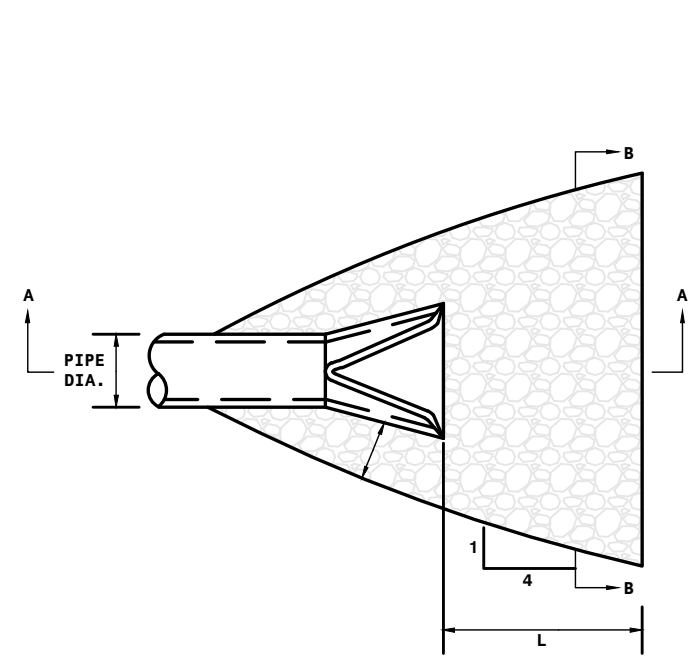
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8 4\"/>

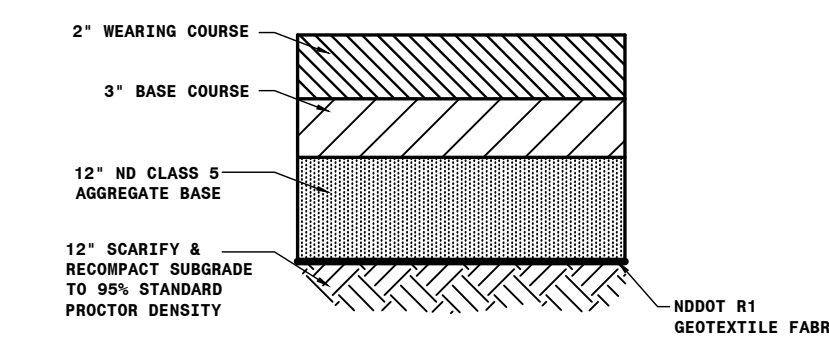


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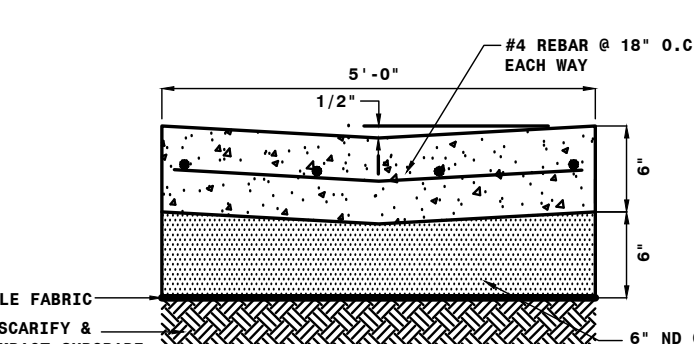


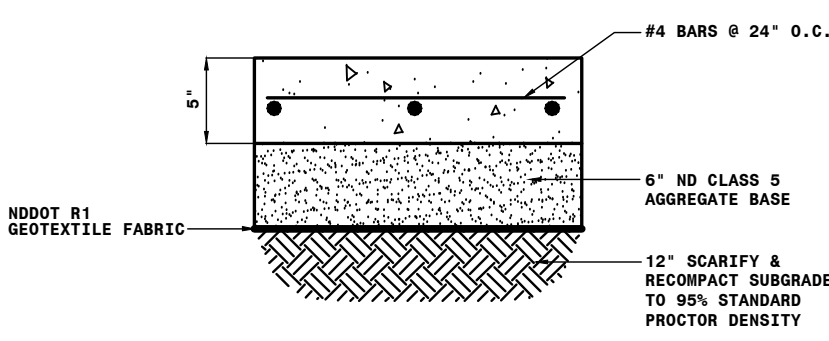8 RIP RAP DETAIL
C700/NOT-TO-SCALE


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18	8	5.8	2.9
18	10	7.8	3.9
24	10	8.4	4.2
24	12	11.0	5.5
27	12	11.6	5.8
30	14	14.8	7.3
33	16	16.4	7.8
36	16	18.3	9.2
42	18	21.7	10.9
48	20	25.8	12.9

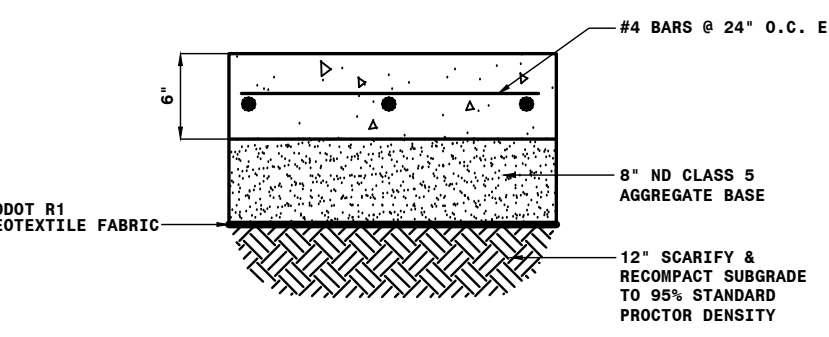

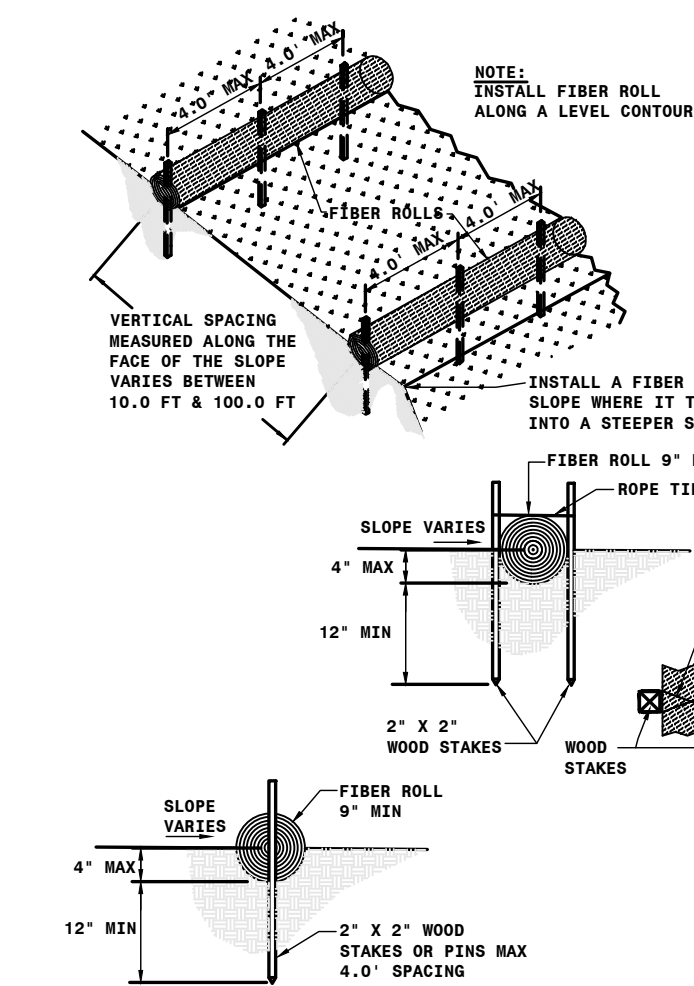
7 BIOROLL DETAIL
C700/NOT-TO-SCALE




14 CONCRETE VALLEY GUTTER DETAIL
C701/NOT-TO-SCALE

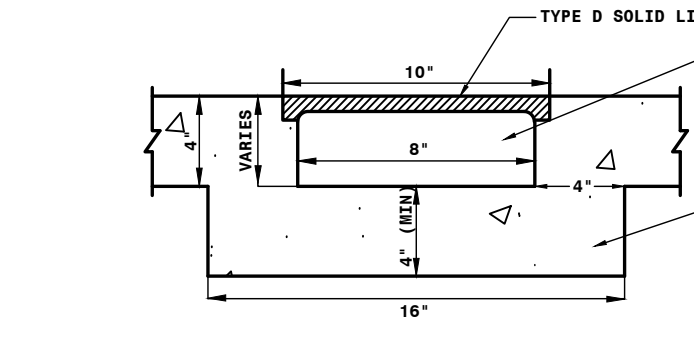


15 TRENCH DRAIN DETAIL
C701/NOT-TO-SCALE

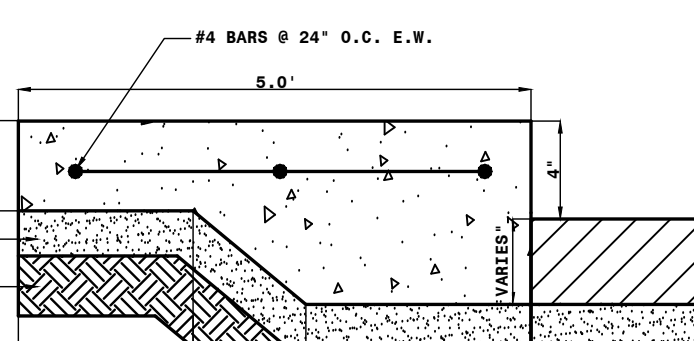


19 THICKENED EDGE CONCRETE DETAIL
C701/NOT-TO-SCALE

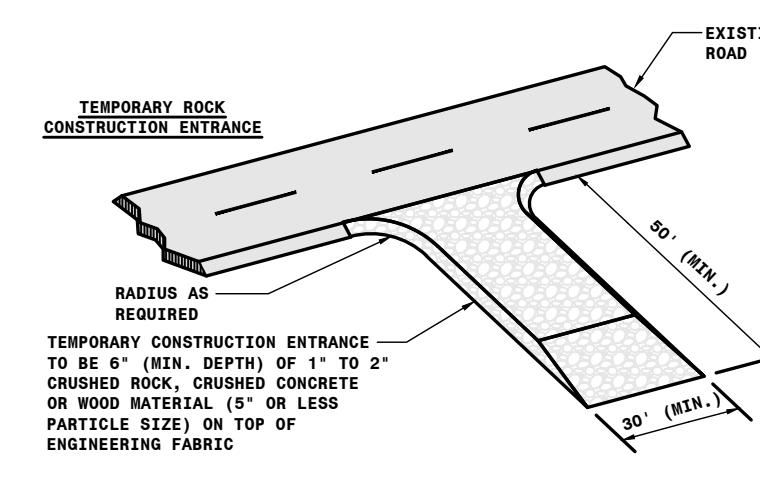


9 CONSTRUCTION ENTRANCE DETAIL
C700/NOT-TO-SCALE

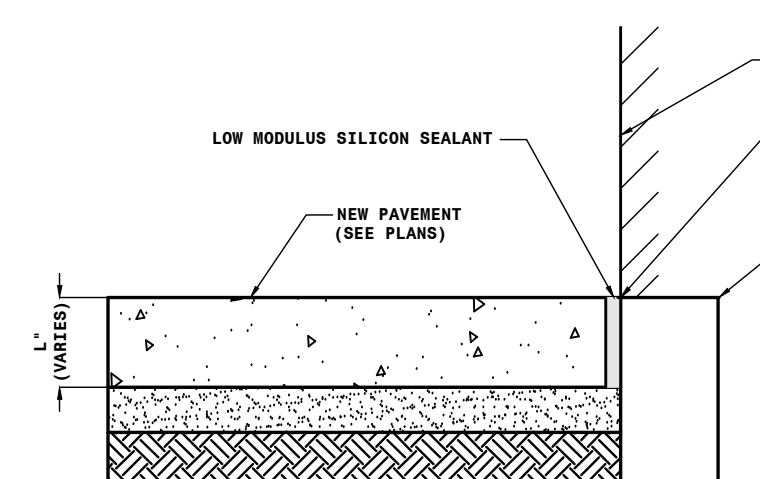


16 PAVEMENT ABUTTING BUILDING DETAIL
C701/NOT-TO-SCALE

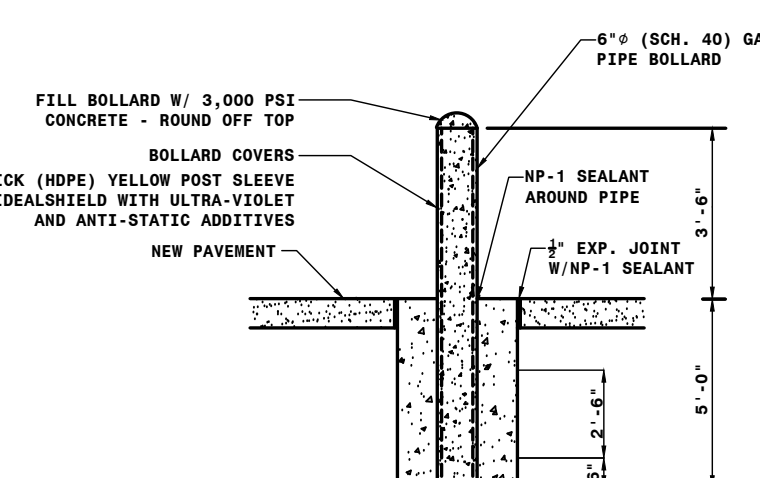

20 6\"/>

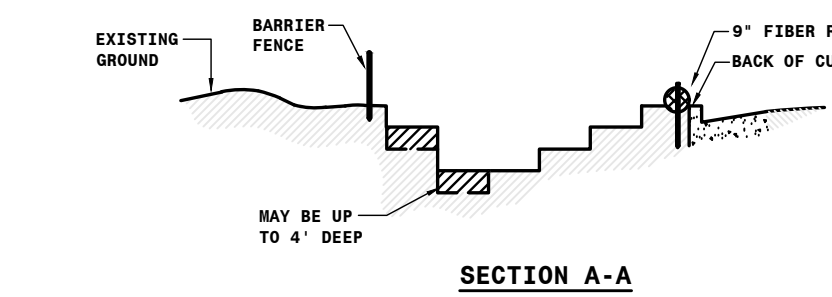


SECTION A-A

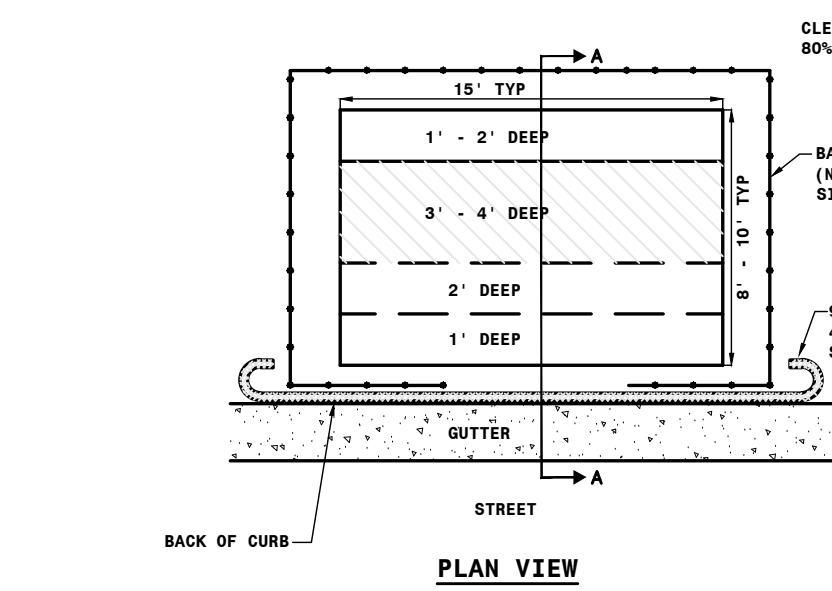


PLAN VIEW


10 CONCRETE WASHOUT DETAIL
C700/NOT-TO-SCALE

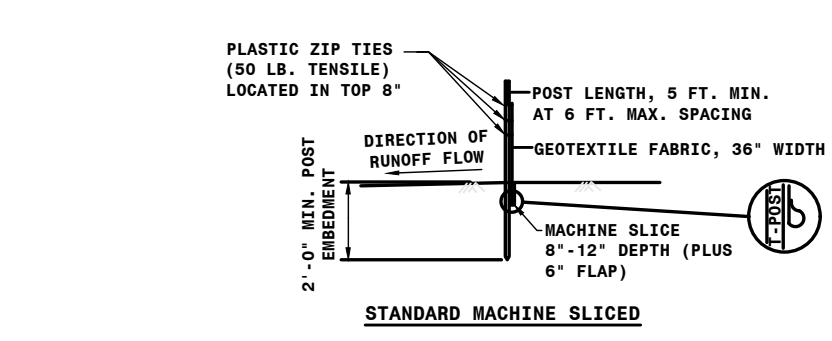


11 SILT FENCE DETAIL
C700/NOT-TO-SCALE

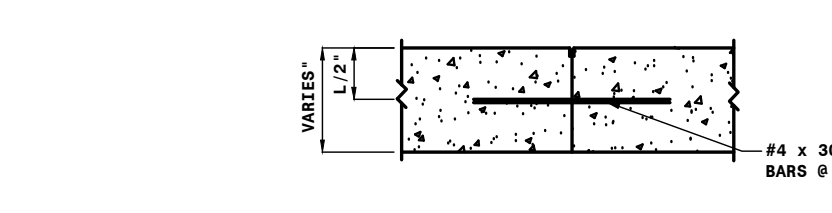

17 TYPE C TIED CONSTRUCTION JOINT DETAIL
C701/NOT-TO-SCALE

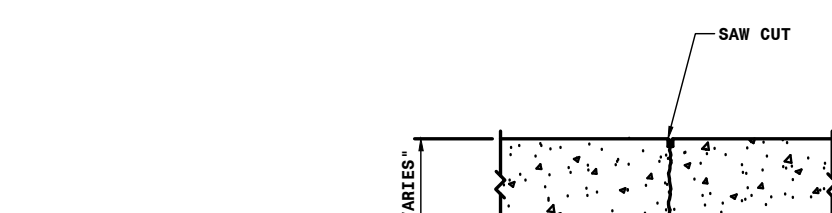

21 TYPE H CONSTRUCTION JOINT DETAIL
C701/NOT-TO-SCALE

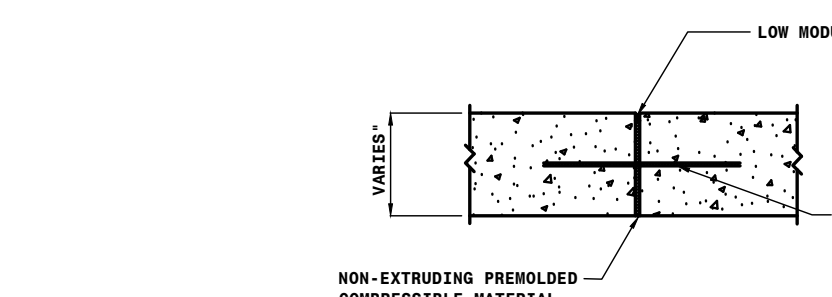

22 TYPE I ISOLATION JOINT DETAIL
C701/NOT-TO-SCALE

DRAWING HISTORY

NO.	DESCRIPTION	DATE
1	DESIGN DOCUMENTS	01/15/25

DRAWN BY: BRC JN: 24-054

DETAILS

SHEET

C701





UNITED AND TURTLE
MOUNTAIN
COMMUNICATIONS
BOTTINEAU, NORTH DAKOTA

STRUCTURAL

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MECHANICAL


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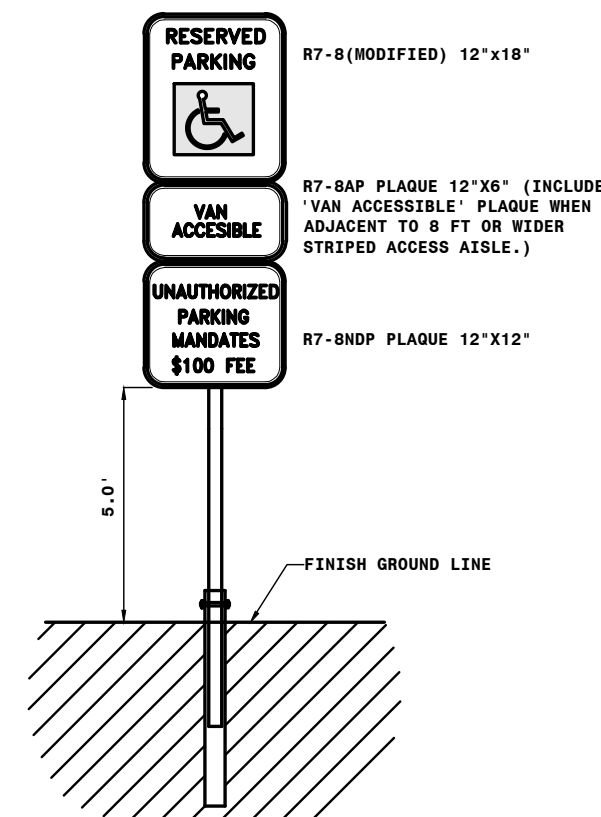
CIVIL

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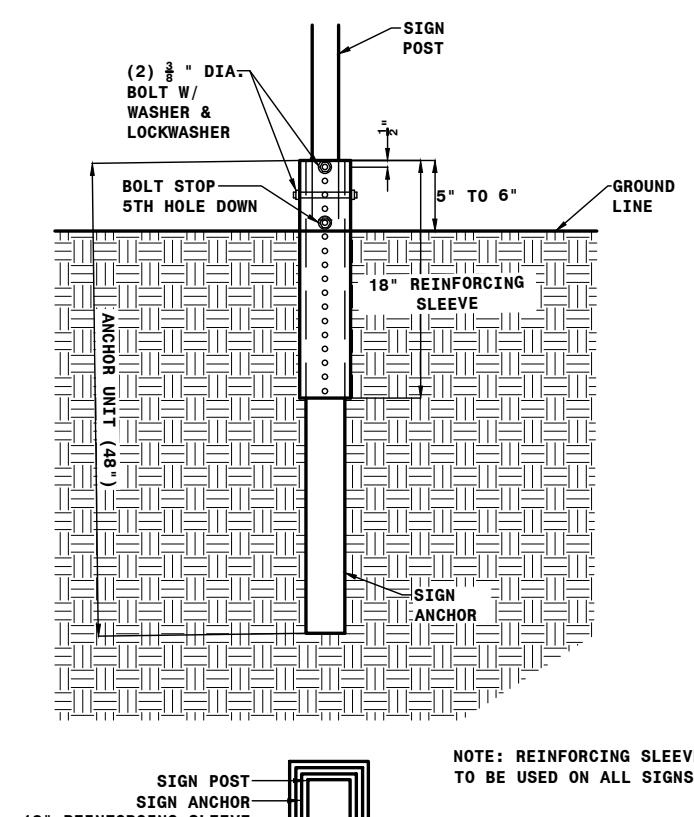
NOTES:
1. L = DIMENSIONS AS SHOWN ON PLANS. CENTER OF STRIPE TO CENTER OF STRIPE.
2. STRIPING ADJACENT TO ACCESSIBLE PARKING SHALL BE BLUE.

1 ACCESSIBLE STRIPING DETAIL
C702 NOT-TO-SCALE




NOTES:
1. SHEETING SHALL BE ENGINEER GRADE.
2. SIGN PLATE SHALL BE 80 GAUGE ALUMINUM.
3. SIGNS SHALL BE IN ACCORDANCE WITH THE MANUAL ON UNIFORM TRAFFIC CONTROL DEVICES.

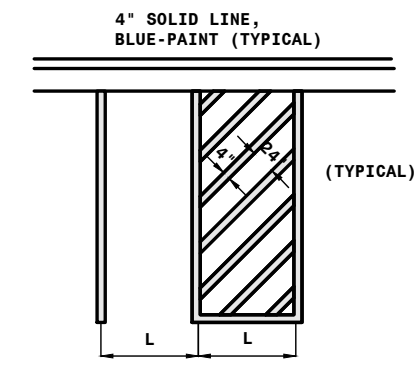2 ACCESSIBILITY SIGN DETAIL
C702 NOT-TO-SCALE



SIGN SIZE	POST	ANCHOR SLEEVE
12" WIDTH SIGNS	1.50"	1.75" 2.00"
18" WIDTH SIGNS & 24"x24" SIGNS	1.75"	2.00" 2.25"
LARGER THAN 24"x24"	2.00"	2.25" 2.50"

3 SIGN ANCHOR INSTALLATION DETAIL
C702 NOT-TO-SCALE

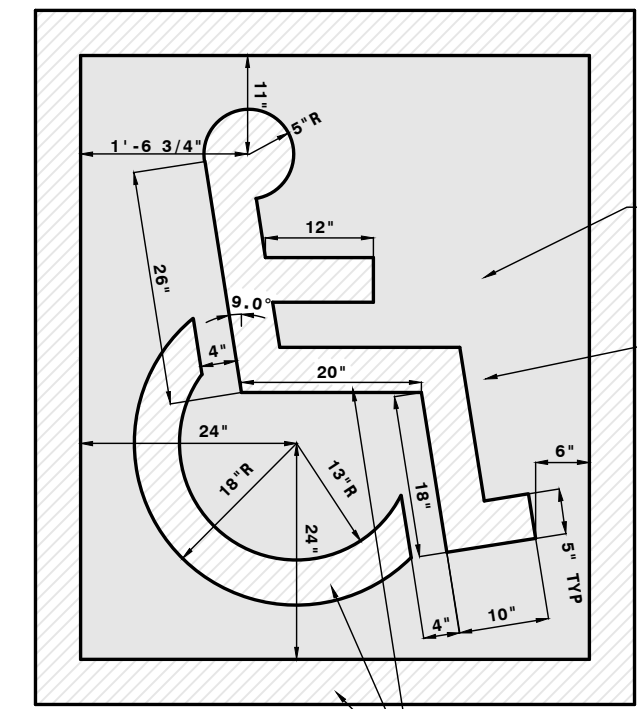

5" WIDE WHITE STRIPING - 2 COATS (TYPICAL)

4 ACCESSIBILITY SYMBOL DETAIL
C702 NOT-TO-SCALE



DRAWING HISTORY

NO.	DESCRIPTION	DATE
1	DESIGN DOCUMENTS	01/15/25

DRAWN BY: BRC JN: 24-054

DETAILS

SHEET

C702

SPECIAL INSPECTIONS AND TESTING:

THIS PROJECT REQUIRES SPECIAL INSPECTION AND TESTING IN ACCORDANCE WITH CHAPTER 17 OF THE INTERNATIONAL BUILDING CODE, 2018 EDITION. THESE NOTES AND THE STATEMENT OF SPECIAL INSPECTIONS PREPARED FOR THE PROJECT OWNER ARE INTENDED TO INFORM THE CONTRACTOR OF THE QUALITY ASSURANCE PROGRAM AND THE EXTENT OF THE CONTRACTOR'S RESPONSIBILITIES. THE CONTRACTOR SHALL REFER TO THE REFERENCE PROJECT MANUAL FOR ADDITIONAL INFORMATION. THE TESTING AND INSPECTION SERVICES SECTION WILL CLARIFY WHO SHALL EMPLOY AND PAY FOR SERVICES OF AN INDEPENDENT TESTING AGENCY TO PERFORM ALL INSPECTIONS, SPECIAL INSPECTIONS, AND TESTING FOR PROJECT.

GENERAL NOTES:

- 1. THE SPECIAL INSPECTION AND TESTING PROGRAM IS A QUALITY ASSURANCE PROGRAM INTENDED TO ENSURE THAT THE WORK IS PERFORMED IN ACCORDANCE WITH THE CONTRACT DOCUMENTS.
2. THE SPECIAL INSPECTION PROGRAM DOES NOT RELIEVE THE CONTRACTOR OF HIS OR HER RESPONSIBILITY TO COMPLY WITH THE OFFICIAL CONTRACT DOCUMENTS. THE CONTRACTOR HAS THE SOLE RESPONSIBILITY FOR ANY DEVIATIONS FROM THE OFFICIAL CONTRACT DRAWINGS. THE SPECIAL INSPECTOR DOES NOT REPLACE THE DUTIES OF THE BUILDING OFFICIAL NOR THE QUALITY CONTROL RESPONSIBILITIES AND PERSONNEL OF THE CONTRACTOR. JOB SITE SAFETY AND MEANS AND METHODS OF CONSTRUCTION ARE SOLELY THE RESPONSIBILITY OF THE CONTRACTOR.
3. THESE INSPECTIONS ARE IN ADDITION TO THE INSPECTIONS SPECIFIED IN THE IBC SECTION 110 AND SPECIFIC STRUCTURAL OBSERVATION AS MAY BE REQUIRED BY THE CODE. PERIODIC STRUCTURAL OBSERVATION BY THE SEOR IS SOLELY FOR THE PURPOSE OF DETERMINING IF THE WORK OF THE CONTRACTOR IS PROCEEDING IN GENERAL CONFORMANCE WITH THE CONTRACT DOCUMENTS. A LIMITED SITE OBSERVATION SHOULD NOT BE CONSTRUED AS EXHAUSTIVE, CONTINUOUS, OR MEETING THE SPECIAL INSPECTIONS OBLIGATIONS.
4. THOUGH NOT REQUIRED BY CODE, SPECIAL INSPECTORS AND/OR INSPECTION AGENCIES CAN DOCUMENT ACCEPTANCE OF THEIR RESPONSIBILITIES AND SCOPE OF WORK FOR A PROJECT BY SIGNING AN AGREEMENT THAT INCLUDES A DETAILED SCHEDULE OF SERVICES, COMMONLY KNOWN AS THE SPECIAL INSPECTION AND TESTING AGREEMENT AND THE SPECIAL INSPECTION AND TESTING SCHEDULE. THIS DOCUMENT MAY REFER TO THIS SHEET AS THE "STATEMENT OF SPECIAL INSPECTIONS." (SSI).
5. THE STRUCTURAL DESIGN METHODS AND/OR ASSUMPTIONS UTILIZED ARE BASED UPON THE SPECIAL INSPECTIONS REQUIRED WITHIN THE CONTRACT DOCUMENTS.

CONTRACTOR RESPONSIBILITIES AND DUTIES:

- 1. THE CONTRACTOR IS RESPONSIBLE FOR SCHEDULING AND PROVIDING ADEQUATE NOTICE TO THE SPECIAL INSPECTORS FOR ALL INSPECTIONS. THE CONTRACTOR SHALL REQUEST SPECIAL INSPECTION OF THE REQUIRED ITEMS PRIOR TO THOSE ITEMS BECOMING INACCESSIBLE AND UNOBSERVABLE DUE TO PROGRESSION OF WORK.
2. THE CONTRACTOR SHALL PROVIDE THE SPECIAL INSPECTOR ACCESS TO THE APPROVED CONTRACT DOCUMENTS. THESE DOCUMENTS INCLUDE SEALED DRAWINGS AND SPECIFICATIONS, ADDENDA, CHANGE ORDERS, APPROVED SHOP DRAWINGS, ISSUED SKETCHES AND REVISION DRAWINGS, AND ALL DIRECTIVES ISSUED BY THE ARCHITECT/ENGINEER. THIS CURRENT SET OF DOCUMENTS SHALL BE AVAILABLE AT THE JOB SITE.
3. THE CONTRACTOR IS TO CORRECT DISCREPANCIES AND DEVIATIONS AS DETERMINED BY SPECIAL INSPECTORS. ALL DISCREPANCIES AND DEVIATIONS ORDERED SHALL BE RE-INSPECTED UNTIL THE SPECIAL INSPECTOR DEEMS CONSTRUCTION TO BE IN ACCORDANCE WITH THE CONTRACT DOCUMENTS.
4. THE CONTRACTOR IS TO RETAIN SPECIAL INSPECTION RECORDS COMPLETED BY THE SPECIAL INSPECTORS AT THE JOB SITE.

SPECIAL INSPECTOR QUALIFICATIONS AND RESPONSIBILITIES:

- 1. THE SPECIAL INSPECTOR SHALL BE A QUALIFIED PERSON WHO SHALL DEMONSTRATE COMPETENCE, TO THE SATISFACTION OF THE BUILDING OFFICIAL, FOR INSPECTION OF THE PARTICULAR TYPE OF CONSTRUCTION OR OPERATION REQUIRING SPECIAL INSPECTION.
2. SPECIAL INSPECTORS SHALL NOTIFY CONTRACTOR PERSONNEL OF THEIR PRESENCE AND RESPONSIBILITIES AT THE JOBSITE.
3. THE SPECIAL INSPECTOR/TESTING AGENCY SHALL BE INDEPENDENT OF THE CONTRACTOR TO AVOID CONFLICT OF INTEREST.
4. THE SPECIAL INSPECTOR IS OBLIGATED TO BOTH THE OWNER AND THE BUILDING OFFICIAL FOR OBSERVING THAT THE WORK IS EXECUTED IN ACCORDANCE WITH THE OFFICIAL CONTRACT DOCUMENTS. THESE DOCUMENTS INCLUDE SEALED DRAWINGS AND SPECIFICATIONS, ADDENDA, CHANGE ORDERS, APPROVED SHOP DRAWINGS, ISSUED SKETCHES AND REVISION DRAWINGS, AND ALL DIRECTIVES ISSUED BY THE ARCHITECT/ENGINEER.
5. SPECIAL INSPECTORS SHALL KEEP ORGANIZED RECORDS OF INSPECTIONS AND SUBMIT INSPECTION REPORTS WITH A MINIMUM WEEKLY FREQUENCY TO THE CONTRACTOR, BUILDING OFFICIAL, ENGINEERS, AND ARCHITECTS INDIVIDUALLY. REPORTS SHOULD INDICATE THAT WORK INSPECTED WAS DONE IN CONFORMANCE TO APPROVED CONSTRUCTION DOCUMENTS. DISCREPANCIES SHALL BE BROUGHT TO THE IMMEDIATE ATTENTION TO THE CONTRACTOR FOR CORRECTION. IF THE DISCREPANCIES ARE NOT CORRECTED, THEY SHOULD BE REPORTED TO THE BUILDING OFFICIAL AND TO THE ENGINEER OF RECORD.
6. A FINAL SIGNED REPORT IS TO BE SUBMITTED AT THE END OF THE PROJECT DOCUMENTING REQUIRED SPECIAL INSPECTIONS AND CORRECTION OF ANY DISCREPANCIES. THIS REPORT SHOULD STATE THAT ALL ITEMS REQUIRING SPECIAL INSPECTION AND TESTING WERE FULFILLED AND REPORTED TO THE BEST OF THEIR KNOWLEDGE IN CONFORMANCE WITH THE APPROVED PLANS, SPECIFICATIONS, AND THE APPLICABLE PROVISIONS OF THE IBC. ITEMS NOT IN CONFORMANCE, UNRESOLVED ITEMS, OR ANY DISCREPANCIES IN INSPECTION COVERAGE SHOULD BE SPECIFICALLY ITEMIZED.
7. THE FOLLOWING ARE THE QUALIFICATIONS FOR FOR INDIVIDUALS PERFORMING SPECIFIC INSPECTIONS OR TESTS INCLUDING IN THIS PROJECTS SSI.
A. AMERICAN CONCRETE INSTITUTE (ACI) CERTIFICATION:
- ACI-CSC CONCRETE CONSTRUCTION SPECIAL INSPECTOR
- ACI-FTT FIELD TESTING TECHNICIAN - GRADE 1
- ACI-LTT LABORATORY TESTING TECHNICIAN - LEVEL 1 OR 2
- ACI-STT STRENGTH TESTING TECHNICIAN
B. AMERICAN WELDING SOCIETY (AWS) CERTIFICATION:
- AWS-CWI CERTIFIED WELDING INSPECTOR
- AWS/AISC-SSI CERTIFIED STRUCTURAL STEEL INSPECTION
C. AMERICAN SOCIETY OF NON-DESTRUCTIVE TESTING (ASNT) CERTIFICATION:
- ASNT NON-DESTRUCTIVE TESTING TECHNICIAN - LEVEL II OR III
D. INTERNATIONAL CODE COUNCIL (ICC) CERTIFICATION:
- ICC-CBI COMMERCIAL BUILDING INSPECTOR
- ICC-SMSI STRUCTURAL MASONRY SPECIAL INSPECTOR
- ICC-SSSI STRUCTURAL STEEL AND BOLTING SPECIAL INSPECTOR
- ICC-SWI STRUCTURAL WELDING SPECIAL INSPECTOR
- ICC-PCSI PRESTRESSED CONCRETE SPECIAL INSPECTOR
- ICC-RCSI REINFORCED CONCRETE SPECIAL INSPECTOR
- ICC-SSI SOILS SPECIAL INSPECTOR
E. PROFESSIONAL STATE LICENSING:
- PE-STRUCT STRUCTURAL ENGINEER, LICENSED PE OR SE SPECIALIZING IN THE DESIGN OF BUILDINGS AND STRUCTURES
- PE-GEOTECH GEOTECHNICAL ENGINEER, LICENSED PE SPECIALIZING IN SOIL MECHANICS AND FOUNDATIONS
- EIT ENGINEER-IN-TRAINING: GRADUATE ENGINEER WHO HAS PASSED THE FUNDAMENTALS OF ENGINEERING EXAMINATION

STATEMENT OF SPECIAL INSPECTIONS (SSI):

- 1. THE FOLLOWING TABLES INDICATE THE MINIMUM SPECIFIC SPECIAL INSPECTION AND TESTING TO BE PERFORMED ON THIS PROJECT AND THE QUALIFICATIONS OF THE INDIVIDUAL INSPECTORS AND TESTING TECHNICIANS.

DEFINITIONS:

- 1. CONTINUOUS SPECIAL INSPECTION: THE FULL-TIME OBSERVATION OF WORK REQUIRING SPECIAL INSPECTION BY AN APPROVED SPECIAL INSPECTOR WHO IS PRESENT IN THE AREA WHERE THE WORK IS BEING PERFORMED. 100% OF THE WORK MUST BE INSPECTED AND IT MUST BE INSPECTED AS THE WORK IS BEING PERFORMED.
2. PERIODIC SPECIAL INSPECTION: THE PART-TIME OR INTERMITTENT OBSERVATION OF WORK REQUIRING SPECIAL INSPECTION BY AN APPROVED SPECIAL INSPECTOR WHO IS PRESENT IN THE AREA WHERE THE WORK HAS BEEN, OR IS BEING, PERFORMED AND AT THE COMPLETION OF WORK.
3. YES: THIS INSPECTION AND/OR TESTING IS REQUIRED BY THE BUILDING CODE AND MUST BE PERFORMED.
4. NO: THIS INSPECTION AND/OR TESTING IS NOT APPLICABLE TO THE PROJECT, AND NEED NOT BE PERFORMED.
5. SUGGESTED: THIS INSPECTION AND/OR TESTING IS NOT REQUIRED BY THE BUILDING CODE. HOWEVER, THE ENGINEER OF RECORD RECOMMENDS IMPLEMENTING THEM FOR QUALITY ASSURANCE. A POTENTIAL EXISTS FOR THESE MEASURES TO BE A VALUE ADDED SERVICE FOR THE OWNER TO ENSURE PROPER PROJECT COMPLETION.

Table with 6 columns: AREA REQUIRING SPECIAL TESTING & INSPECTION, AGENCY QUALIFICATION, REFERENCE STANDARD, FREQUENCY, COMMENTS, RECD. Row 1: Shallow Foundations, ICC-SSI PE-GEOTECH, Applicable ASTM Standards, Cont/Periodic, Verify materials below shallow foundations are adequate to achieve the design bearing capacity. Row 2: Controlled Structural Fill, ICC-SSI PE-GEOTECH, Applicable ASTM Standards, Cont/Periodic, Classification and testing of compacted fill materials should include applicable sieve tests and modified Proctor tests.

Table with 6 columns: AREA REQUIRING SPECIAL TESTING & INSPECTION, AGENCY QUALIFICATION, REFERENCE STANDARD, FREQUENCY, COMMENTS, RECD. Rows include Material Certification, Reinforcement, Rebar welding, Anchors cast in concrete, Anchors post-installed, Verify use of required design mix, Concrete placement, Concrete curing, Prestressed concrete, Precast concrete members, In-situ concrete strength, Formwork. Includes exceptions for nonstructural concrete slabs and concrete patios.

Table with 6 columns: AREA REQUIRING SPECIAL TESTING & INSPECTION, AGENCY QUALIFICATION, REFERENCE STANDARD, FREQUENCY, COMMENTS, RECD. Rows include Fabricator certification, Material certification & verification, High-strength bolting, Structural steel welding, Steel frame joint details, Open-web steel joints, Cold formed steel deck installation, Shear connectors.



TURTLE MOUNTAIN COMMUNICATIONS NEW BUILDING BOTTINEAU, NORTH DAKOTA

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DRAWING HISTORY

Table with 3 columns: NO., DESCRIPTION, DATE. Row 1: CONSTRUCTION DOCUMENTS, 01/5/2025

DRAWN BY: TO/AF JN: 24-054

Special Inspections & Testing

SHEET

S002



TURTLE MOUNTAIN COMMUNICATIONS NEW BUILDING
BOTTINEAU, NORTH DAKOTA

STRUCTURAL

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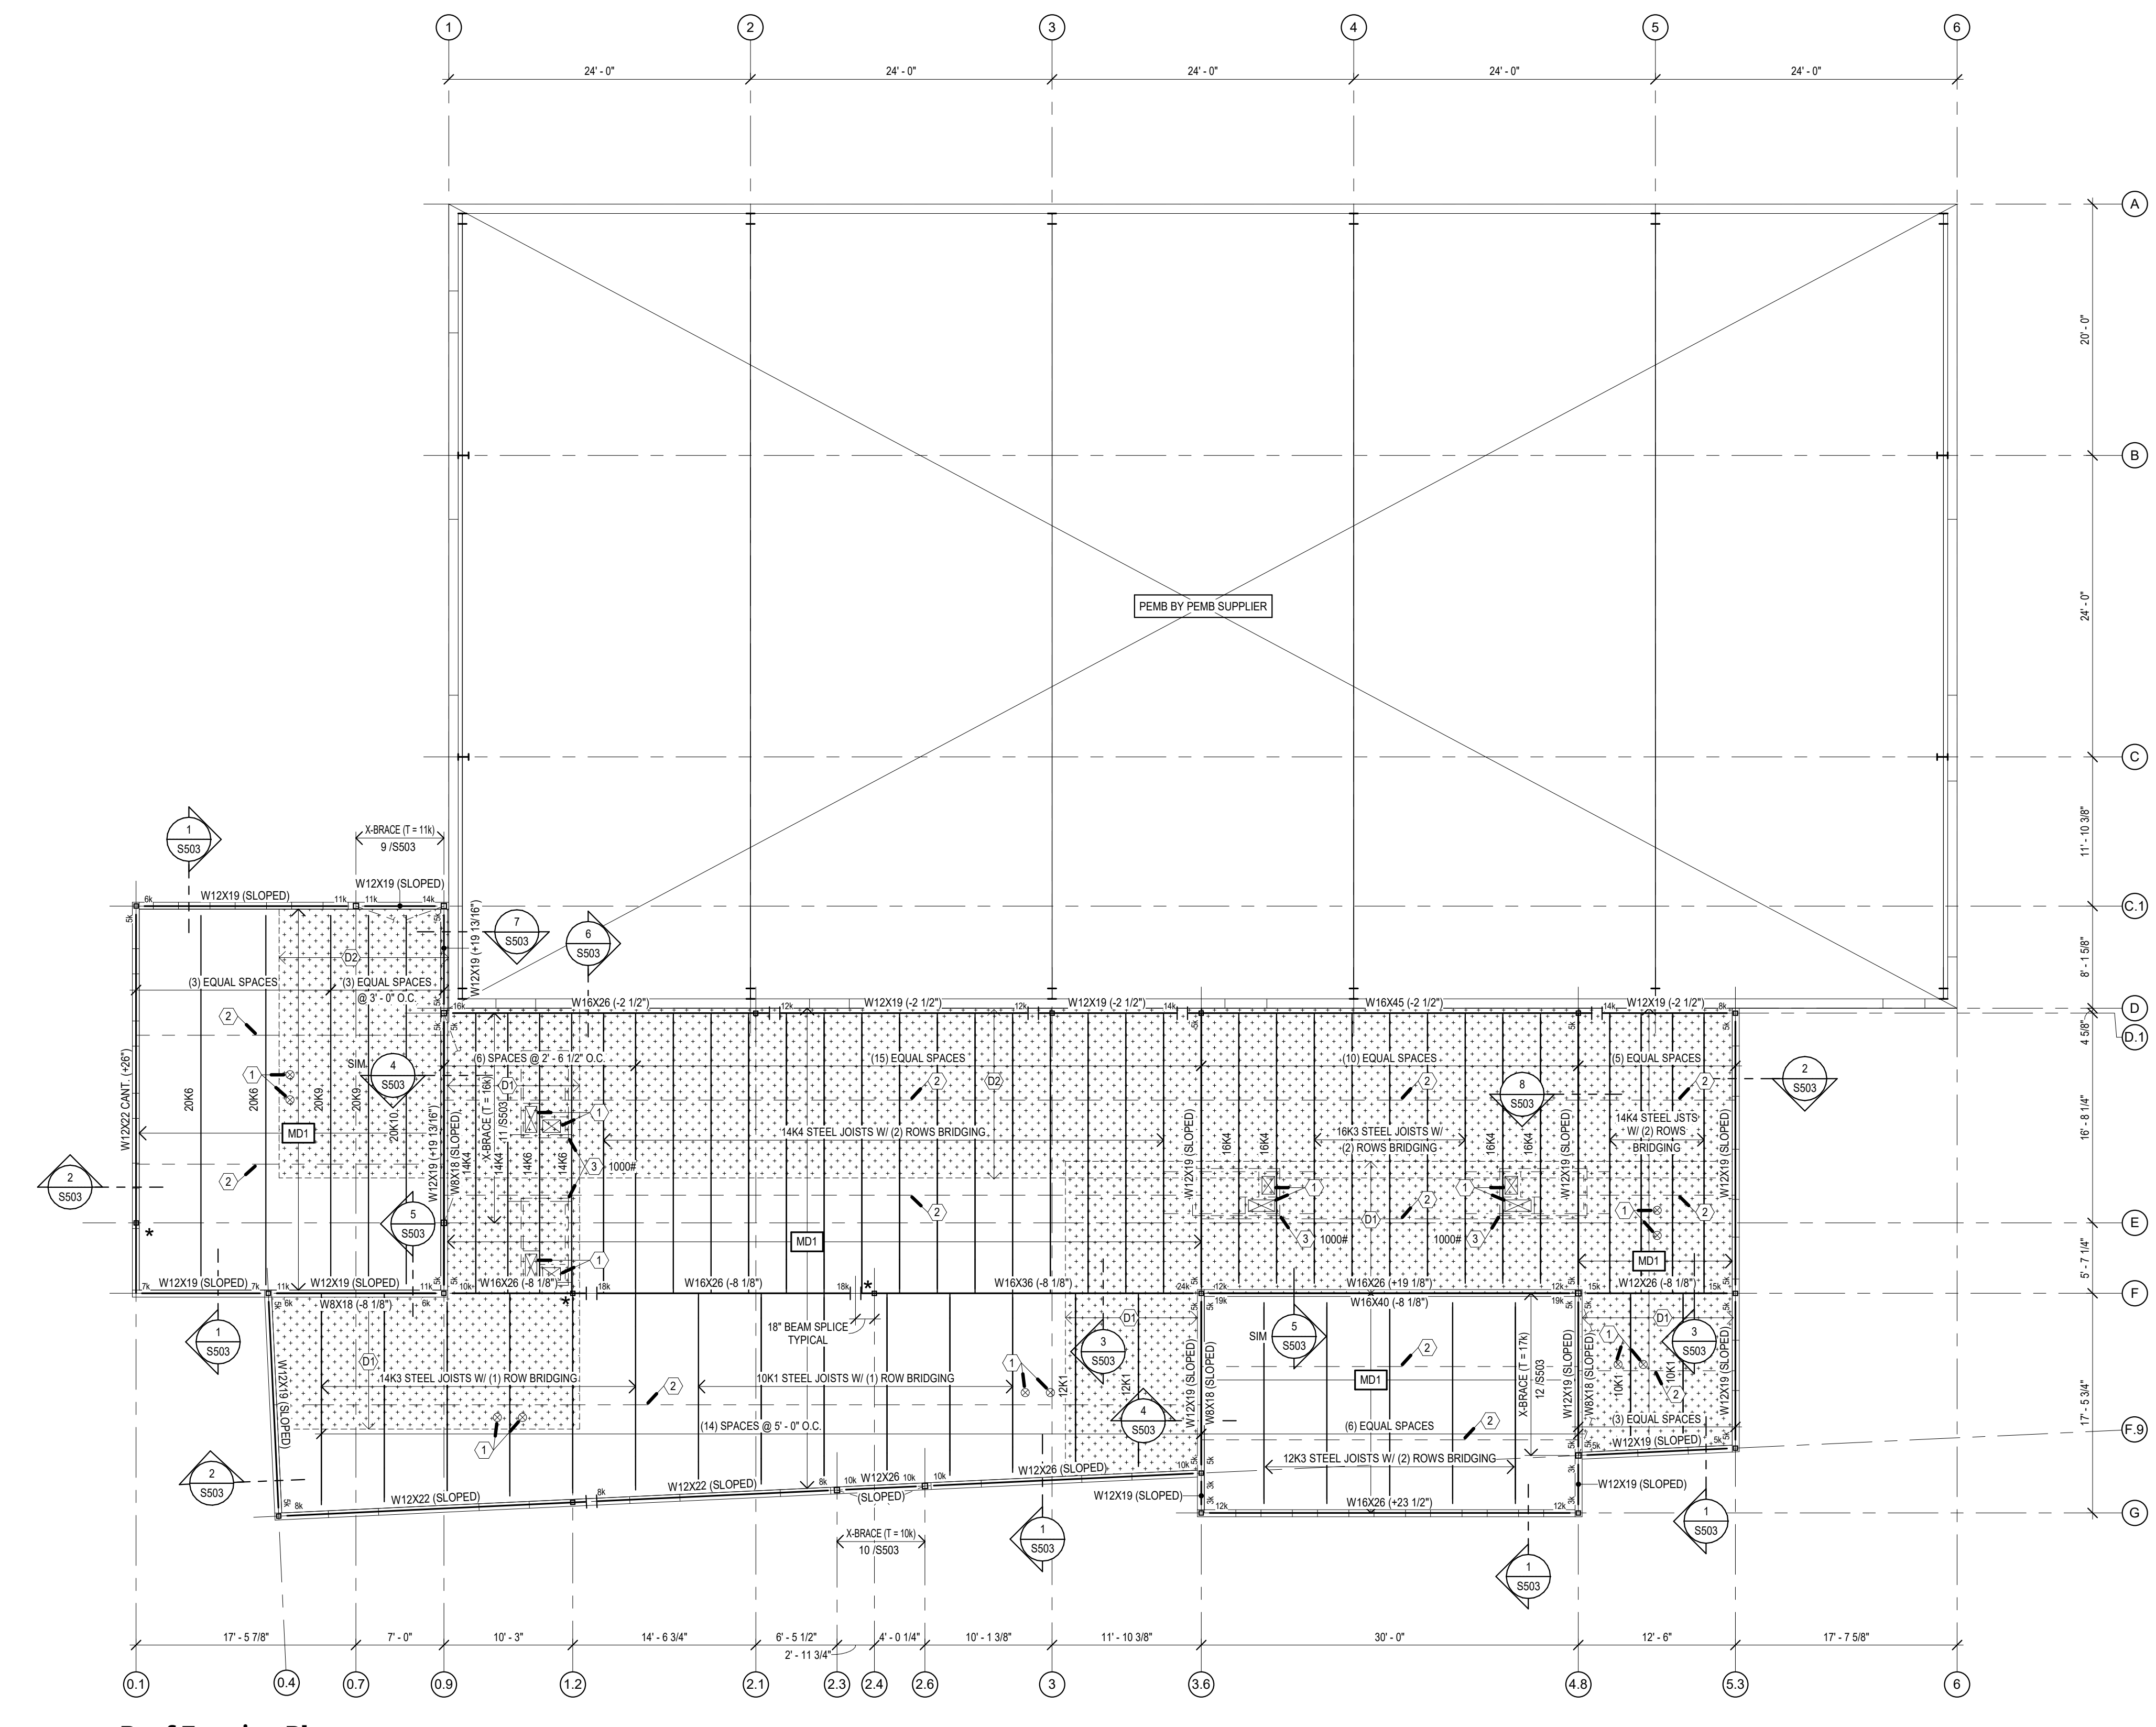
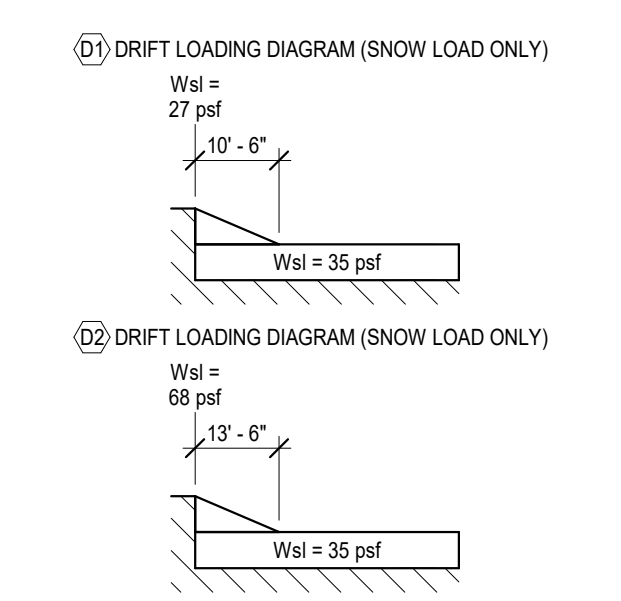
FRAMING PLAN SHEET NOTES

- NUMBER IN PARENTHESES WITH "A" ADJACENT TO STEEL BEAM SIZE INDICATES ELEVATION OF TOP OF STEEL BEAM IN INCHES FROM REFERENCE ELEVATION EQUAL TO DECK BEARING ELEVATION (DBE) - NO NUMBER ADJACENT TO BEAM SIZE INDICATES TOP OF BEAM AT DBE.
- CONTRACTOR TO VERIFY ALL DIMENSIONS & NOTIFY ARCHITECT / ENGINEER IF DISCREPANCIES EXIST.
- SEE SHEET S001.1 FOR GENERAL FRAMING / COLD FORMED NOTES AND MINIMUM COLD FORMED DESIGN VALUES.
- EXTERIOR COLD FORMED STUDS SHALL BE 600S###-## STEEL STUDS. WIDTH, GAUGE AND SPACING TO BE DETERMINED BY COLD FORMED STUD SUPPLIER.
- USE DEEP LEG TRACK FOR ATTACHMENT OF INTERIOR NON-BEARING PARTITION LIGHT GAUGE STUD WALLS TO TRUSS / JOISTS. ALLOW FOR 1" VERTICAL ROOF DEFLECTION. DO NOT FIT PARTITION WALLS TIGHT TO UNDERSIDE OF TRUSSES / JOISTS.
- SHEATH EXTERIOR WALLS W/ 5/8" (19/32" MIN) EXTERIOR GYP SHEATHING, ONE FACE. UON. FASTEN ALL PANEL EDGES AND PANEL FIELD PER VERTICAL STRUCTURAL SHEATHING NOTES ON SHEET S001.2, UON.
- TRUSS / JOIST SUPPLIER SHALL COORDINATE LAYOUT W/ MECH PIPING, VENTING, ETC. PRIOR TO SUBMITTING SHOP DRAWINGS. TRUSS / JOIST SUPPLIER TO PROVIDE ADDITIONAL TRUSSES / JOISTS PER CONTRACTOR.
- VERIFY SIZE, QUANTITY & LOCATIONS FOR ALL ROOF PENETRATIONS W/ ARCHITECTURAL & MECHANICAL DRAWINGS. SEE DETAIL 8 / S501 FOR FRAMING AT ALL ROOF PENETRATIONS.
- [MD1] - DENOTES METAL DECK - SEE SCHEDULE ON SHEET S001.3
- [] - DENOTES STEEL BEAM CANTILEVERED OVER STEEL COLUMN CONNECTION. SEE DETAIL 4 / S501
- [] - INDICATES A SNOW DRIFT LOAD PER IBC. SNOW DRIFTS ARE TAPERED LOADS WITH MAGNITUDES AS INDICATED ON THE PLANS. DRIFT LOADS ARE TO BE APPLIED IN ADDITION TO UNIFORM ROOF LOADS AS INDICATED IN THE GENERAL STRUCTURAL NOTES.
- "*-": INDICATES A L 2 x 2 x 3/16" BOTTOM FLANGE BRACE - SEE DETAILS FOR ATTACHMENT.

KEYNOTES

- MECHANICAL OPENING THRU ROOF - VERIFY SIZE, QUANTITY AND LOCATIONS WITH ARCHITECTURAL & MECHANICAL PLANS. FOR REINFORCEMENT FRAMING AROUND DECK OPENING SEE DETAIL 8 / S501
- HORIZONTAL/CROSS BRIDGING - QUANTITY, SIZES & ANCHORAGE AS REQUIRED BY THE STEEL JOIST SUPPLIER PER SJI STANDARDS. SEE DETAIL 7 / S501
- MECHANICAL UNIT ATOP ROOF - VERIFY SIZE, QUANTITY AND LOCATION WITH ARCHITECTURAL & MECHANICAL PLANS. WEIGHT NOT TO EXCEED THAT SHOWN - IF WEIGHT NOT SHOWN, ASSUME MAX UNIT WEIGHT OF 200 LBS. JOIST SUPPLIER TO DESIGN JOISTS FOR ADDITIONAL WEIGHT AS REQUIRED. FOR SUPPORT OF MECH UNIT ON ROOF SEE DETAIL 5 / S501

KEYNOTES - SNOW DRIFT



1 S102 Roof Framing Plan
1/8" = 1'-0"
DECK BRG. EL. = 112'-8" UON



DRAWING HISTORY

NO.	DESCRIPTION	DATE
	CONSTRUCTION DOCUMENTS	01/05/2025

DRAWN BY: TO/AF JN: 24-054

Roof Framing Plan

SHEET
S102



TURTLE MOUNTAIN COMMUNICATIONS NEW BUILDING

BOTTINEAU, NORTH DAKOTA

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MECHANICAL


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ELECTRICAL


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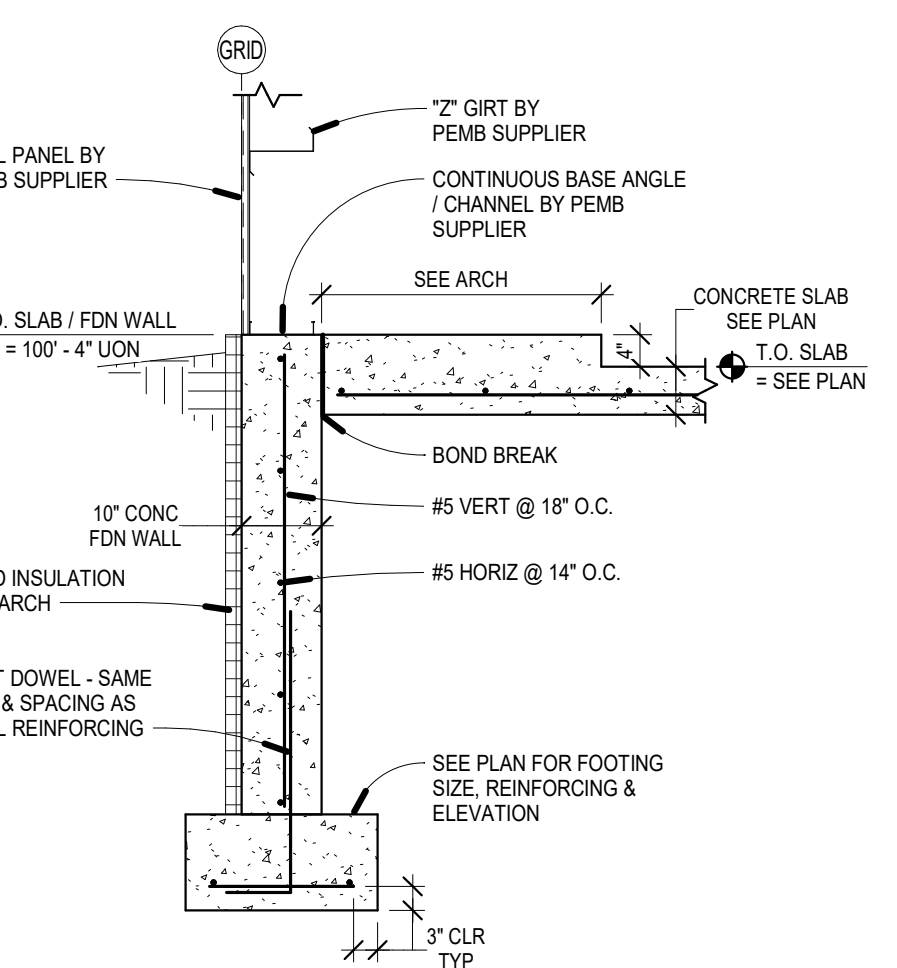
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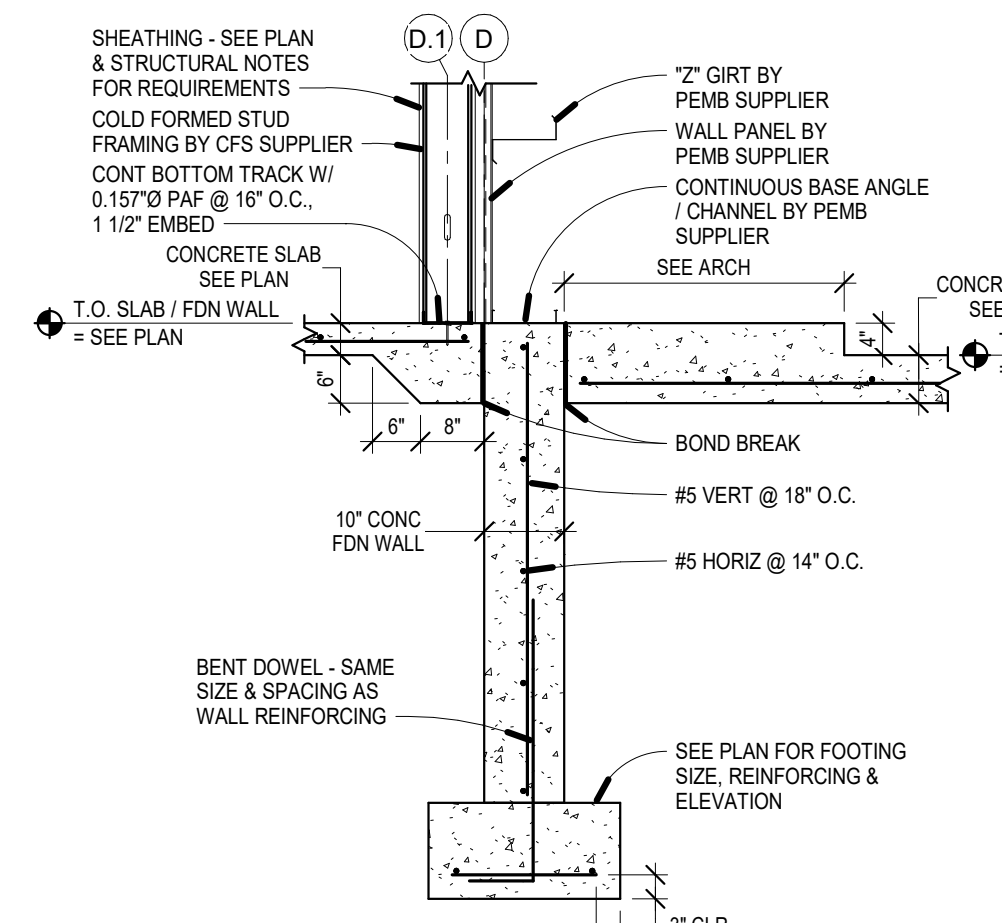
100 S301 Trench Drain
1" = 1'-0"




14 S301 Foundation Wall
1/2" = 1'-0"

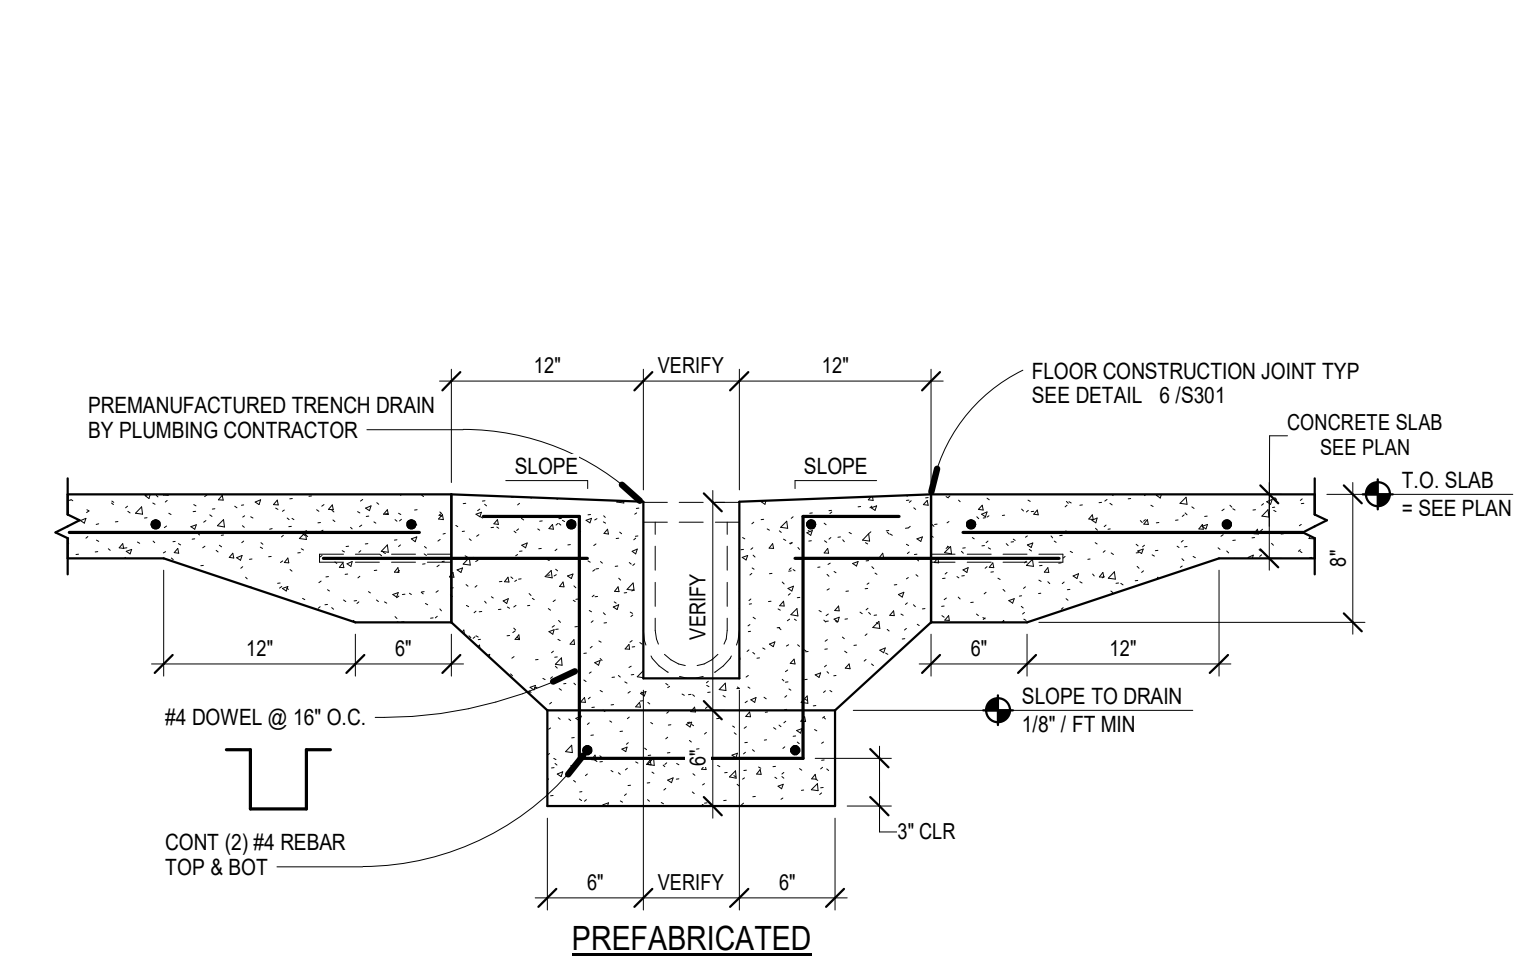


15 S301 Foundation Wall
1/2" = 1'-0"

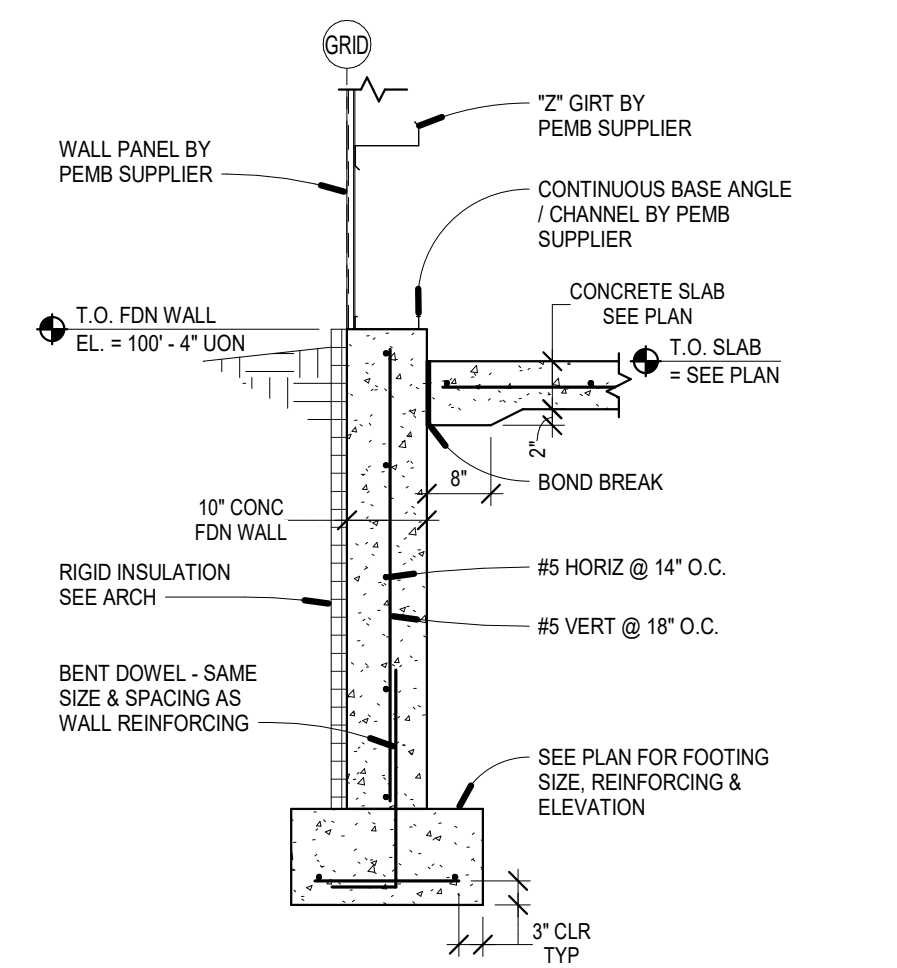


16 S301 Foundation Wall
1/2" = 1'-0"

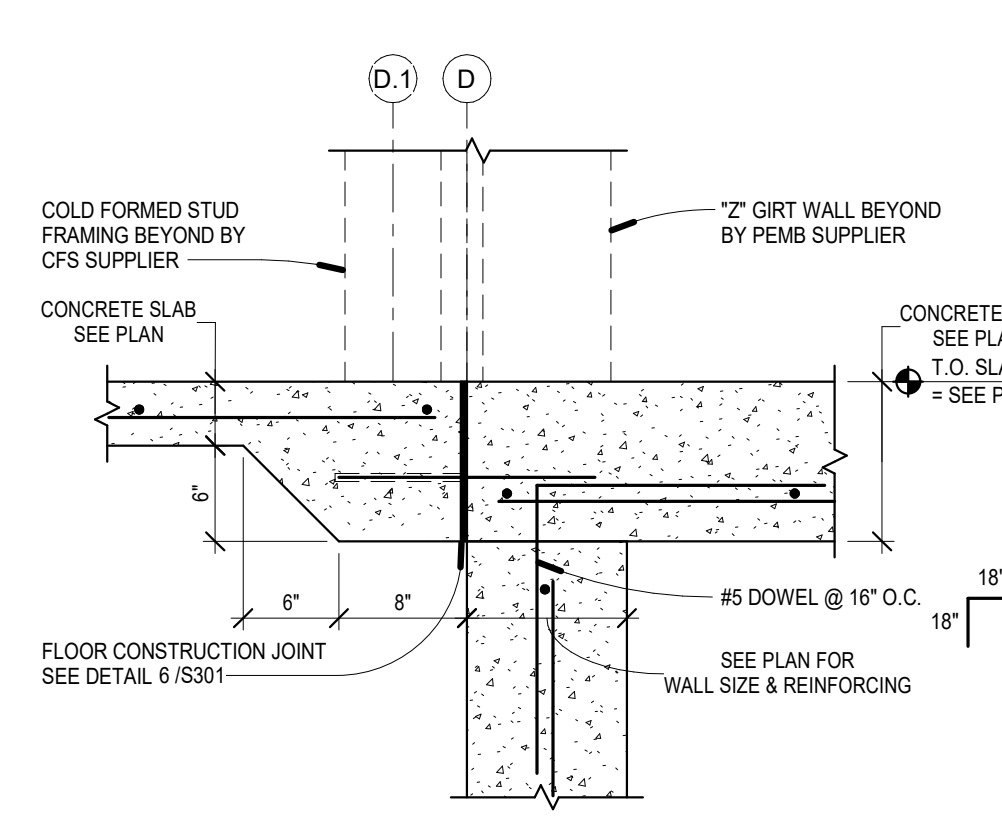


17 S301 Slab @ Door Holdout
1" = 1'-0"

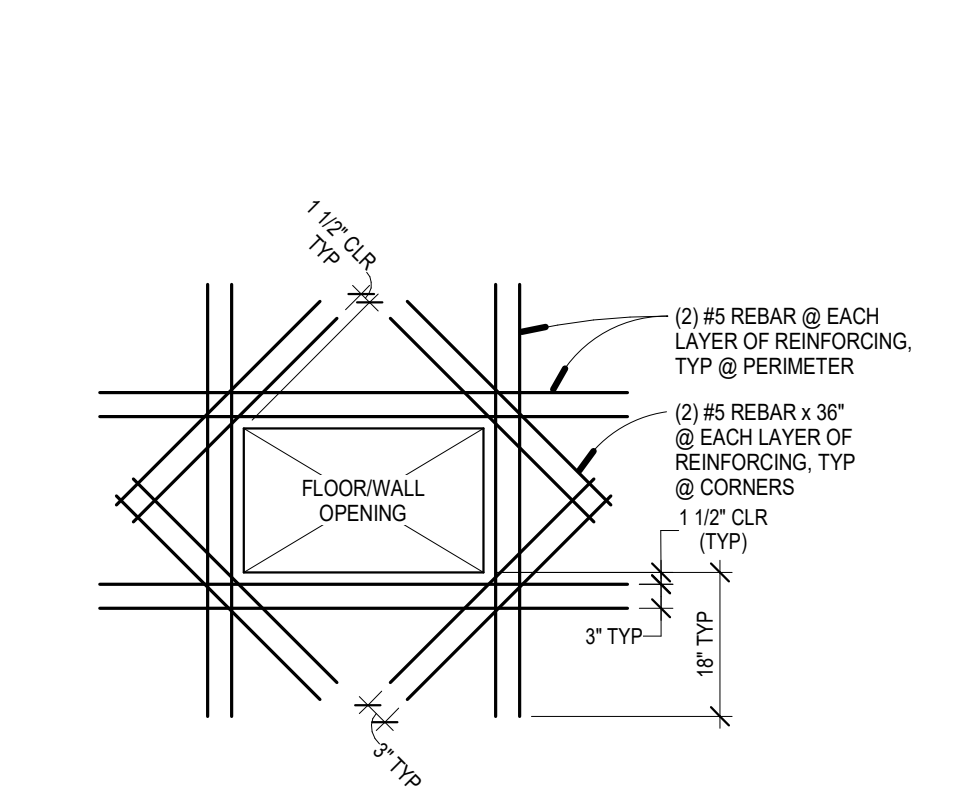


11 S301 Typical Entry Stoop
1/2" = 1'-0"

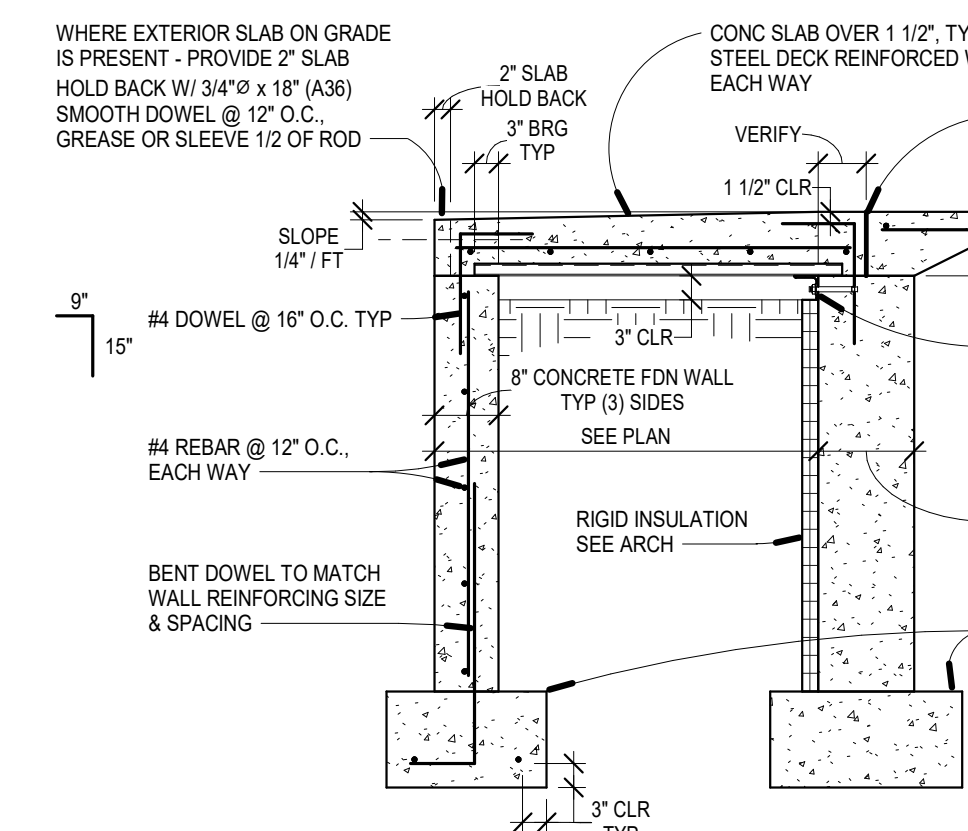


12 S301 Foundation Wall @ Overhead Door
1/2" = 1'-0"

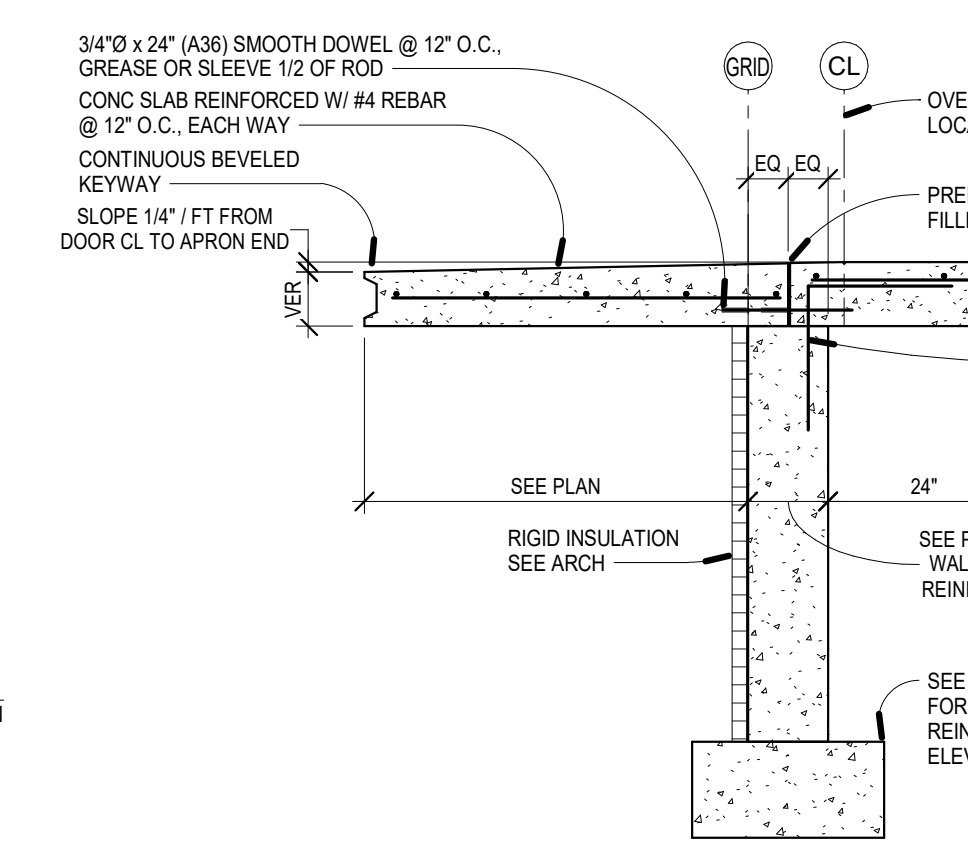


13 S301 Foundation Wall
1/2" = 1'-0"

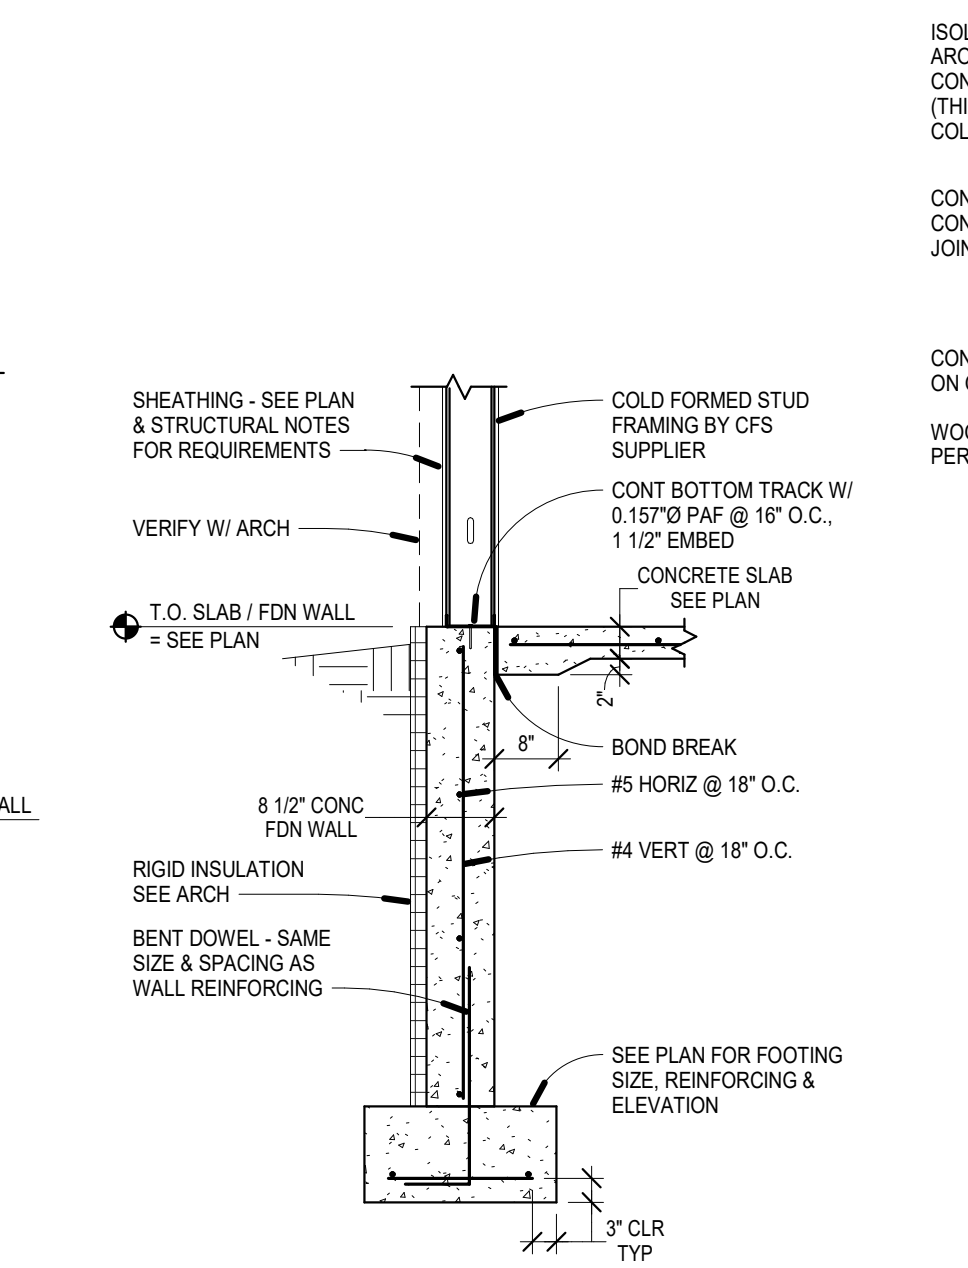


13 S301 Foundation Wall
1/2" = 1'-0"

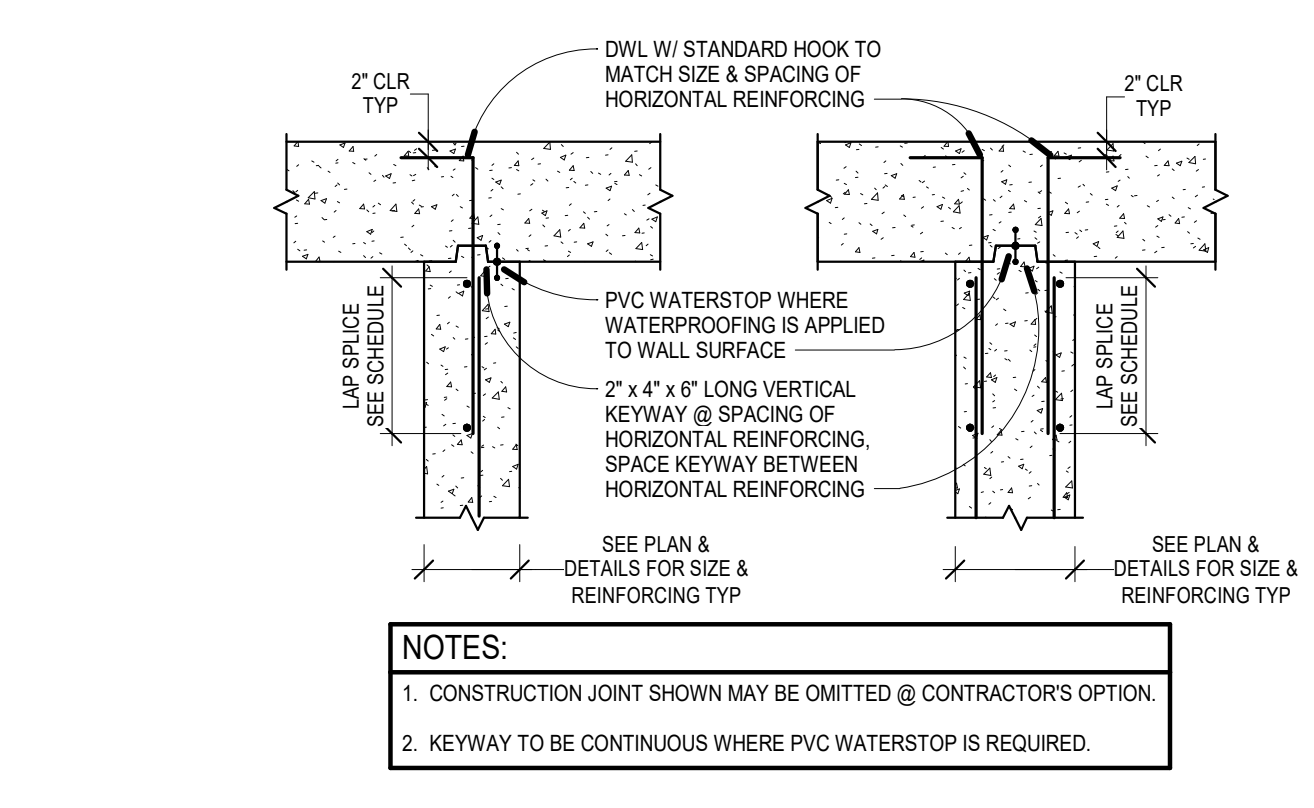


5 S301 Wall Intersection
NO SCALE

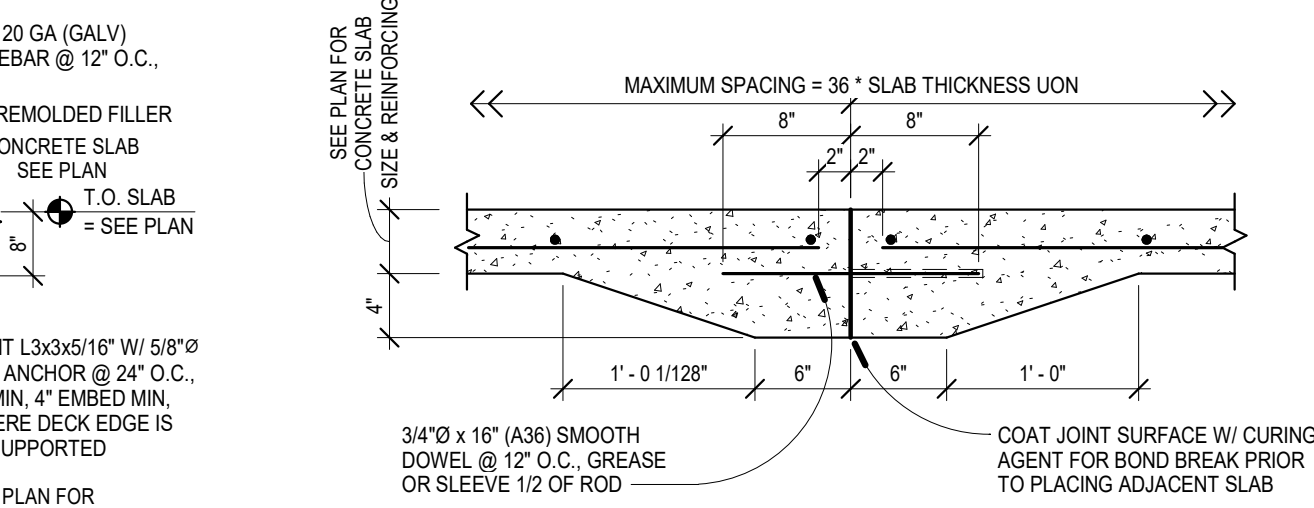


6 S301 Floor Construction Joint (CCJ)
NO SCALE

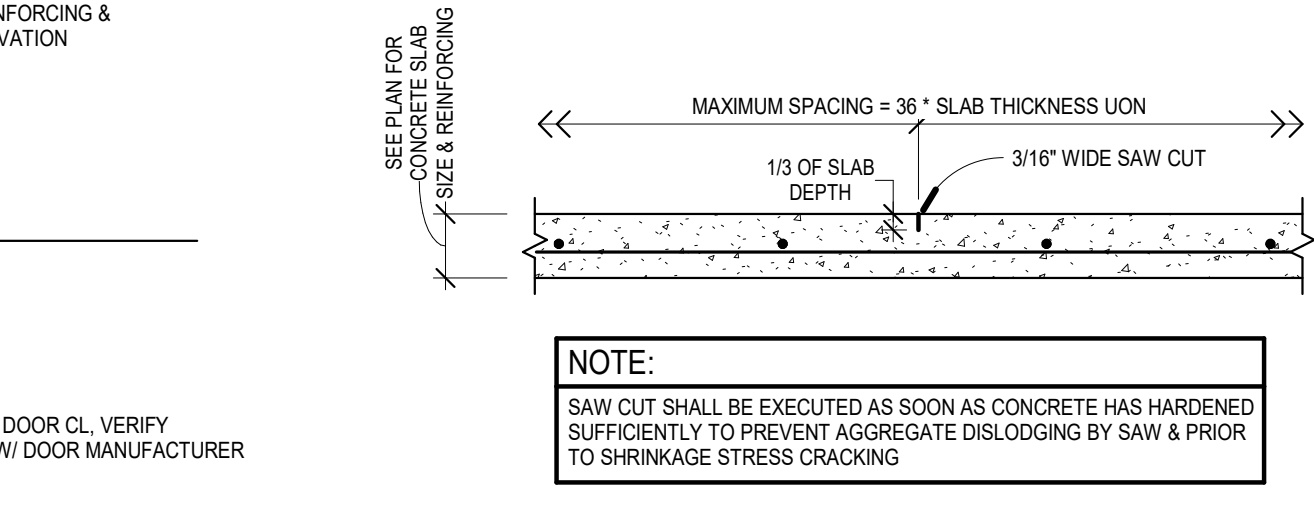


7 S301 Floor Control Joint (CJ)
NO SCALE

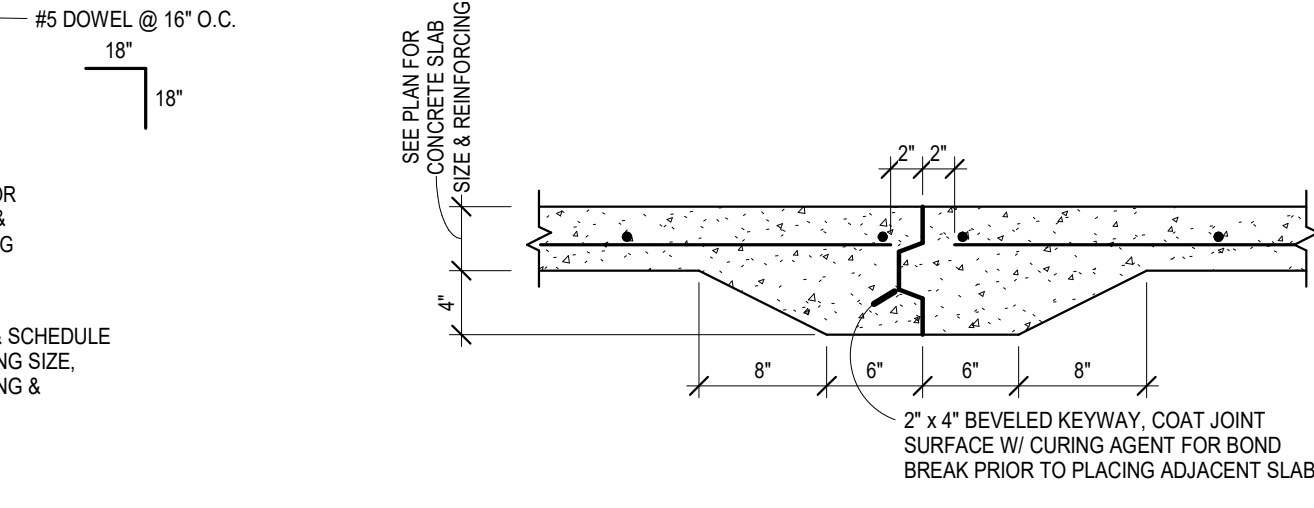


8 S301 Isolation Key Joint
NO SCALE

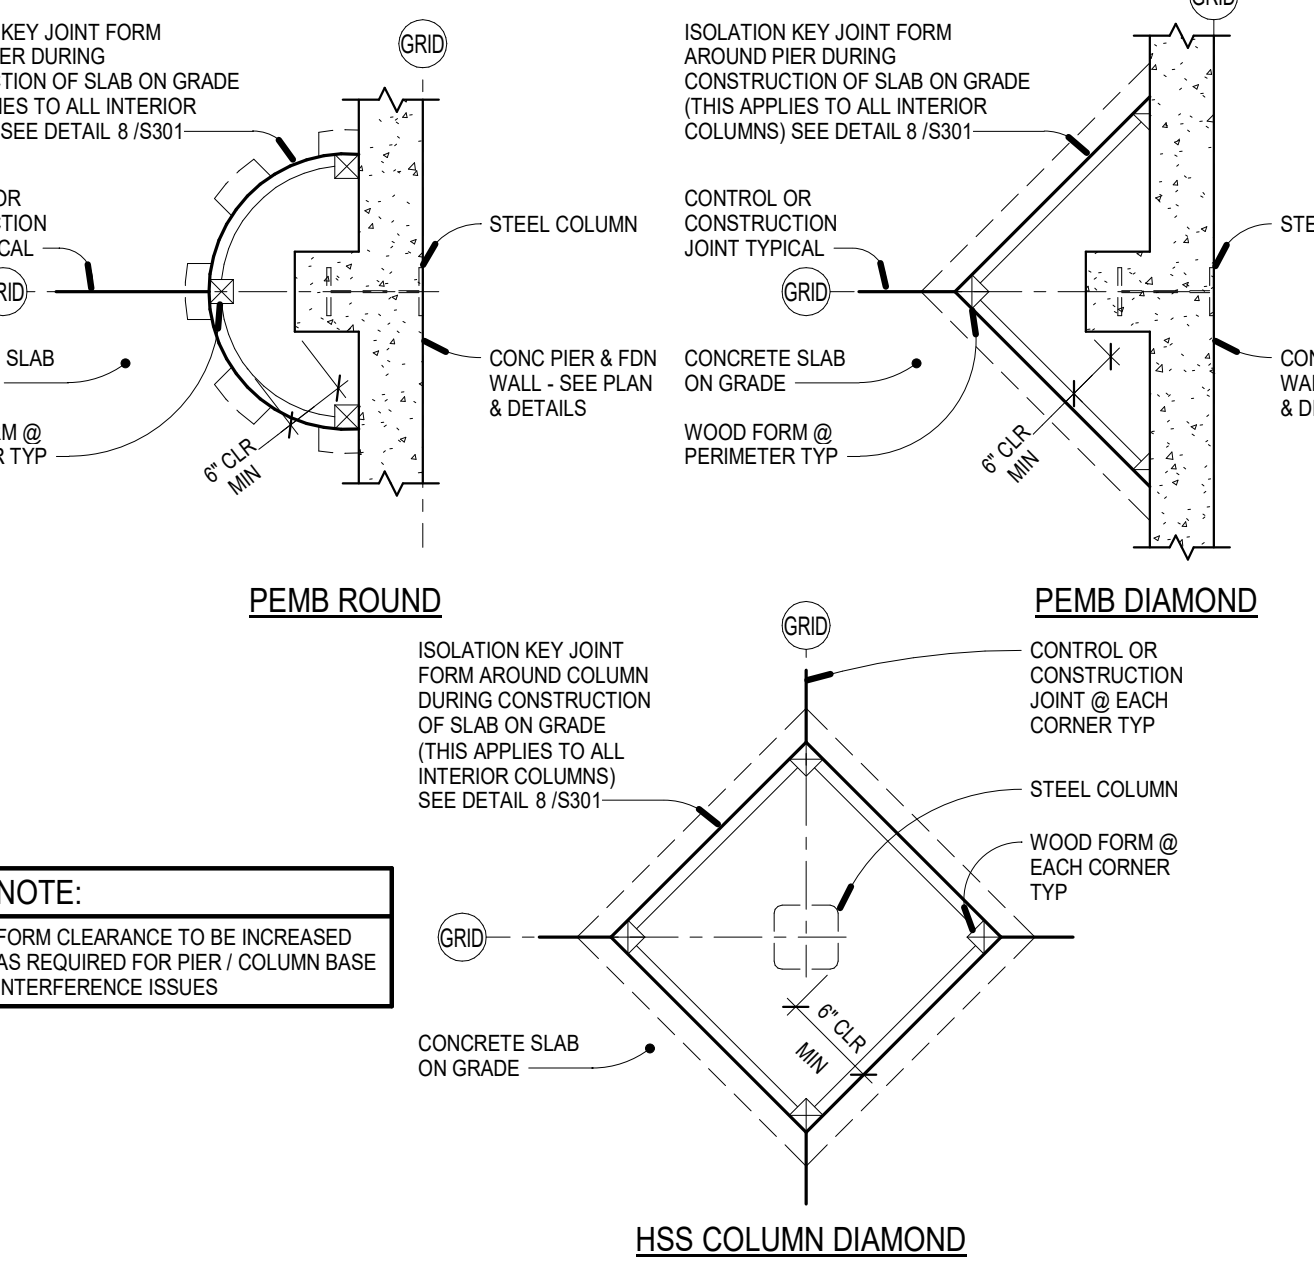


9 S301 Pier / Column Isolation Joint
1" = 1'-0"

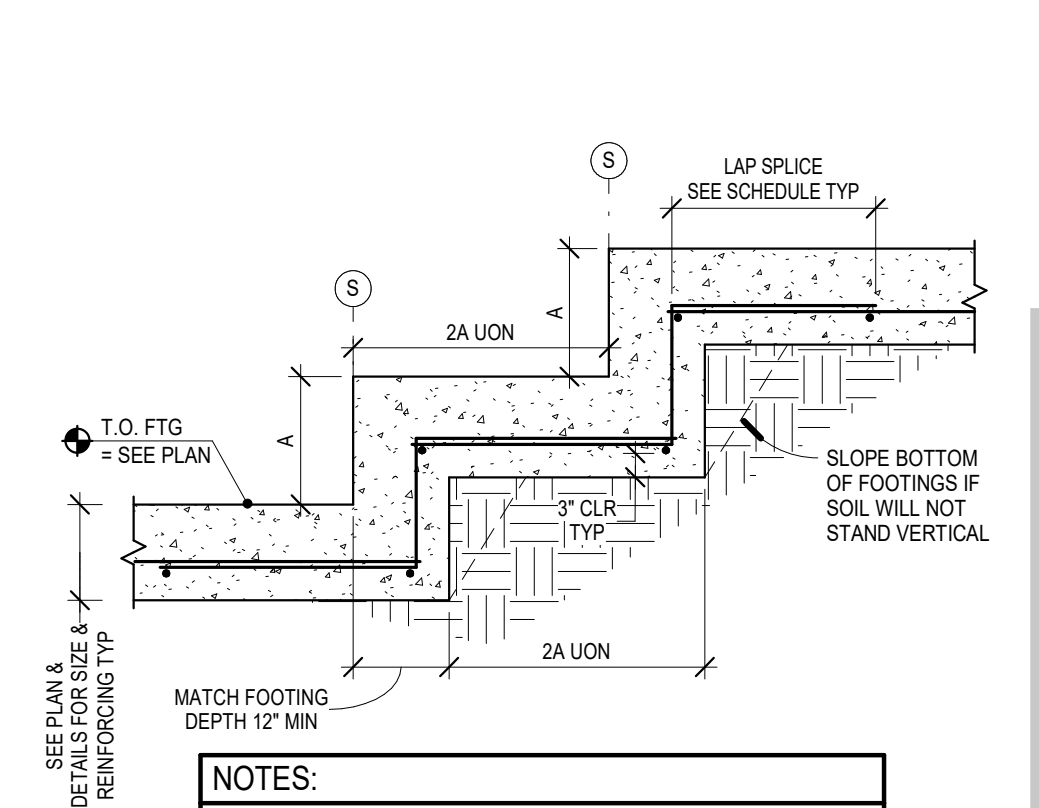


1 S301 Stepped Wall Footing
NO SCALE

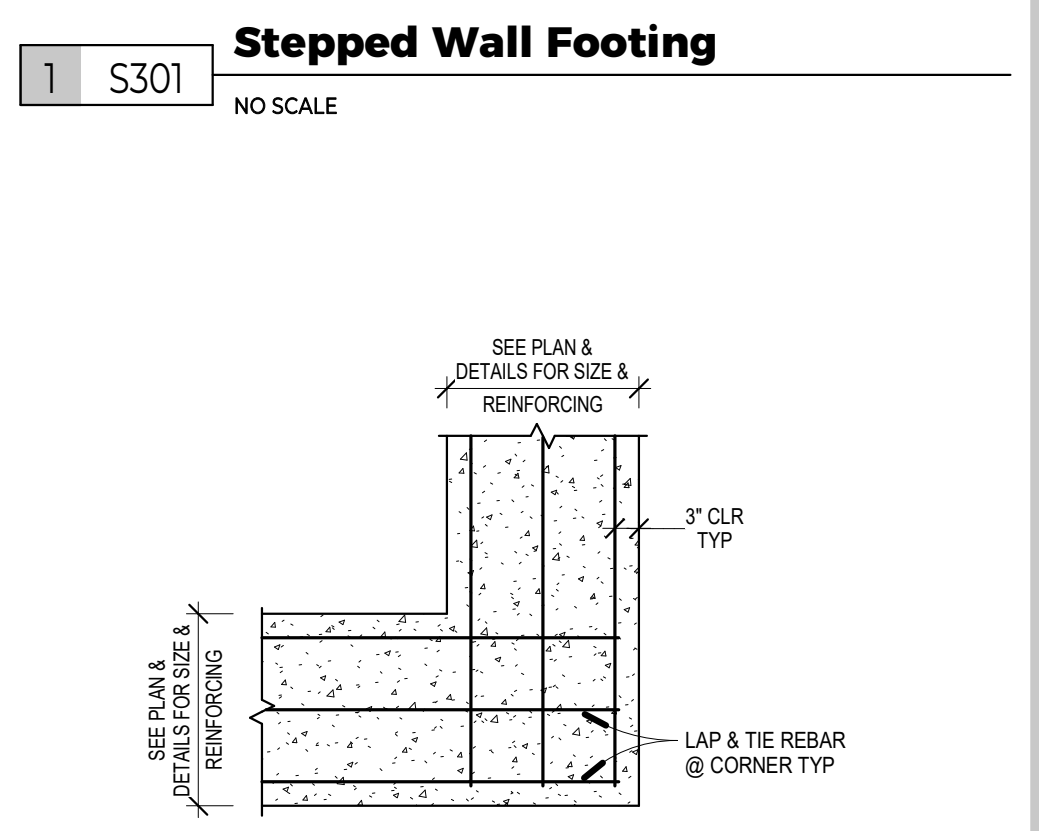

2 S301 Footing Corner
NO SCALE

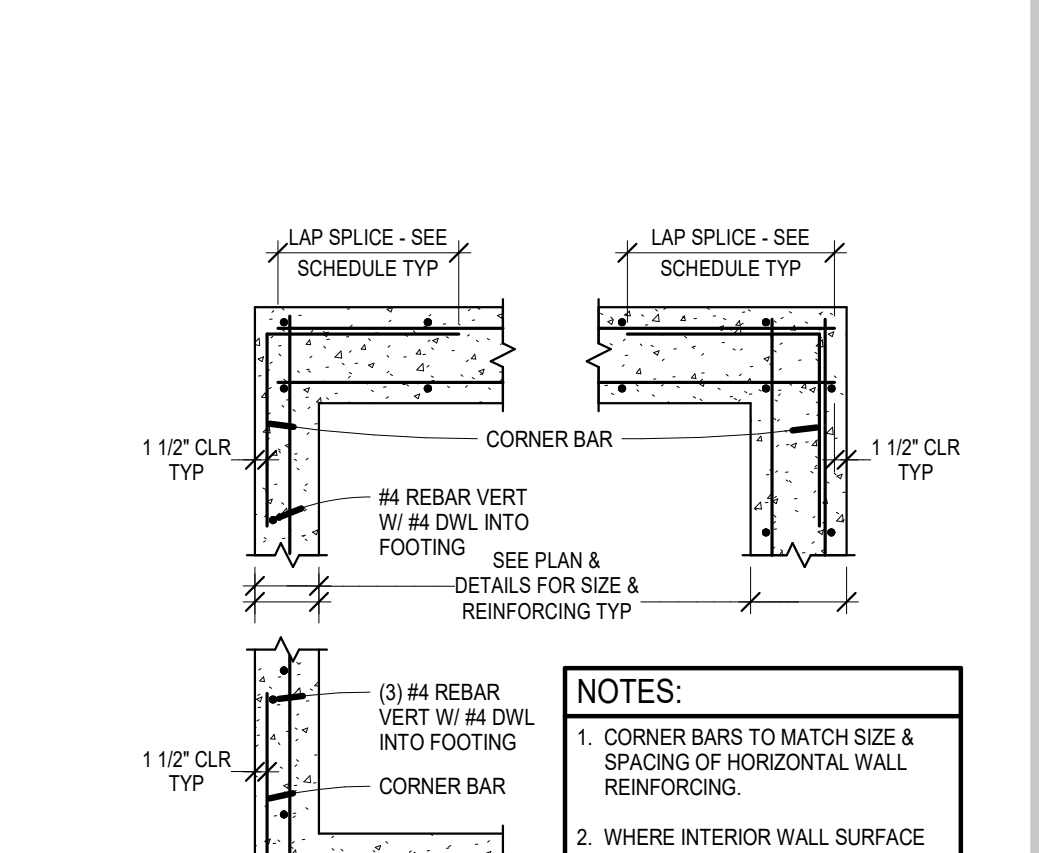

3 S301 Wall Corner Reinforcing
NO SCALE

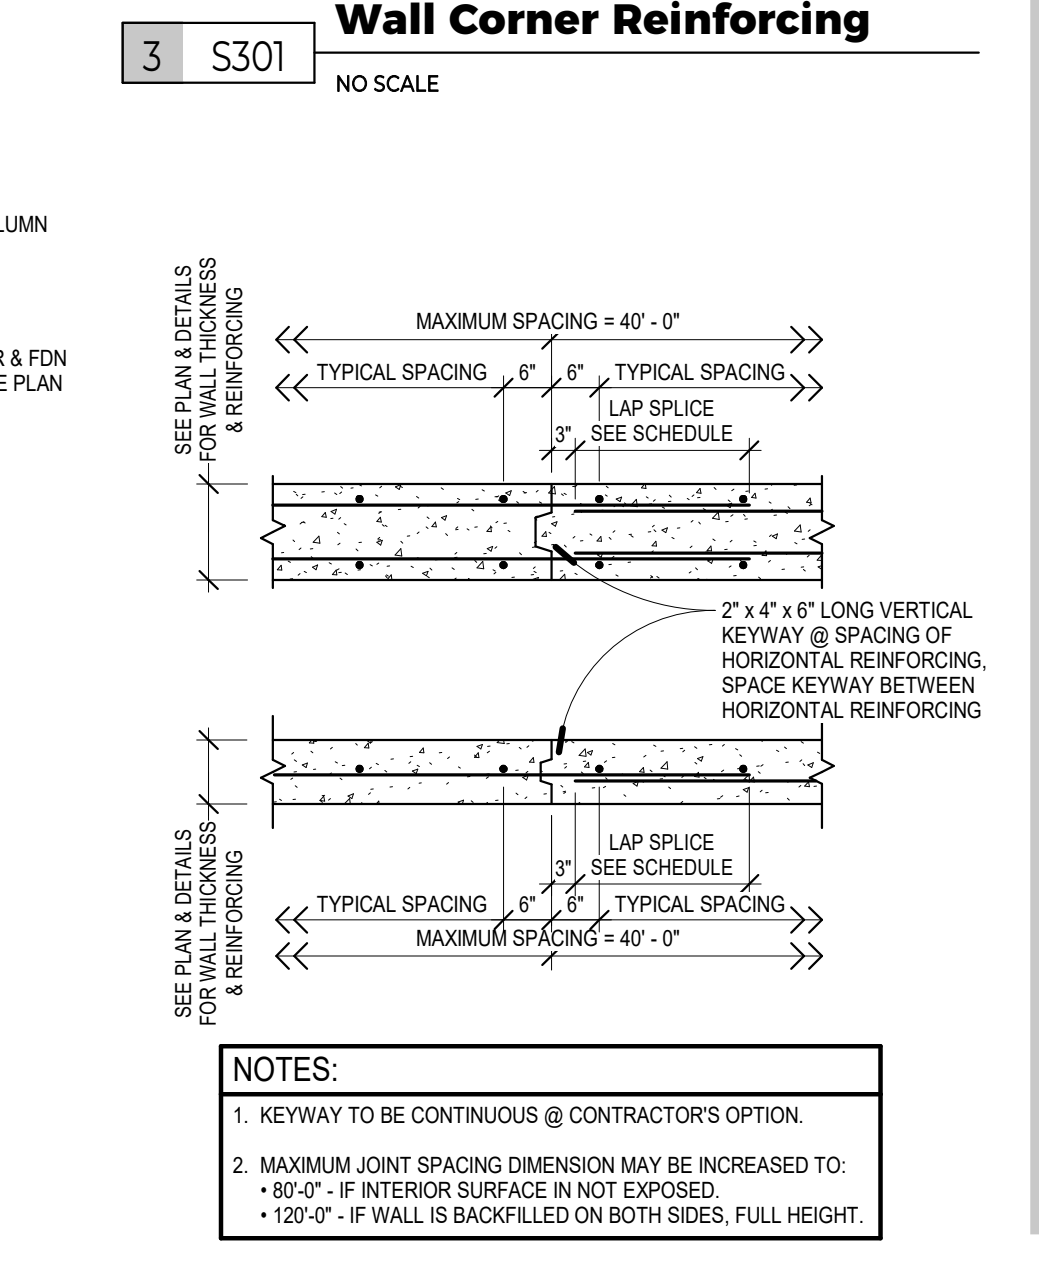

4 S301 Wall Construction Joint (WCJ)
NO SCALE

Autodesk Docs:J24-054 UTM:24-054 UTM: Structural.rvt

1/15/2025 4:54:35 PM




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NO.	DESCRIPTION	DATE
	CONSTRUCTION DOCUMENTS	01/15/2025


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Foundation Details


SHEET
S301




5 S302 Foundation Wall / Pier
1/2" = 1'-0"

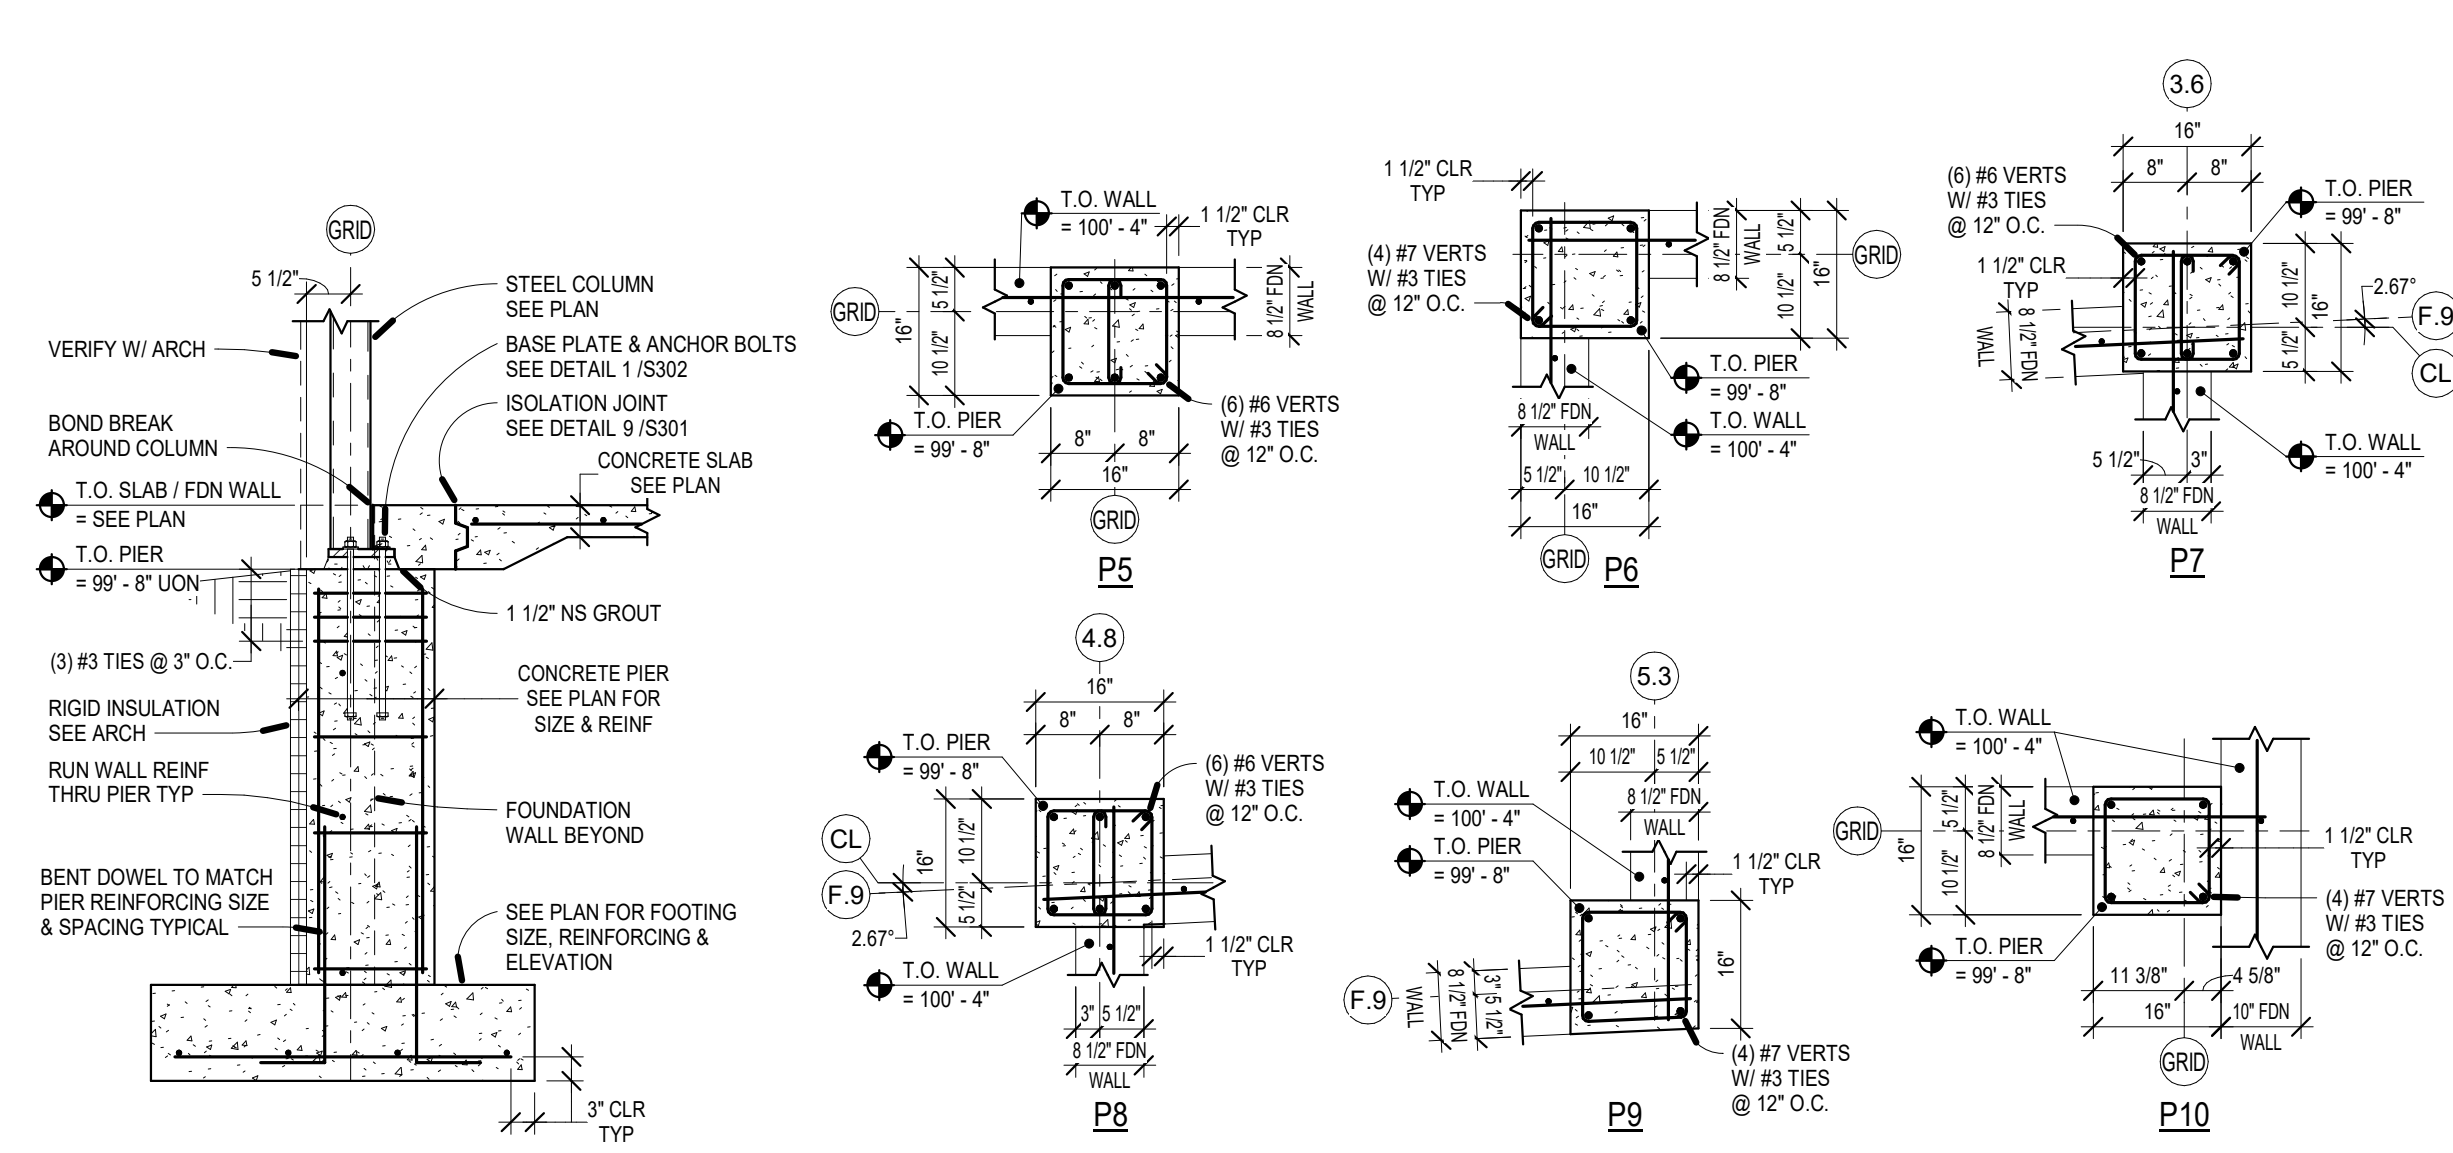

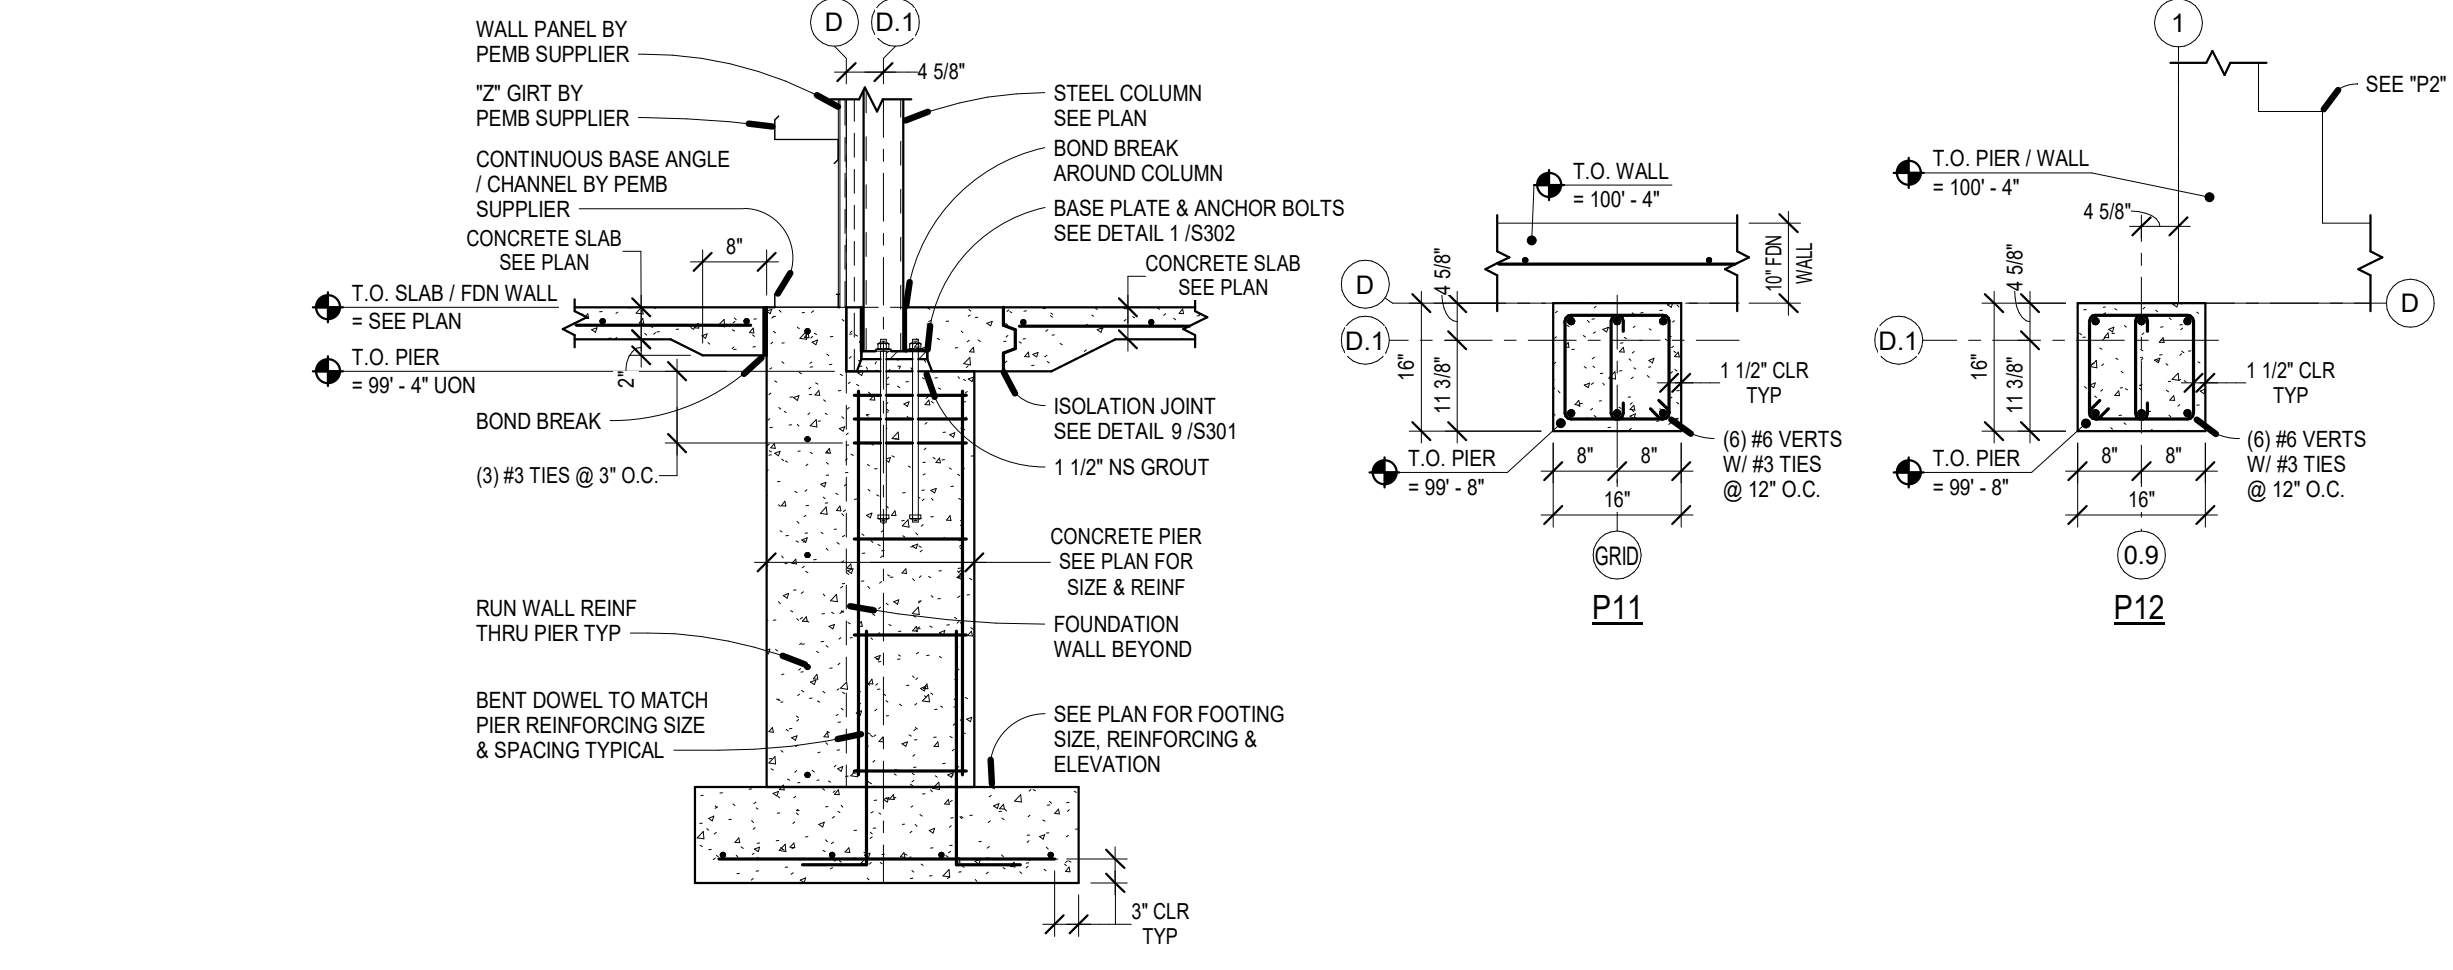
6 S302 Foundation Wall / Pier
1/2" = 1'-0"

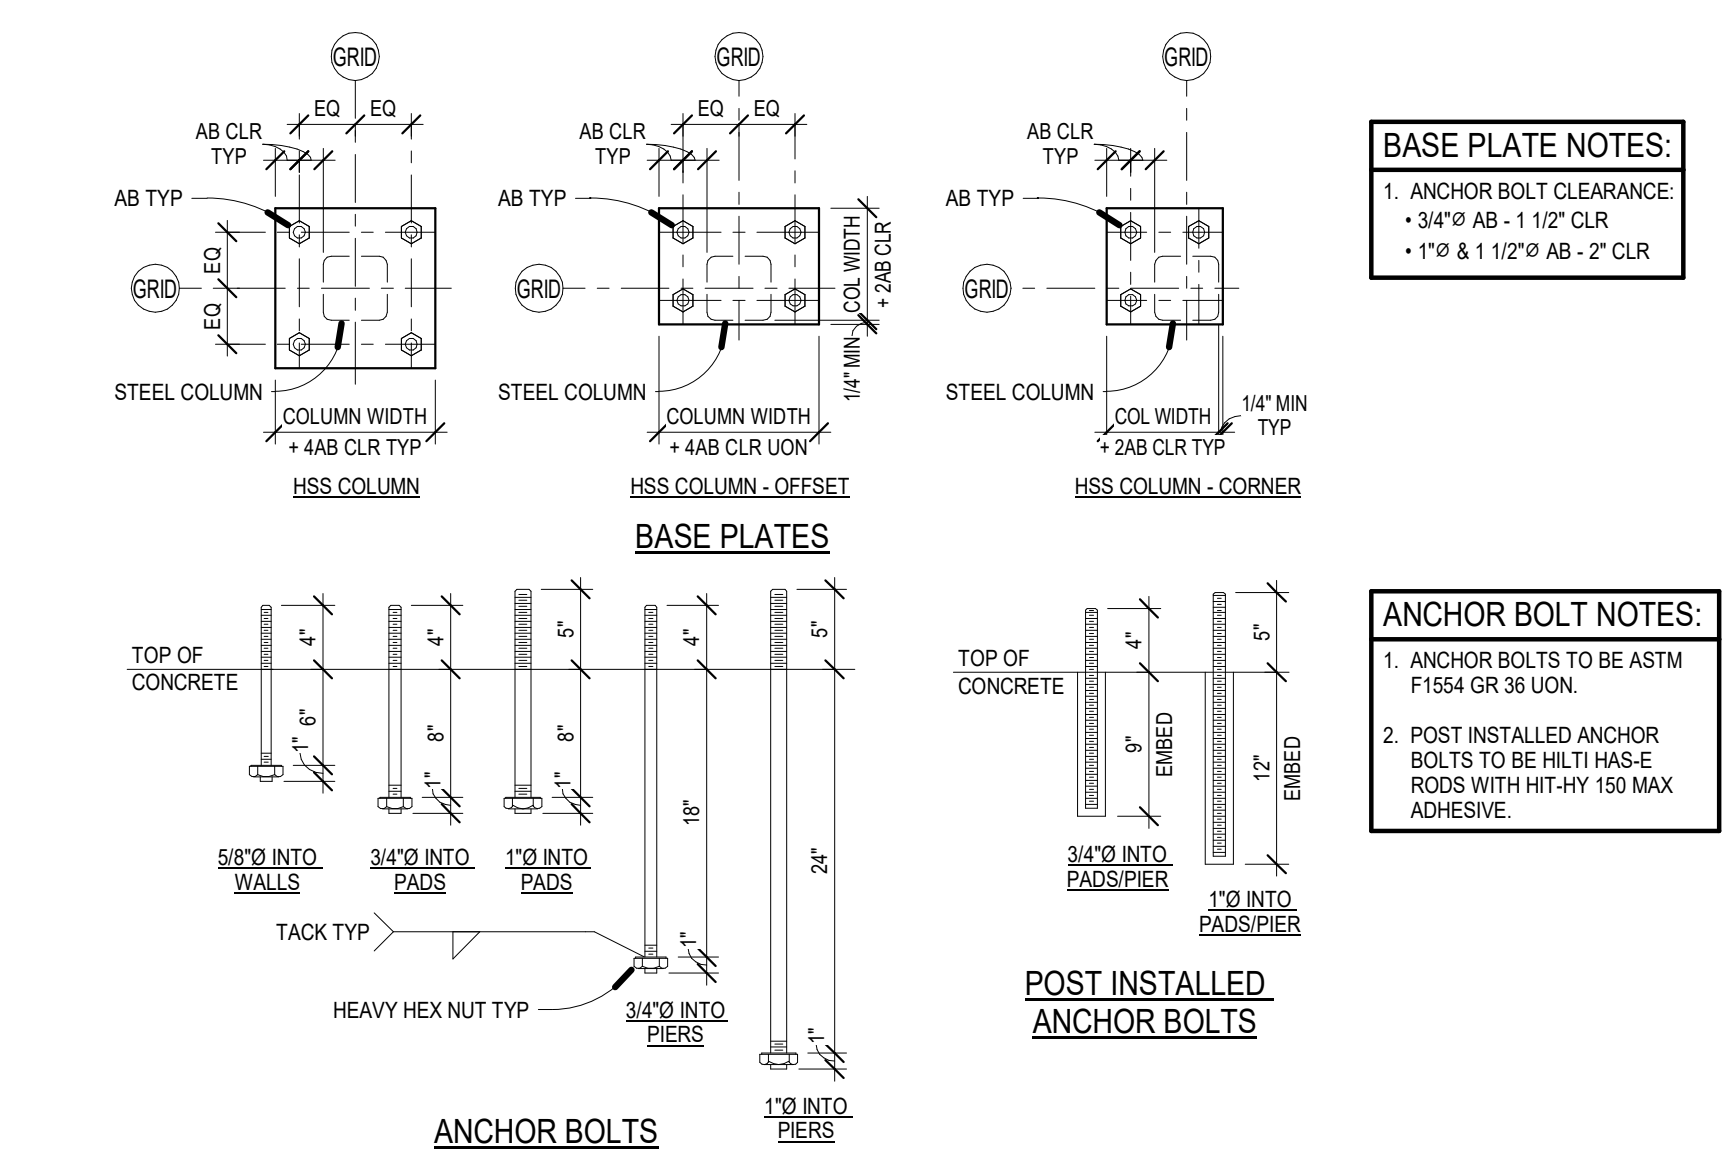


1 S302 Anchor Bolts
1" = 1'-0"

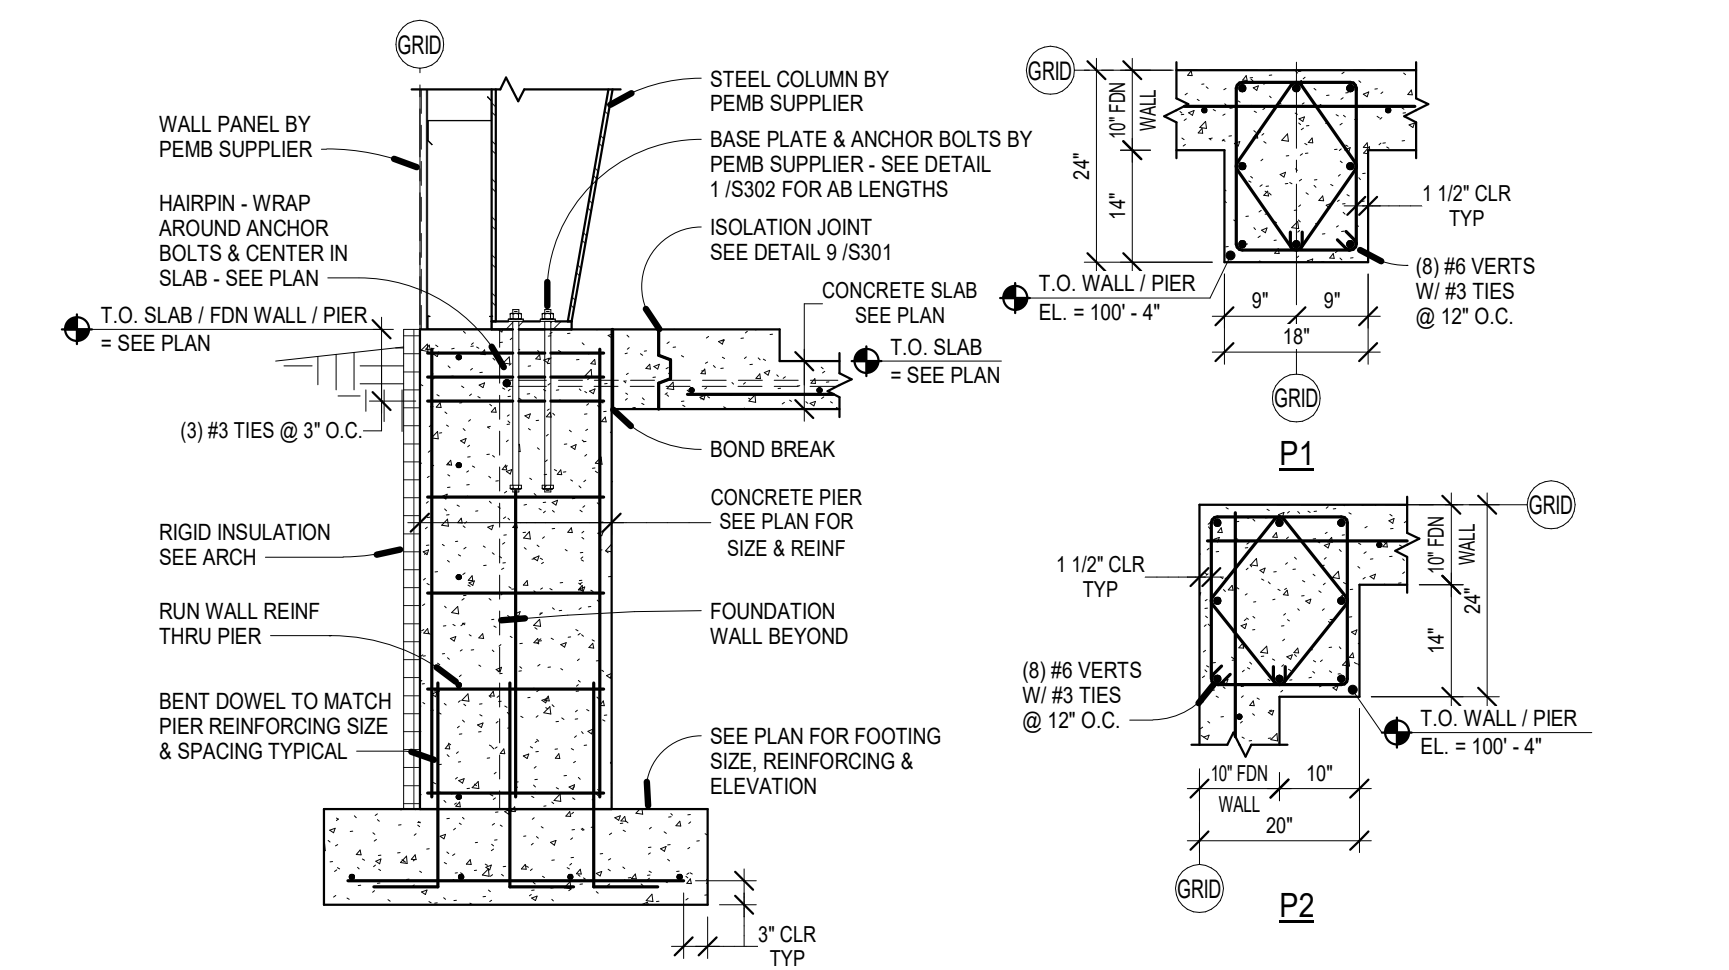

2 S302 Pier Section - Sidewall
1/2" = 1'-0"

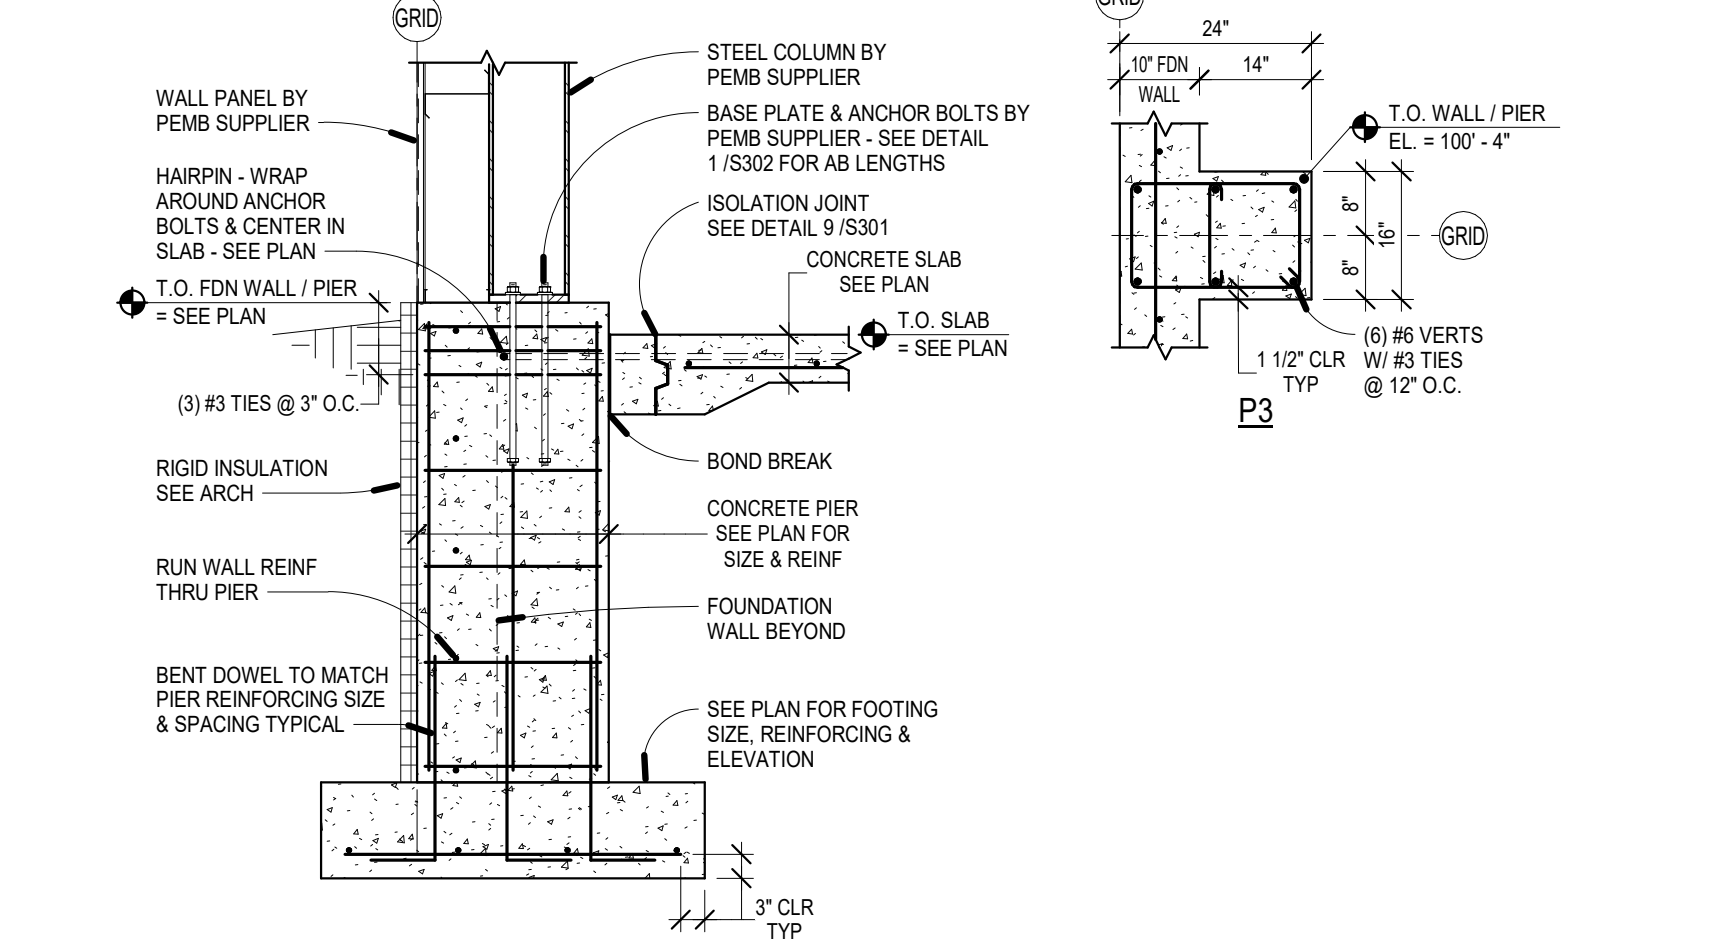

3 S302 Pier Section - Endwall
1/2" = 1'-0"

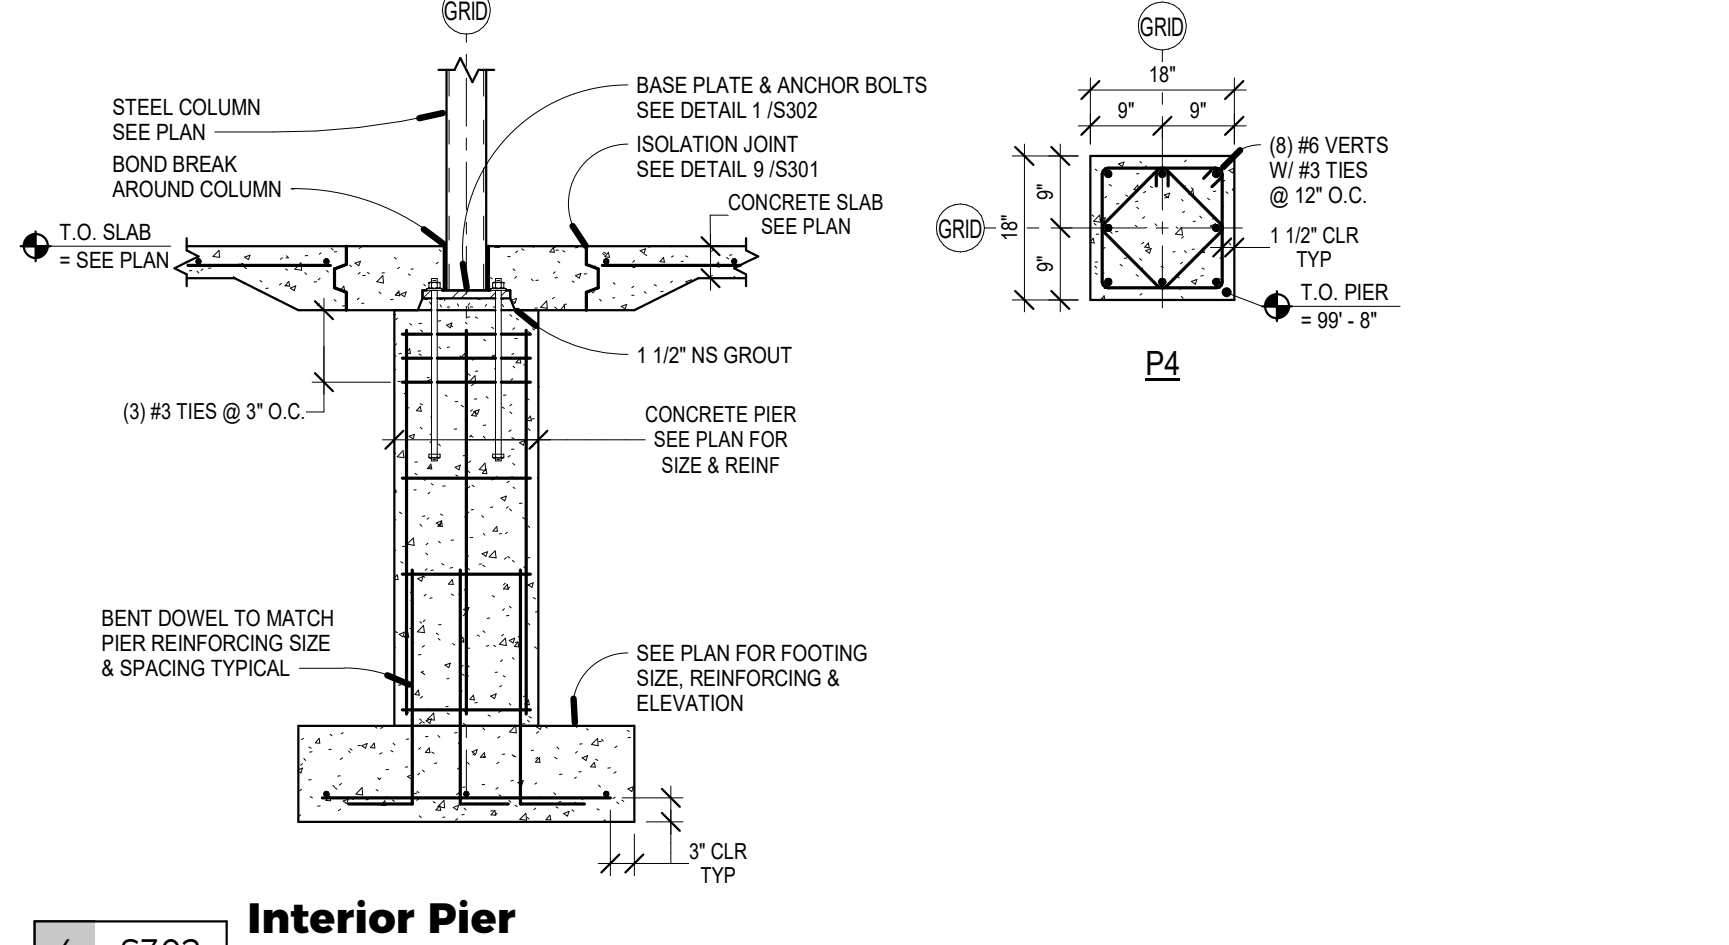

4 S302 Interior Pier
1/2" = 1'-0"

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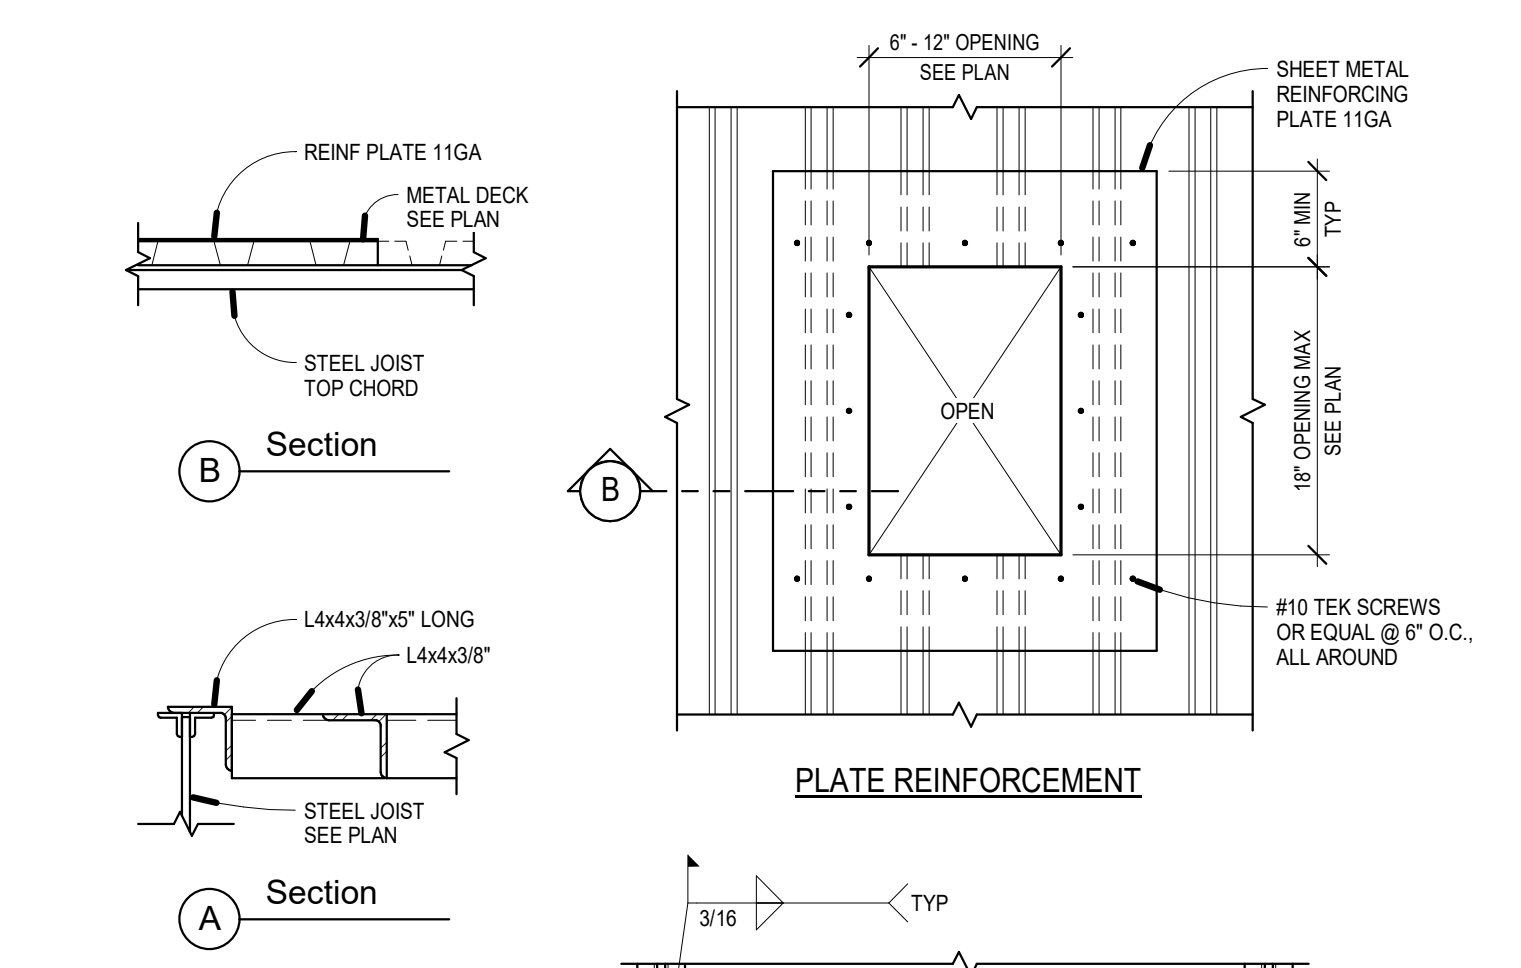
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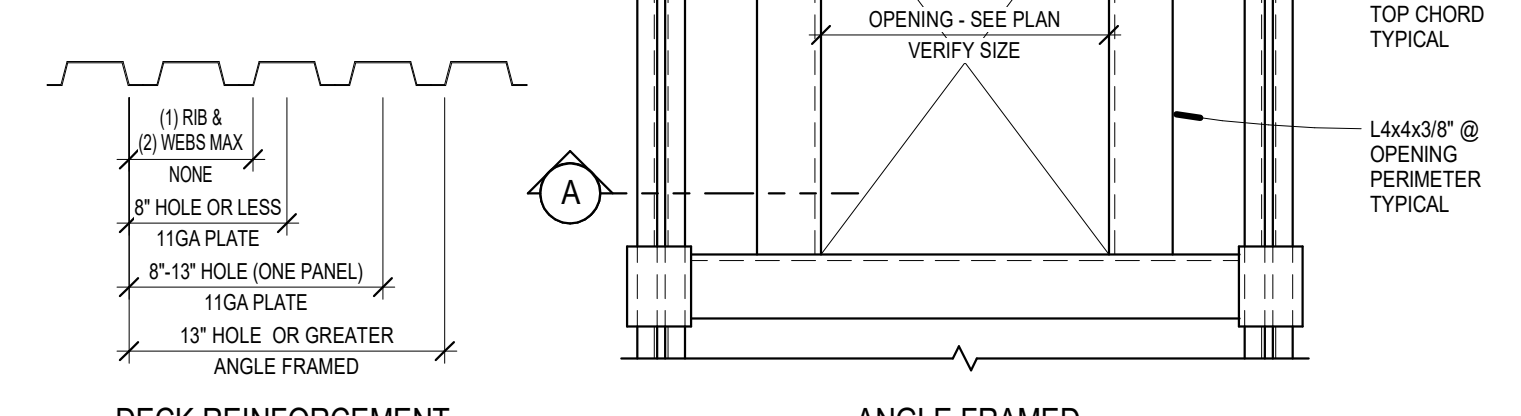
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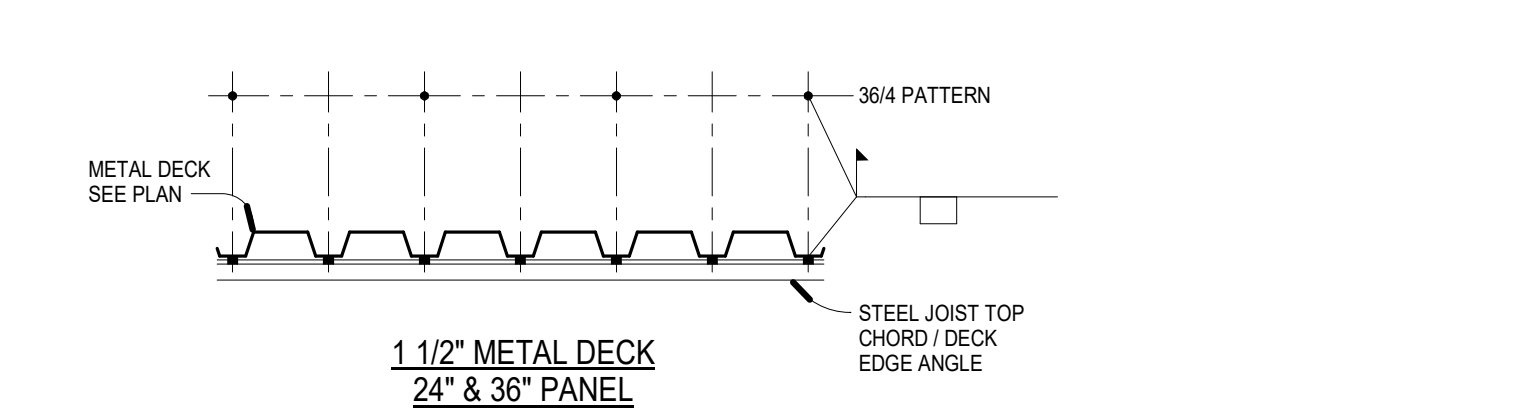


NOTE:
NO REINFORCEMENT REQUIRED @ OPENINGS 6" OR LESS, DIAGONAL OR SQUARE.



8 S501 Roof Deck Opening (20 & 22 GA DECK)

NO SCALE




NOTES:

- SEE PLAN FOR DECK FASTENING PATTERN @ SUPPORTS.
 - 36" WIDE DECK SHEETS SHALL BE 364 MINIMUM
 - 32" WIDE DECK SHEETS SHALL BE 323 MINIMUM
 - 24" & 24 1/2" WIDE DECK SHEETS SHALL BE 243 MINIMUM
 - 3" DECK - 24" WIDE DECK SHEETS SHALL BE 244 MINIMUM
- DECK ENDS SHALL BE FASTENED TO SUPPORTS AS INDICATED.
 - 1 1/2" DECK: LAP DECK ENDS 2" MINIMUM AND FASTEN WITH THE MAXIMUM ROW FASTENING PATTERN.
 - 2", 3" & 3 1/2" DECK: BUTT DECK ENDS PER THE MANUFACTURER'S RECOMMENDATIONS AND FASTEN WITH THE MAXIMUM ROW FASTENING PATTERN.
- SUPPORT FASTENERS SHALL BE PUDDLE WELDS AS INDICATED. IN LIEU OF WELDS THE CONTRACTOR MAY USE HILTI STEEL DECK FASTENING SYSTEM W/ THE SAME PATTERN. HILTI FASTENERS ARE AS FOLLOWS:
 - BAR JOIST/STRUCTURAL STEEL IF $3/8"$, USE X-ENP-24
 - BAR JOIST/STRUCTURAL STEEL IF $3/8"$, USE X-ENP-19L15
- SIDLAP FASTENERS SHALL BE HILTI S-SLC 01 M HWH SIDELAP CONNECTORS (BUTTON PUNCH FOR 2" COMPOSITE FLOOR DECK) - SEE PLAN FOR REQUIREMENTS. QUANTITY OF FASTENERS INDICATED SHALL BE SPACED EQUALLY ALONG DECK SPAN BETWEEN SUPPORTS. WHEN SPAN EXCEEDS 5'-0", SIDELAPS SHALL BE FASTENED @ MID SPAN OR 3'-0" INTERVALS (WHICHEVER IS SMALLER).


9 S501 Deck Fastening

NO SCALE

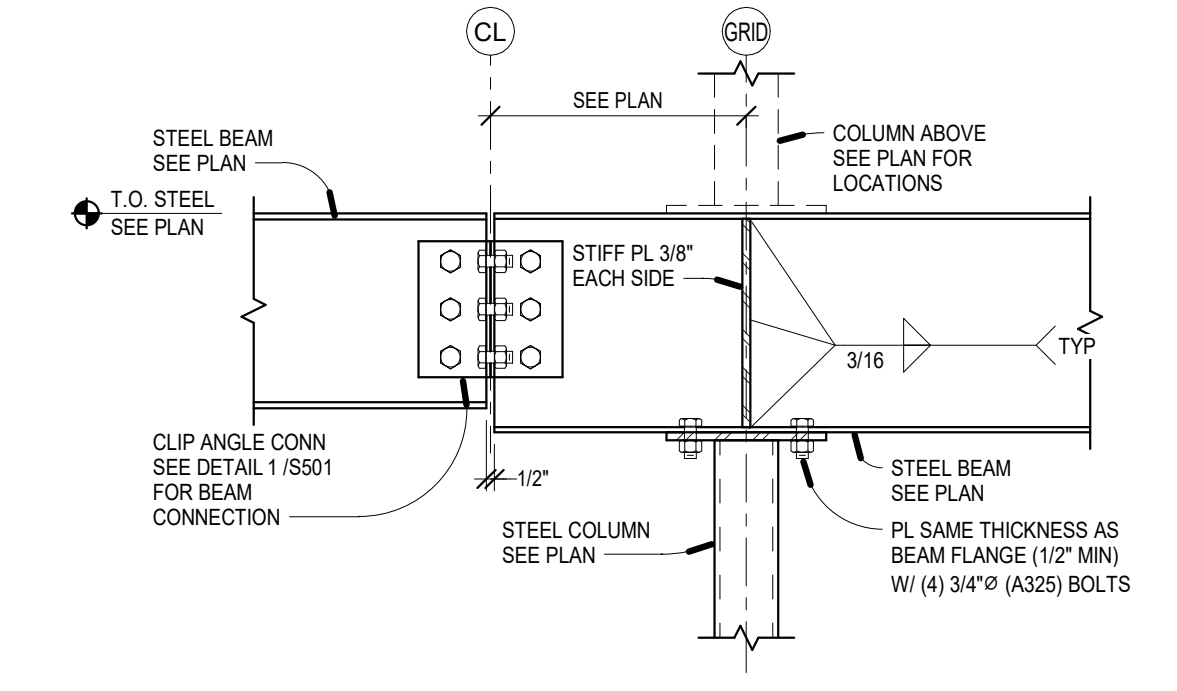


4 S501 Beam Cantilevered Bearing

NO SCALE

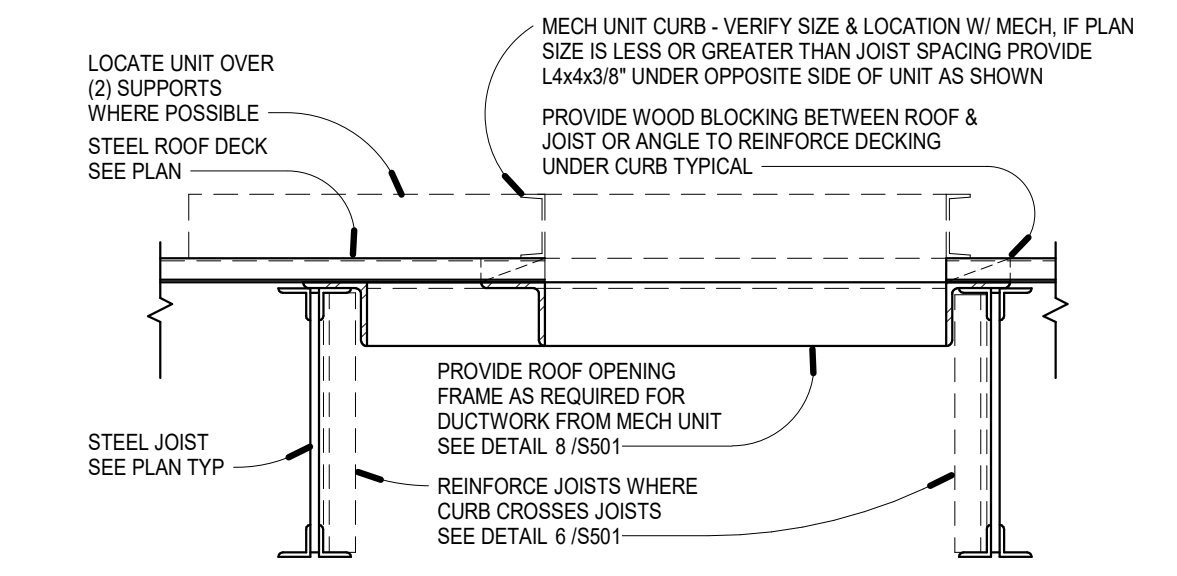




5 S501 Mechanical Unit Support

NO SCALE

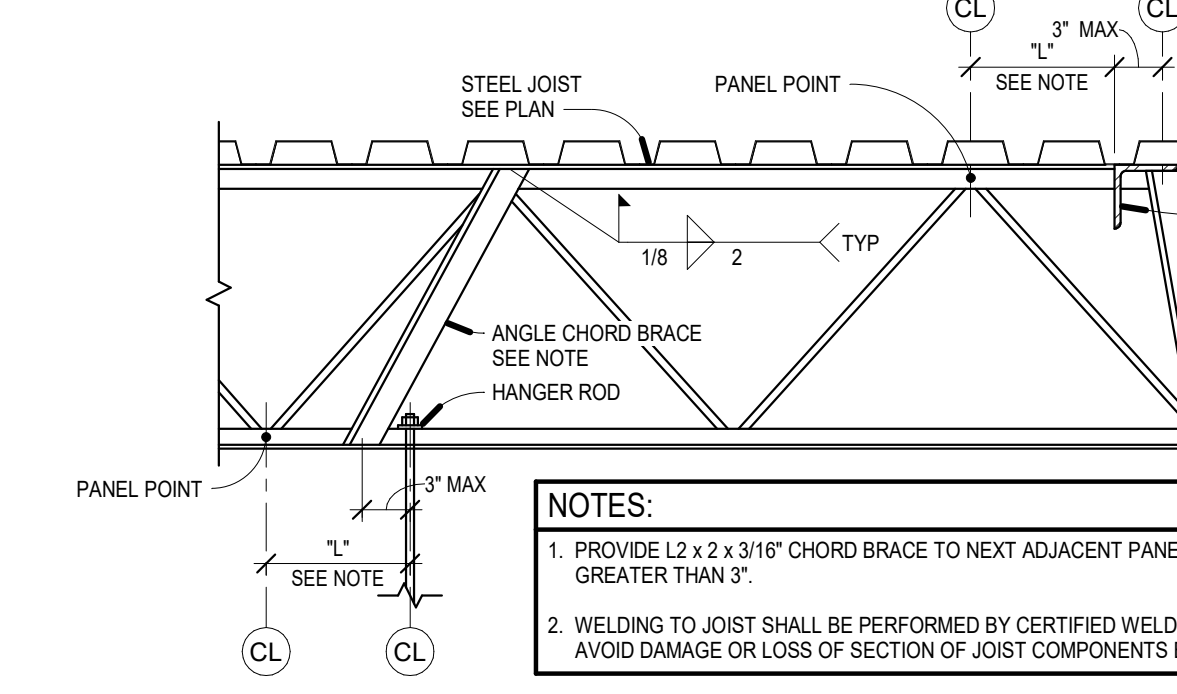

6 S501 Joist Reinforcement

NO SCALE

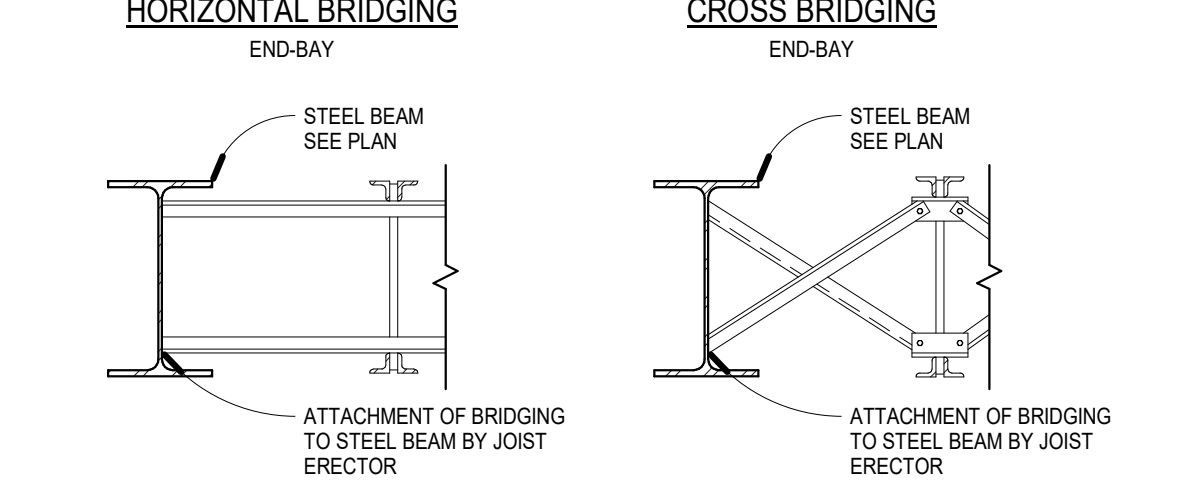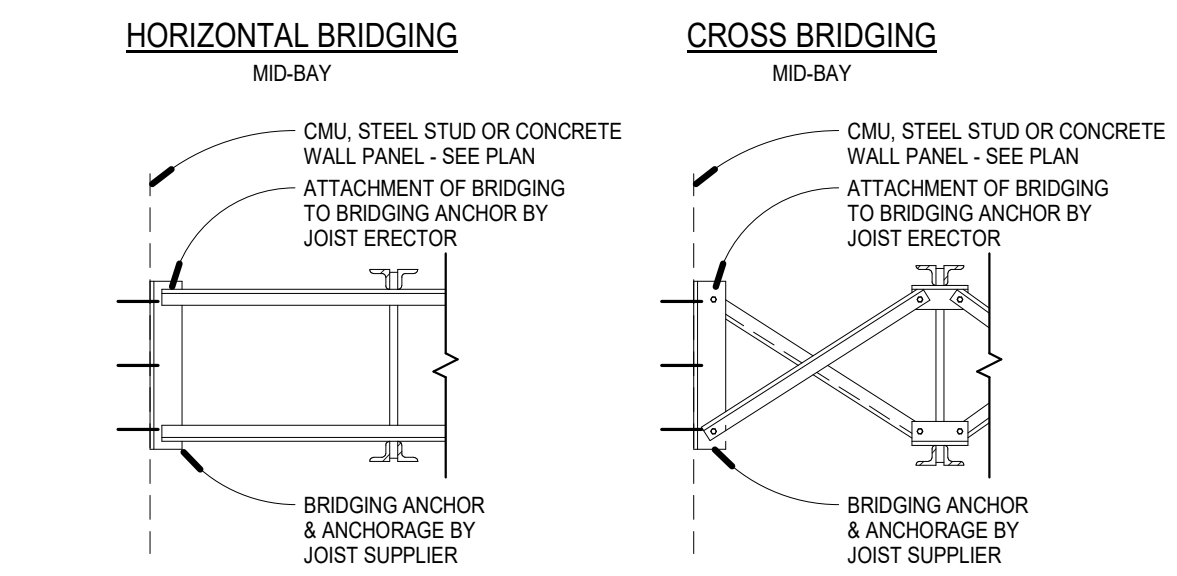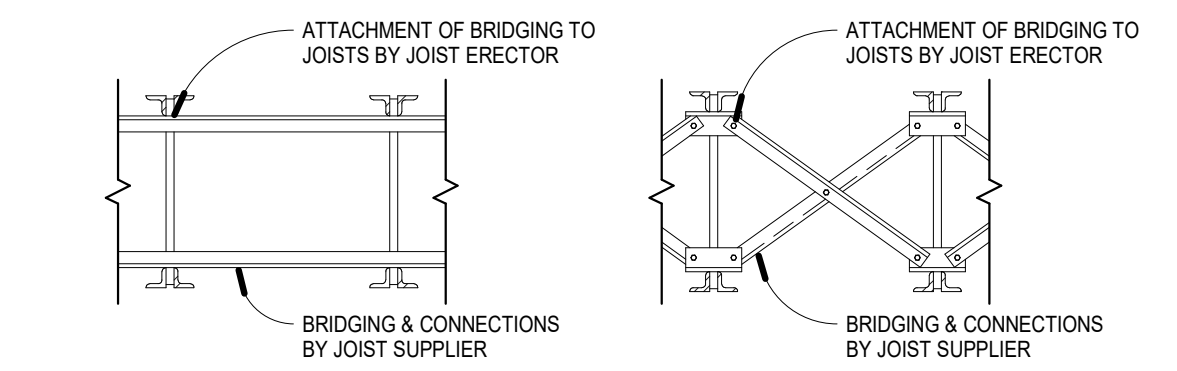


NOTES:

- ALL BRIDGING & CONNECTIONS TO BE DESIGNED BY JOIST SUPPLIER AS PER SJI STANDARDS.
- DO NOT WELD BRIDGING TO WEB MEMBERS.
- DO NOT HANG ANYTHING FROM BRIDGING.
- JOIST SUPPLIER IS TO PROVIDE ALL BRIDGING AND ACCESSORIES FOR PROPER INSTALLATION AS PER SJI STANDARDS.
- BRIDGING CLIPS MAY VARY FROM THAT SHOWN IN DETAILING.

7 S501 Typical Joist Bridging Anchorage

NO SCALE

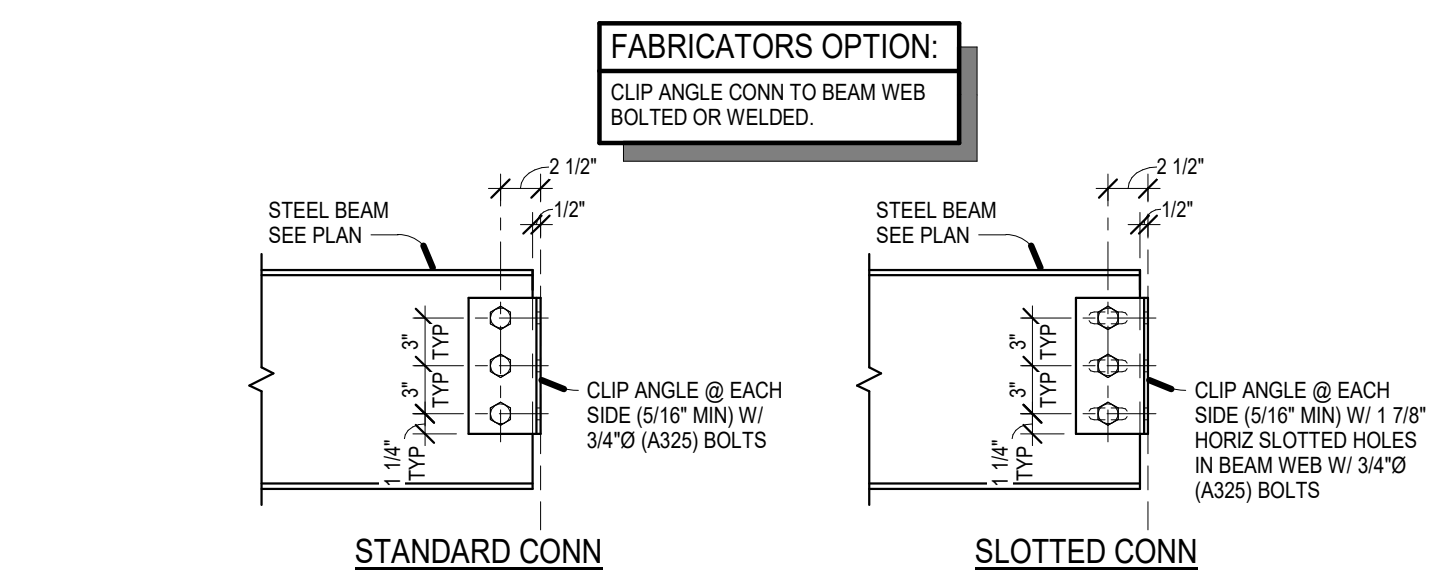

FABRICATORS OPTION:
CLIP ANGLE CONN TO BEAM WEB BOLTED OR WELDED.

STANDARD CONN
SLOTTED CONN




STEEL CONNECTION NOTES:

- NOTES ARE APPLICABLE FOR ALL STEEL BEAM CONNECTIONS INCLUDING BEAM-BEAM, BEAM-COLUMN AND BEAM-EMBED PLATE FOR ALL SHEAR AND MOMENT CONNECTIONS.
- USE NUMBER OF ROWS OF BOLTS REQUIRED BASED ON REACTIONS LISTED ON PLANS. USE MINIMUM ROWS AS LISTED.
- WHERE BEAMS FRAME IN FROM BOTH SIDES OF GIRDER, ADD OSHA ERECTION BOLT TO BOTTOM OF CONNECTION IN ADDITION TO MINIMUM ROWS OF BOLTS.
- SINGLE ANGLE CONNECTION W/ REQUIRED CAPACITY SHALL BE USED AT LOCATIONS OF LIMITED (2) SIDE ACCESS.
- SKWEVED BEAMS:
 - IF BEAM IS SKWEVED $\le 45^\circ$, USE BENT PLATES (3/8" MIN) INSTEAD OF ANGLES. BENT PLATES PERPENDICULAR TO GRAIN.
 - IF BEAM IS SKWEVED >math>45^\circ</math>, USE SHEAR PLATES (3/8" MIN) INSTEAD OF ANGLES.

BEAM SIZE	MINIMUM ROWS OF BOLTS
W8, 10	2
W12, 14	3
W16, 18	4
W21	5
W24	6
W27	7
W30	8

2 S501 Beam Connection @ Column


1" = 1'-0"

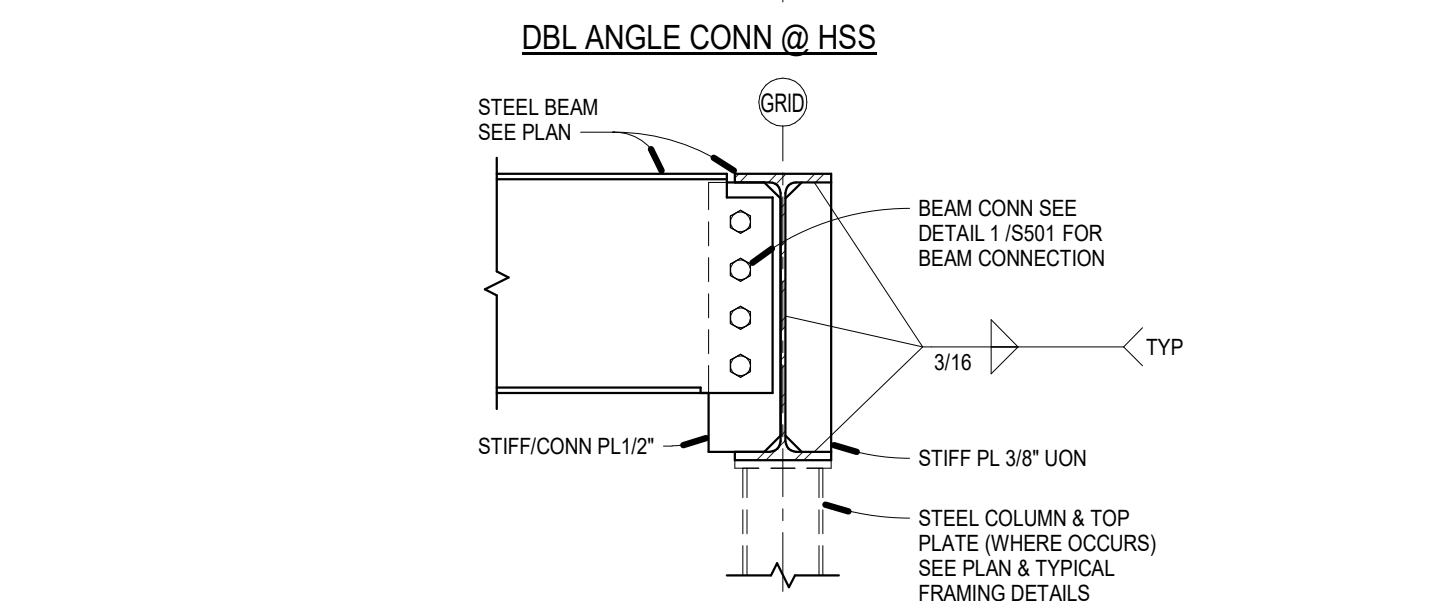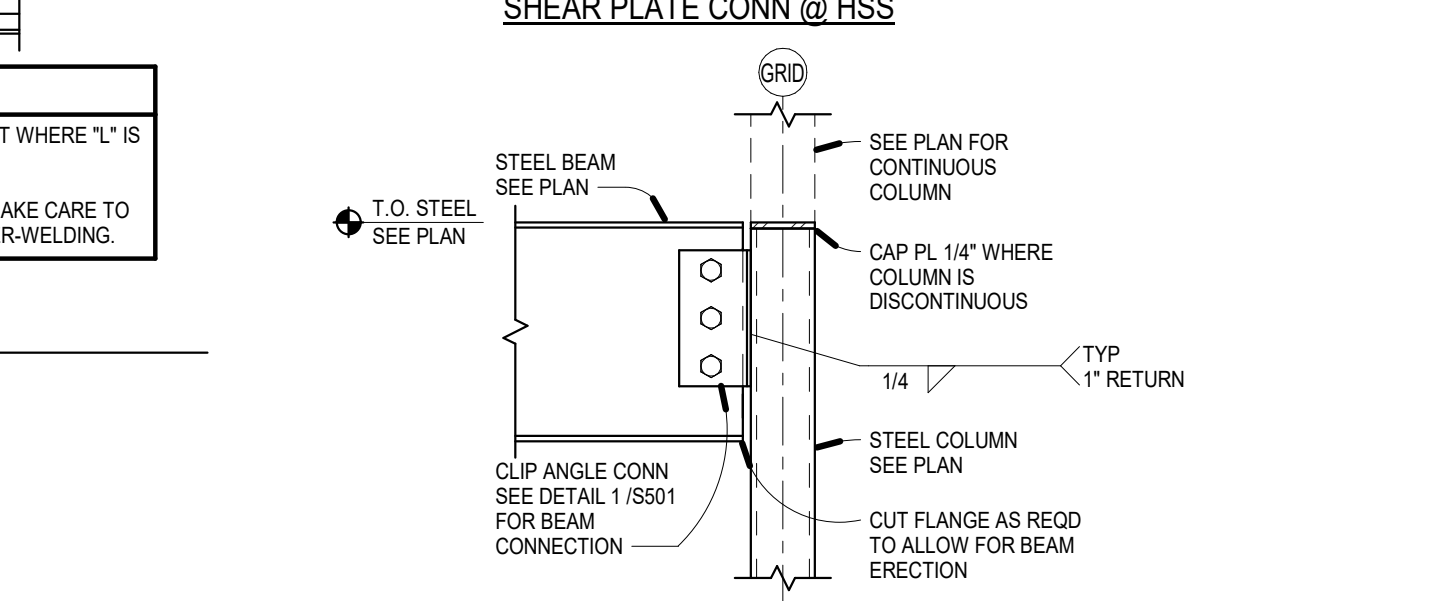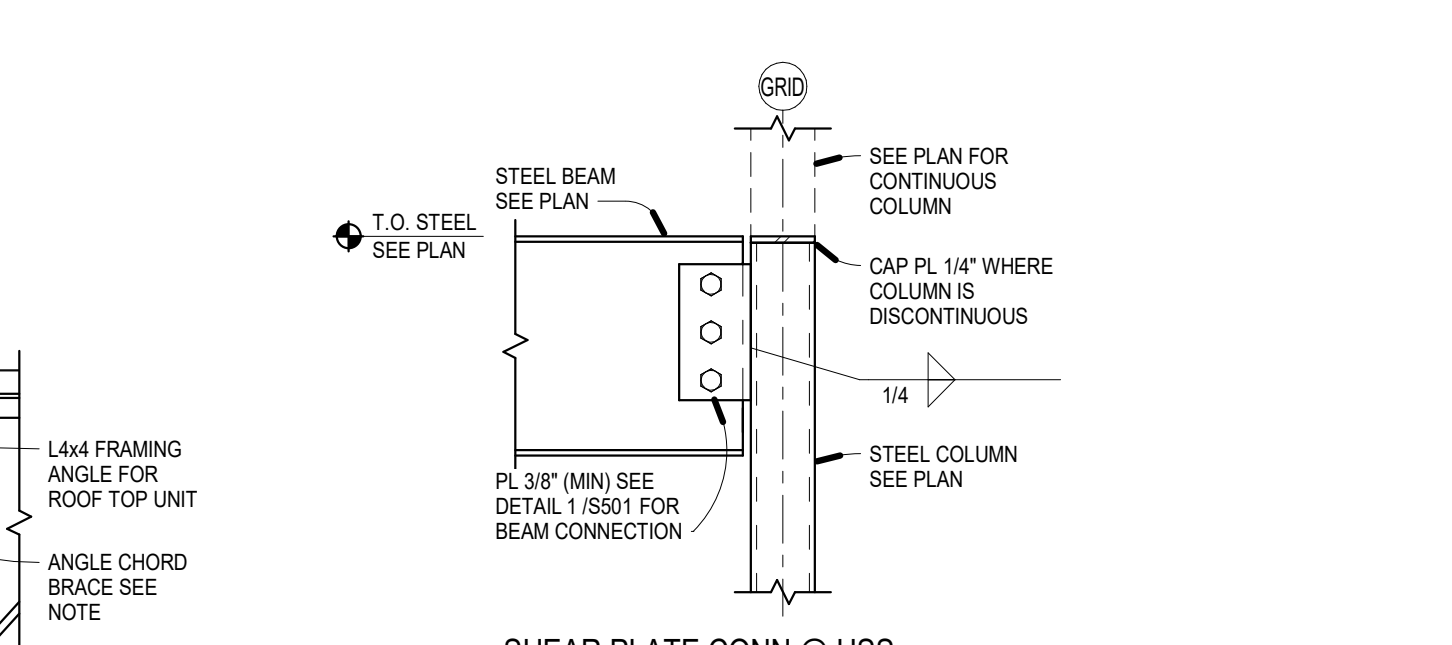

NOTE:
EXTEND STIFF/CONN PLATE PAST EXTENT OF BEAM FLANGE AS REQUIRED TO MEET BOLT EDGE DISTANCE REQUIREMENTS.

2 S501 Beam Connection @ Column

1" = 1'-0"

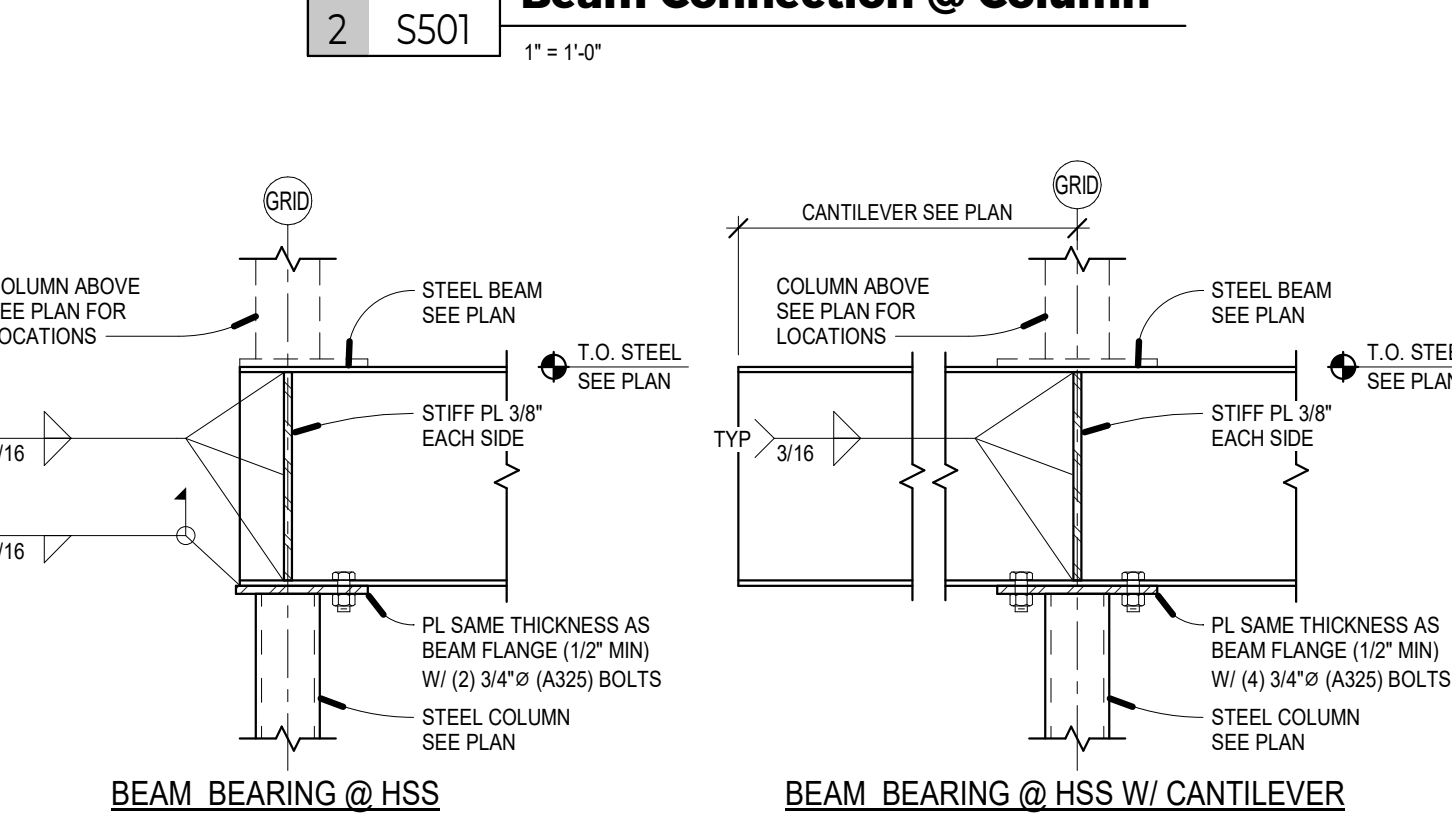

3 S501 Beam End Bearing @ Column

1" = 1'-0"



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Framing Details

SHEET S501



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1	CONSTRUCTION DOCUMENTS	01/15/2025


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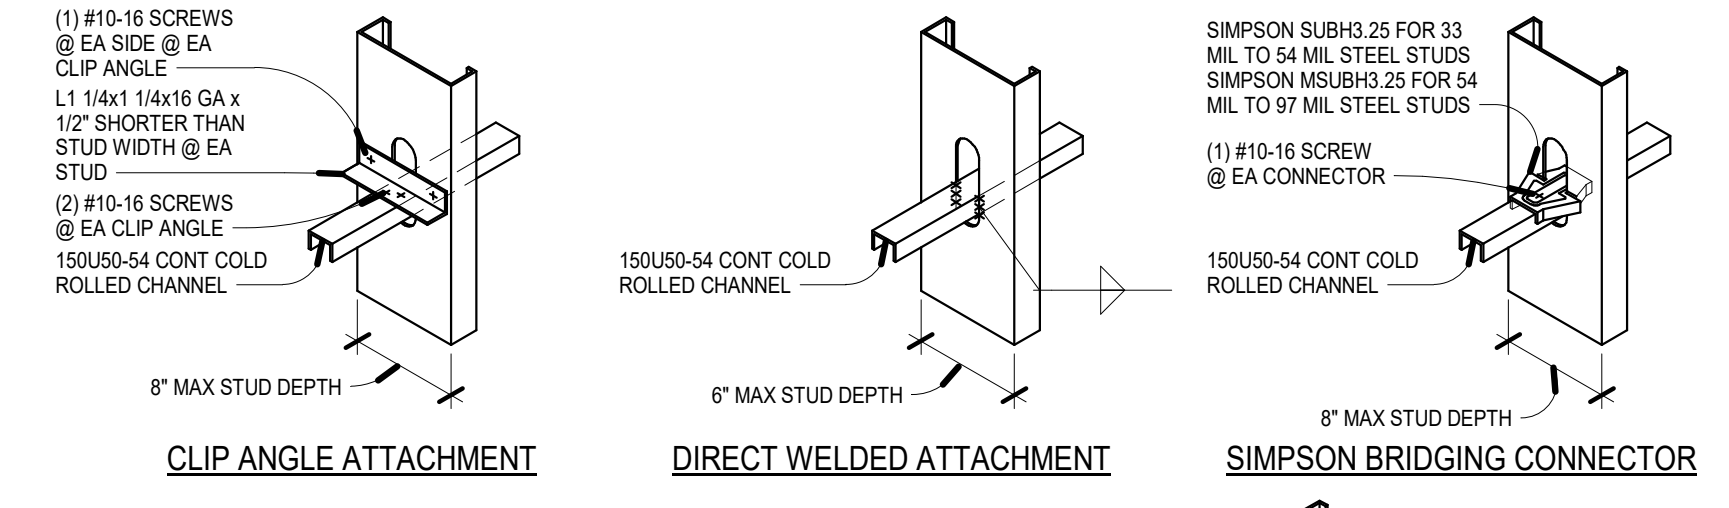
Framing Details

SHEET


S502




9 S502 Multi-Ply Fastening Detail
NO SCALE

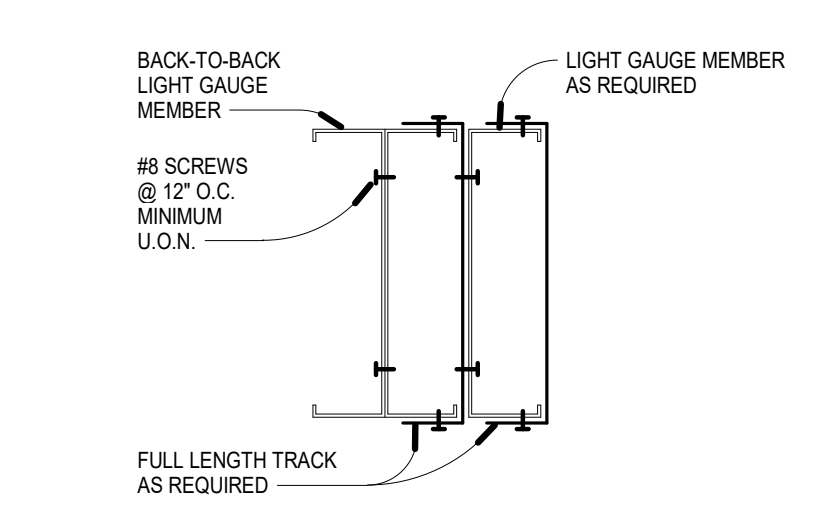


5 S502 Cold Formed Stud Bridging
NO SCALE

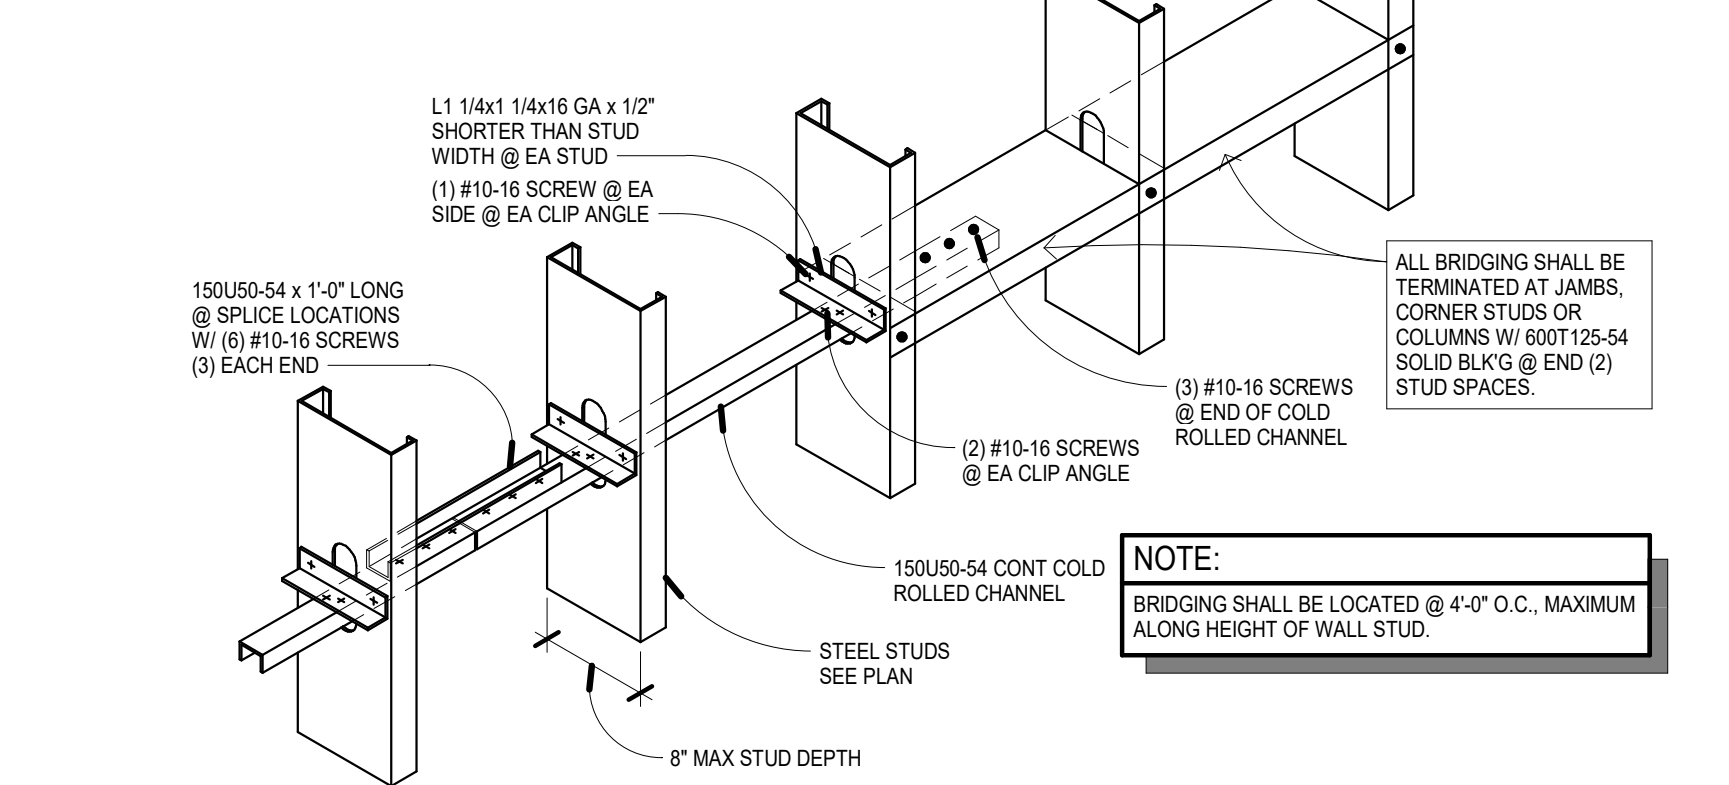


5 S502 Cold Formed Stud Bridging
NO SCALE

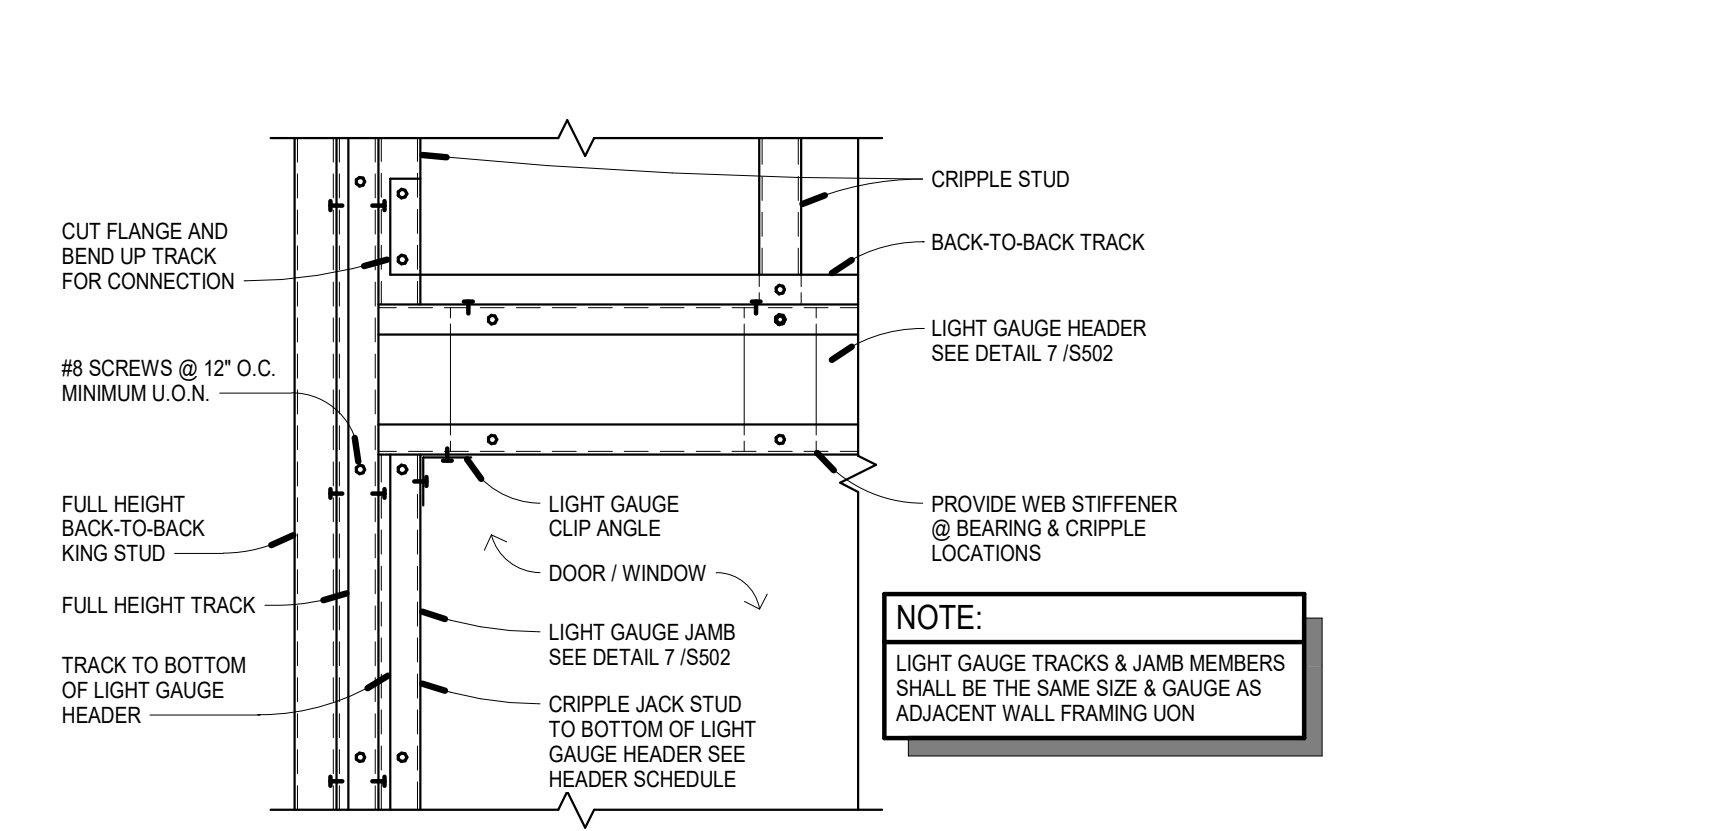


6 S502 Light Gauge Header Detail
NO SCALE

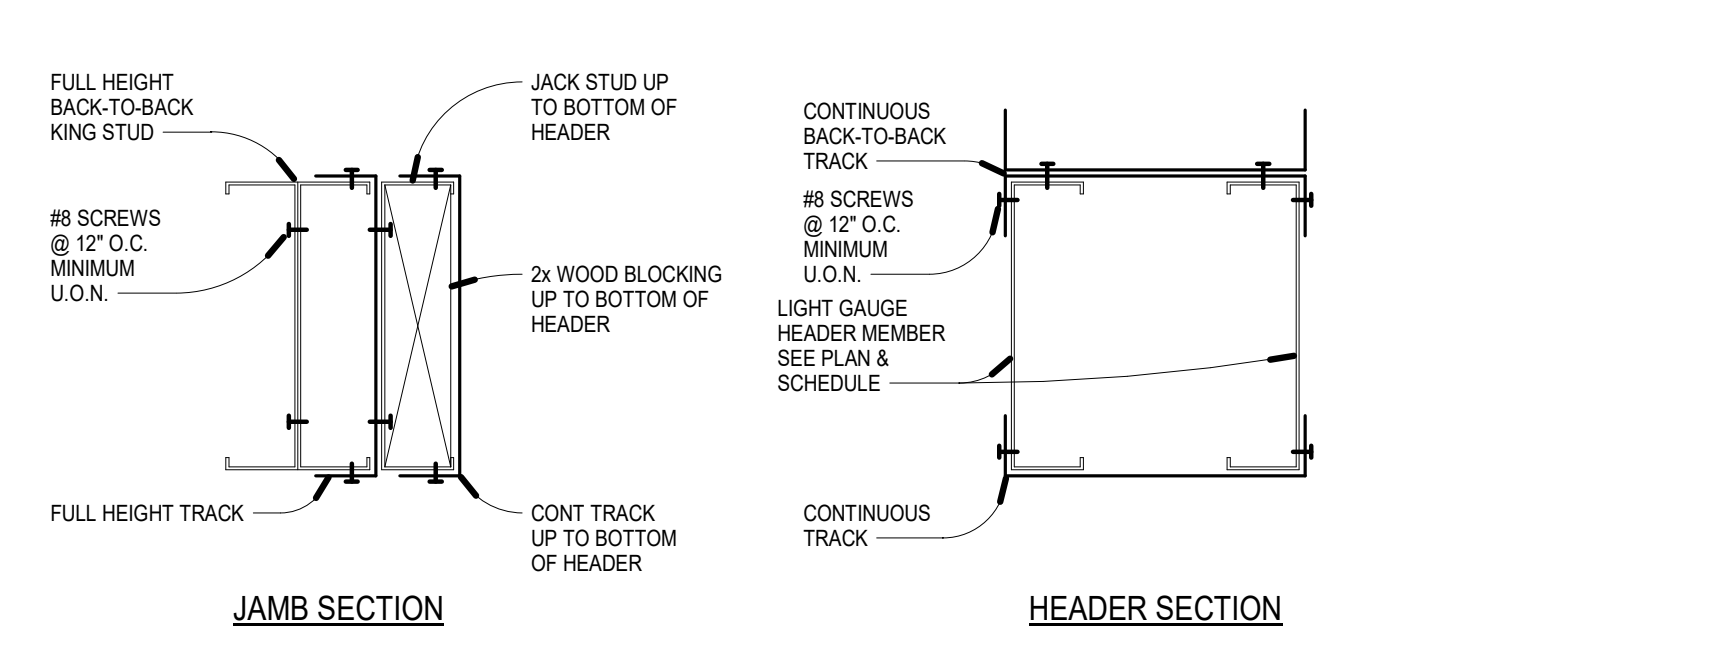


7 S502 Header / Jamb Assembly Detail
NO SCALE

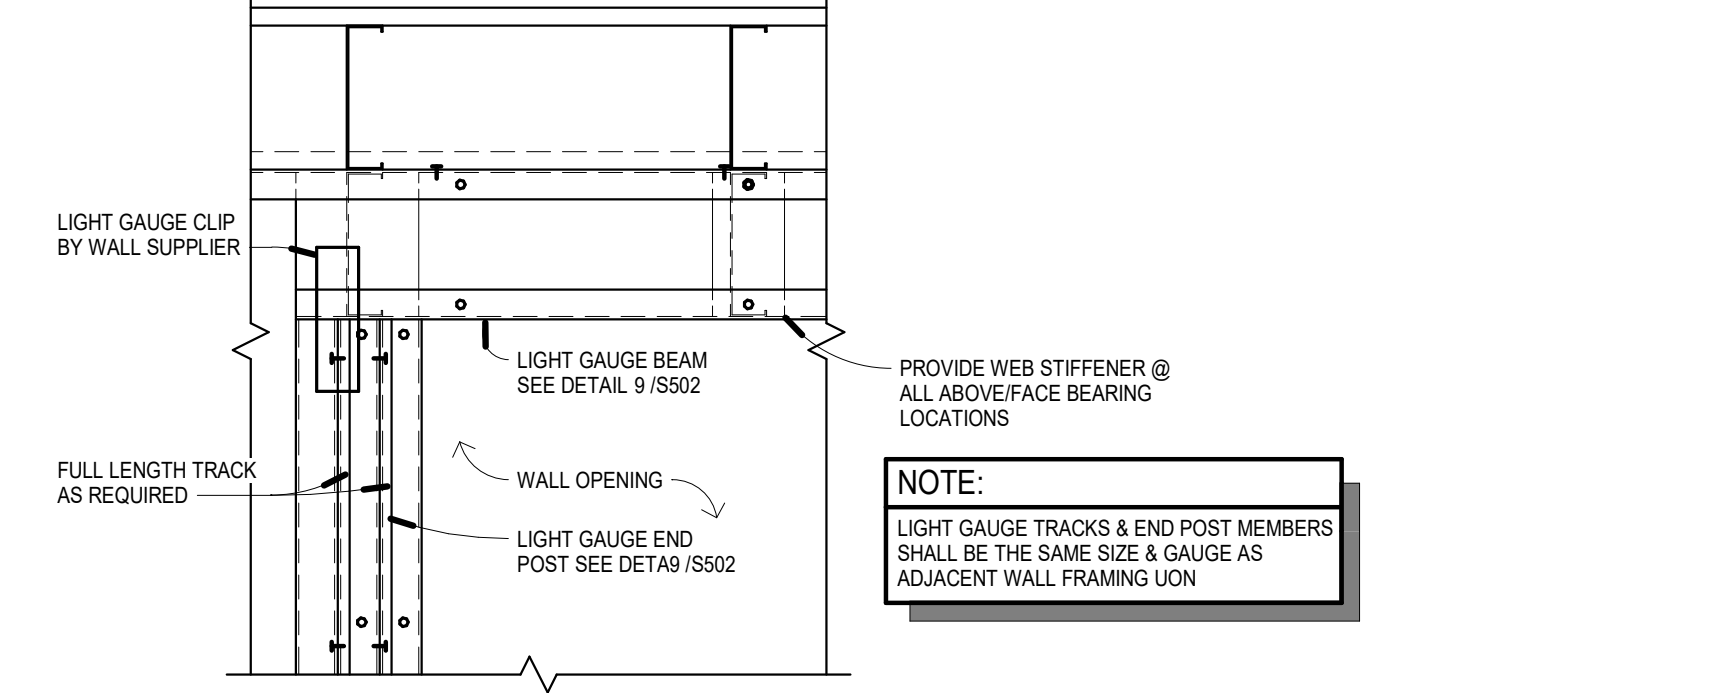


8 S502 Light Gauge Beam Detail
NO SCALE

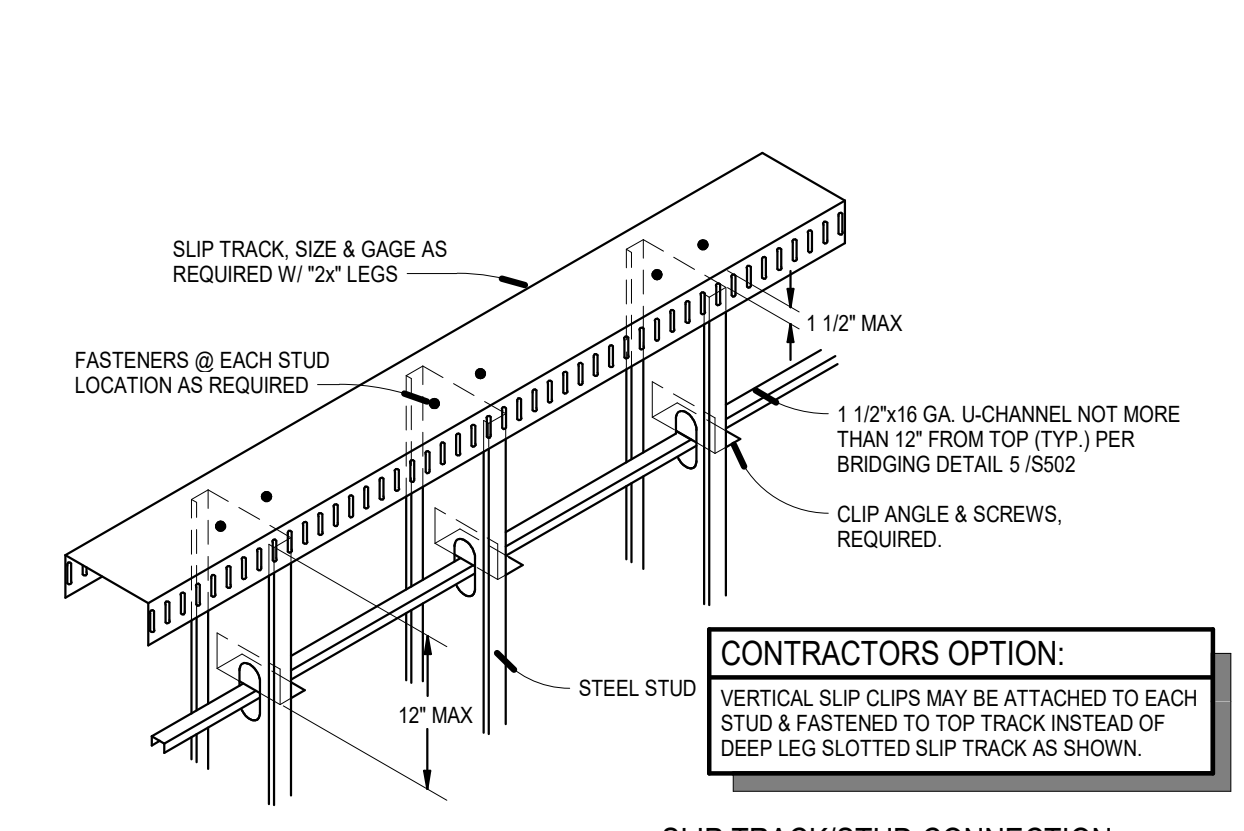


1 S502 Stud/Track Connection
NO SCALE

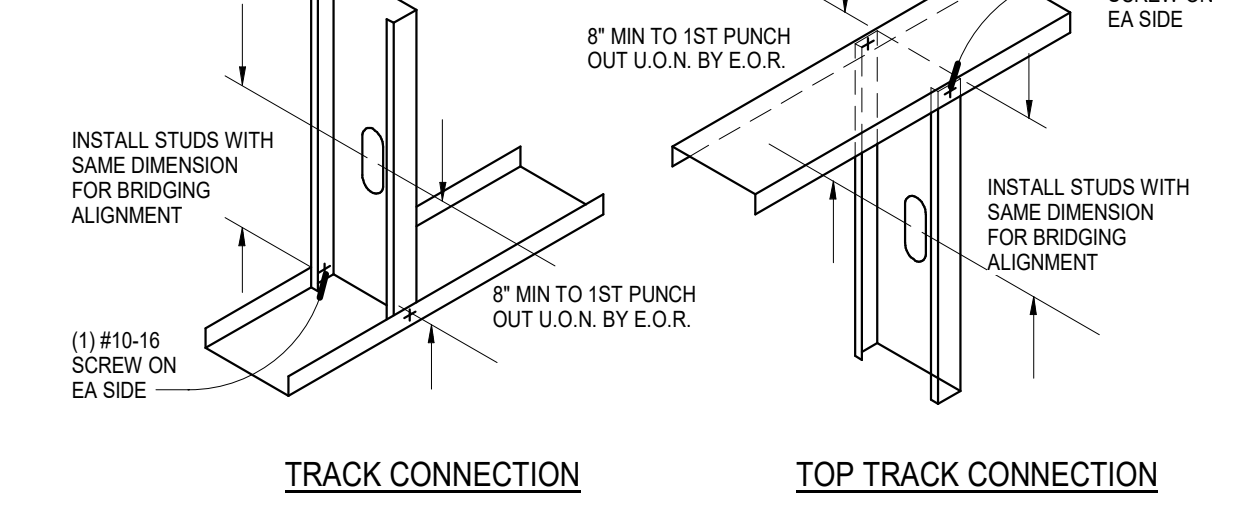


1 S502 Stud/Track Connection
NO SCALE

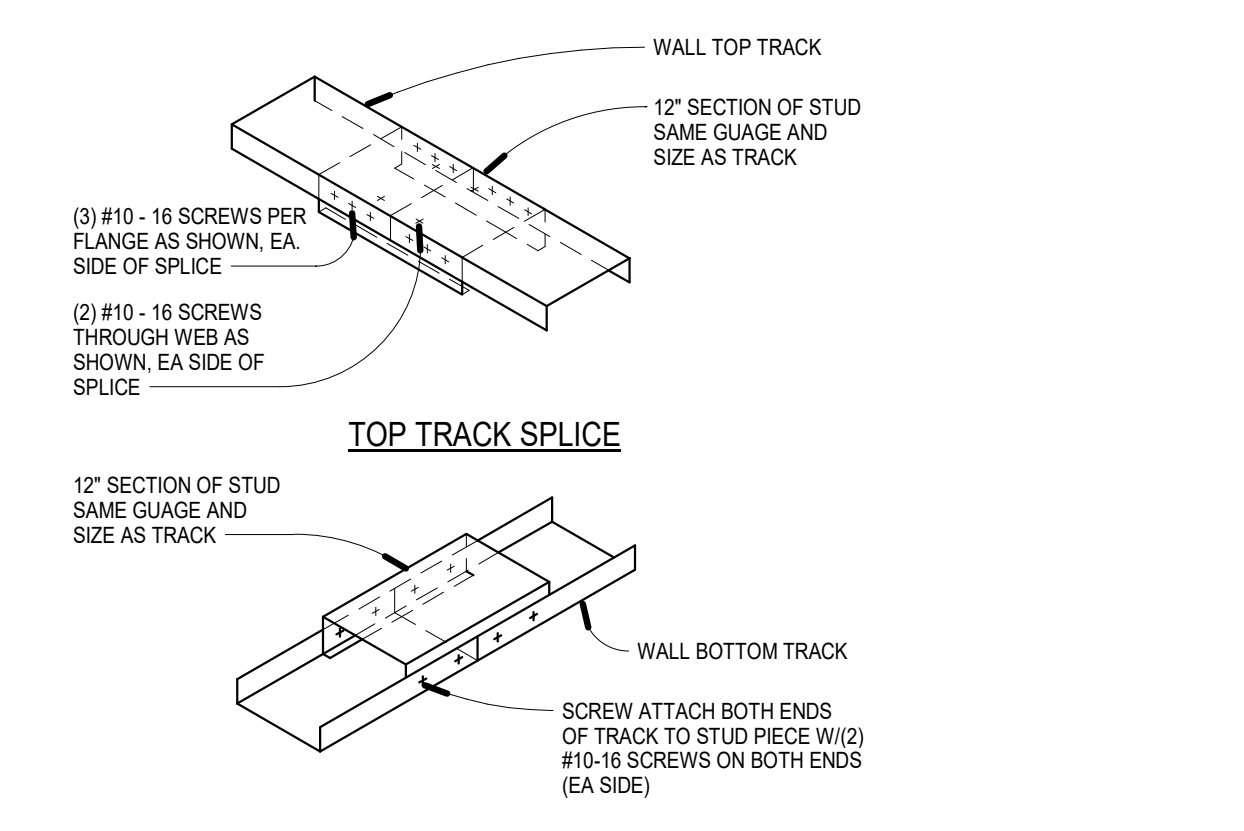

2 S502 Track Splice
3/4" = 1'-0"

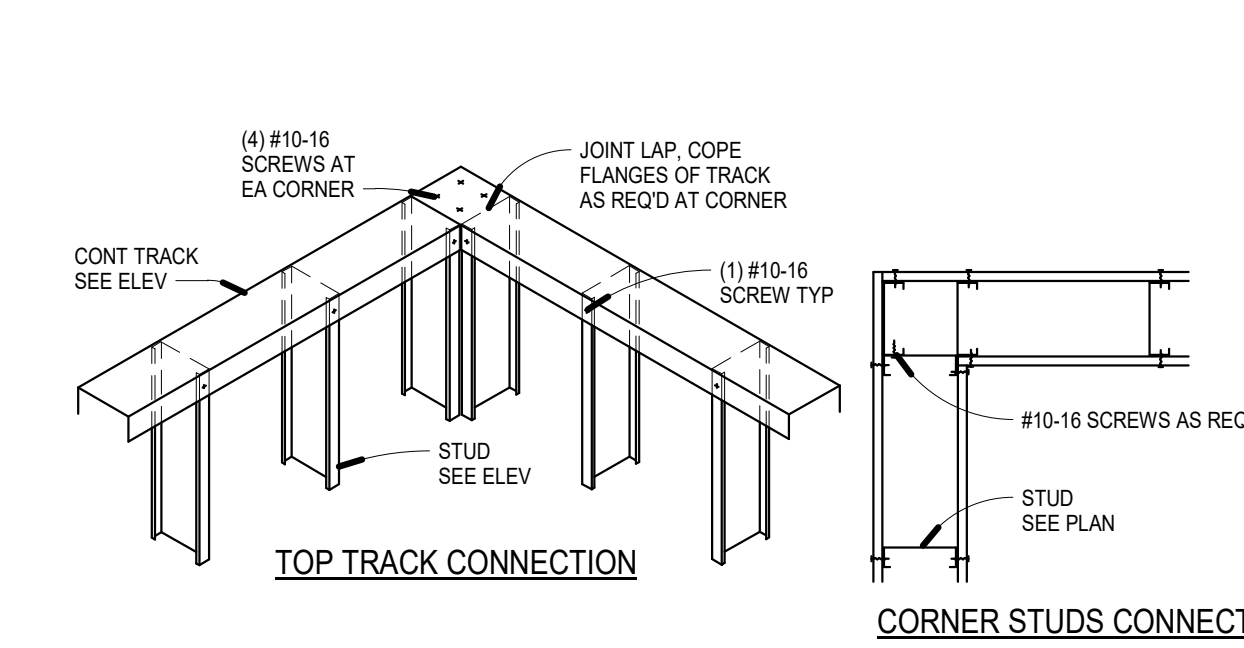

3 S502 Wall Corner
NO SCALE

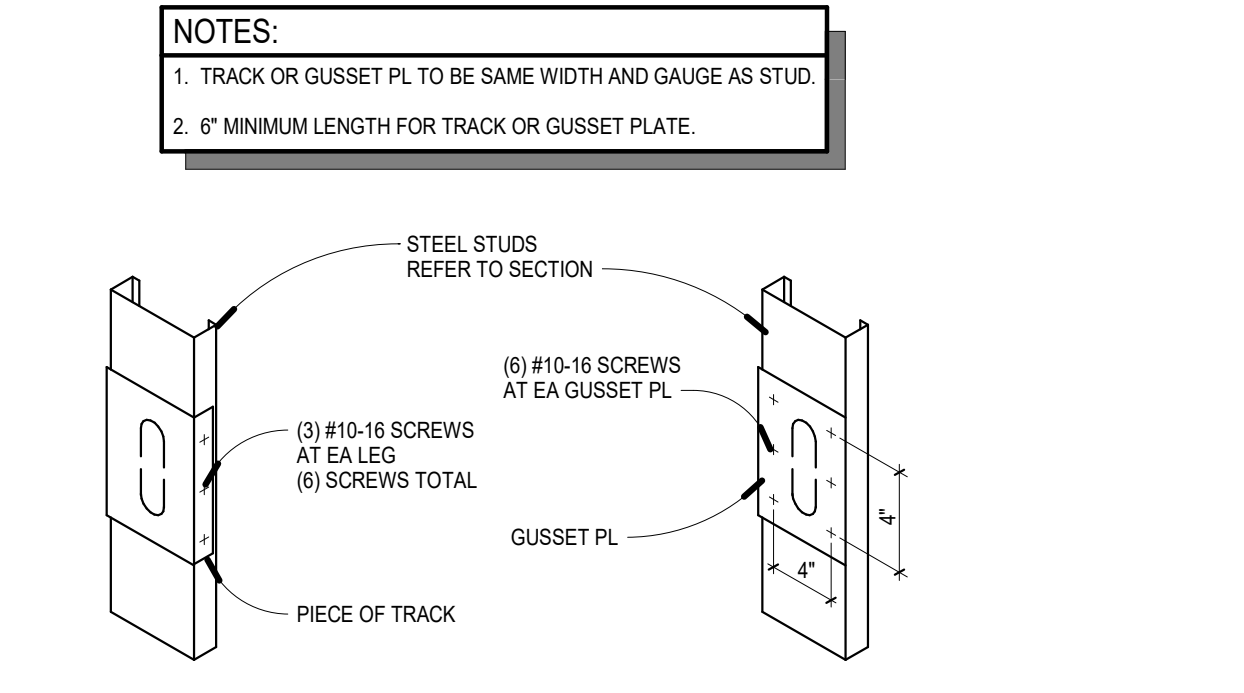

4 S502 Punchout Reinforcing Detail
NO SCALE



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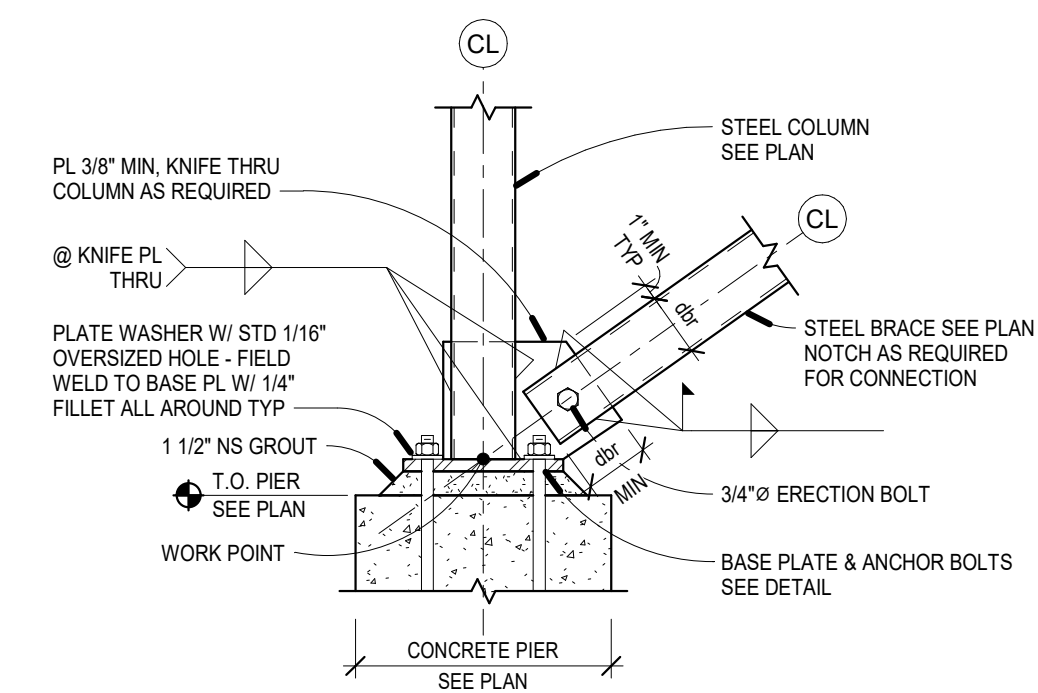
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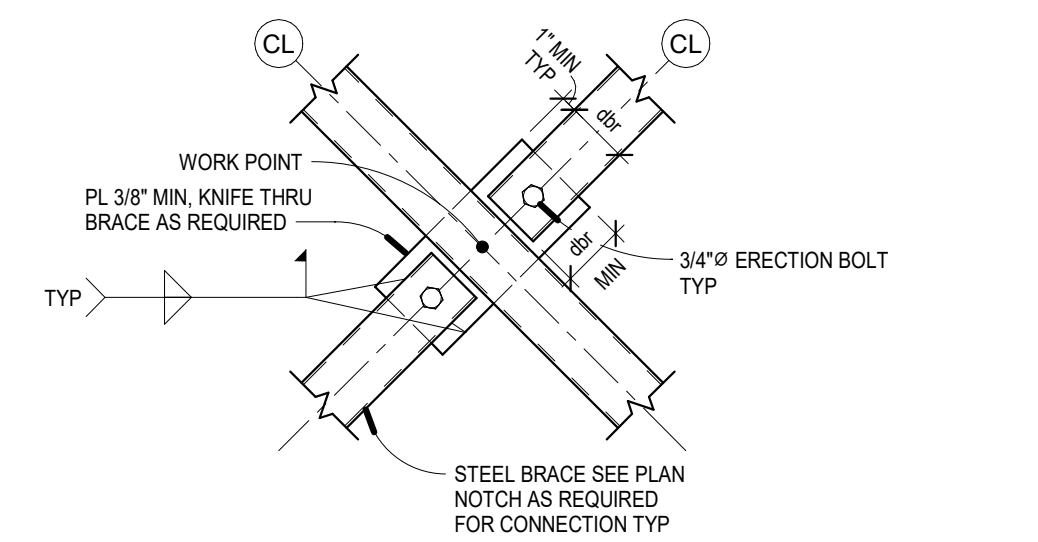
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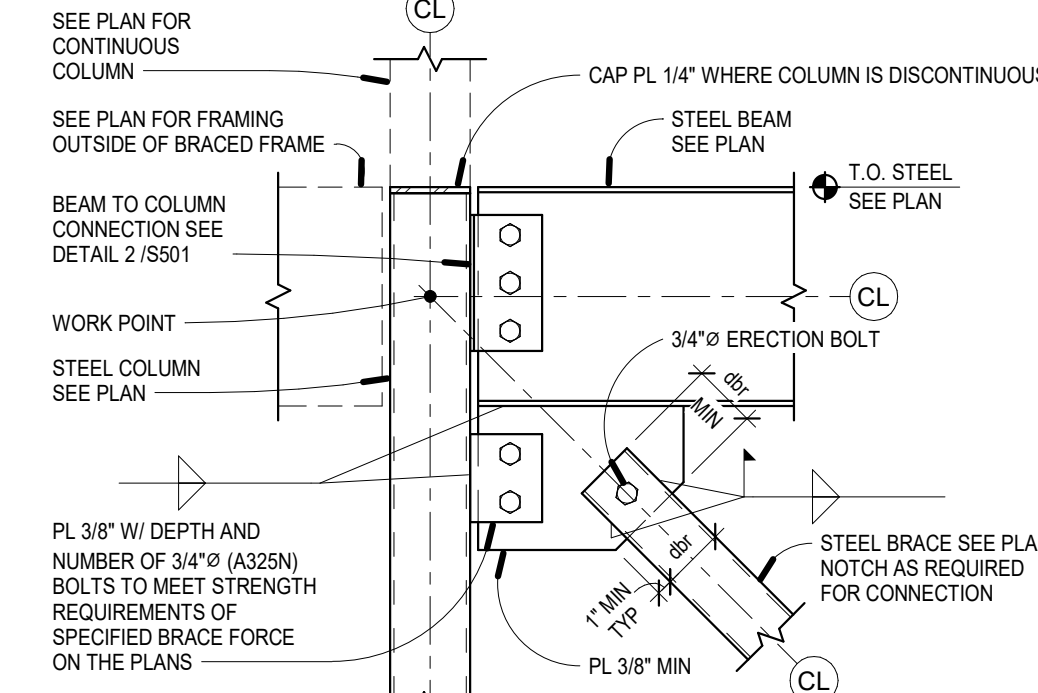
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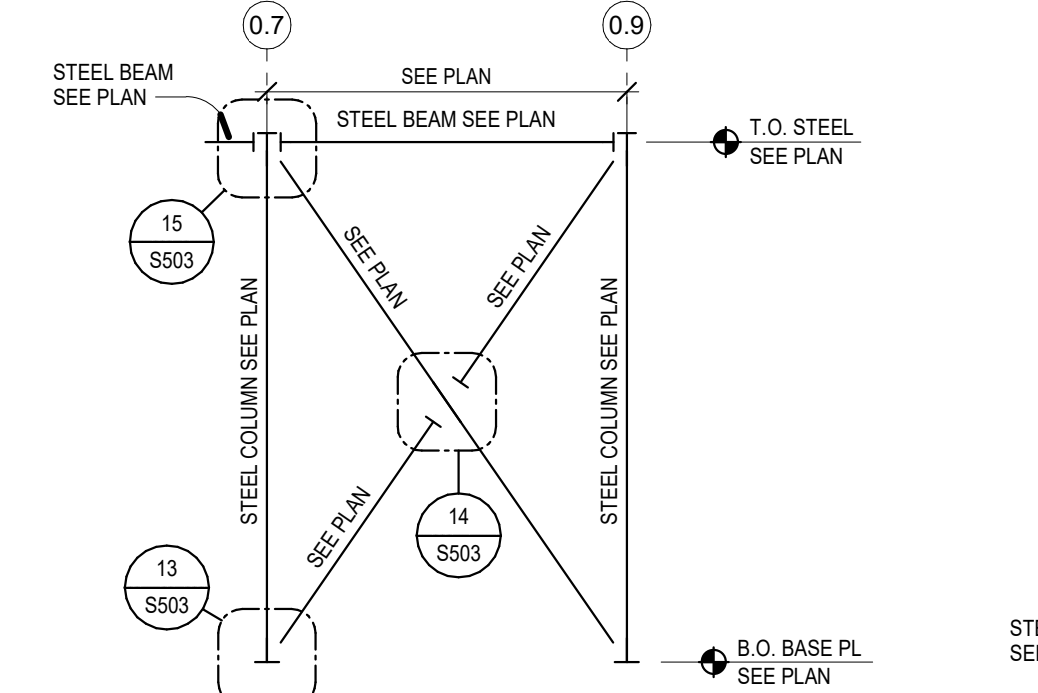
13 S503
Brace Connection
1" = 1'-0"




14 S503
Brace Connection
1" = 1'-0"




15 S503
Brace Connection
1" = 1'-0"




9 S503
Brace Elevation
NO SCALE

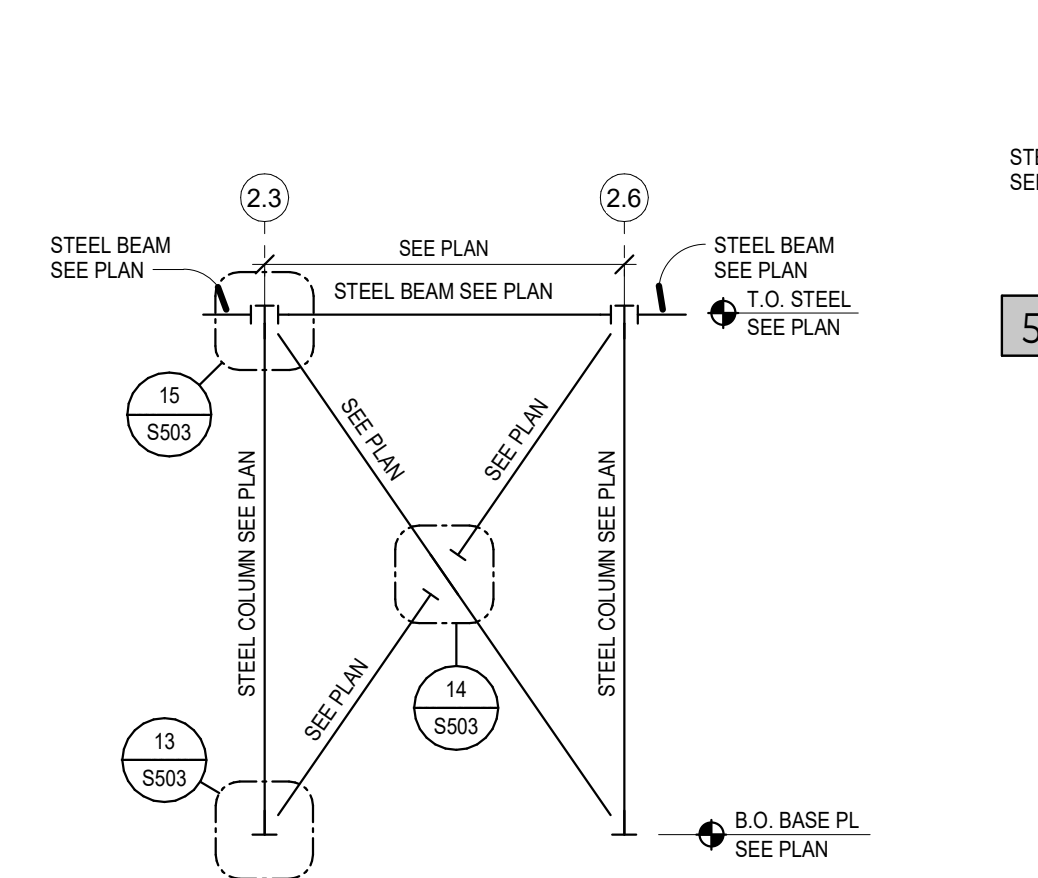


10 S503
Brace Elevation
NO SCALE

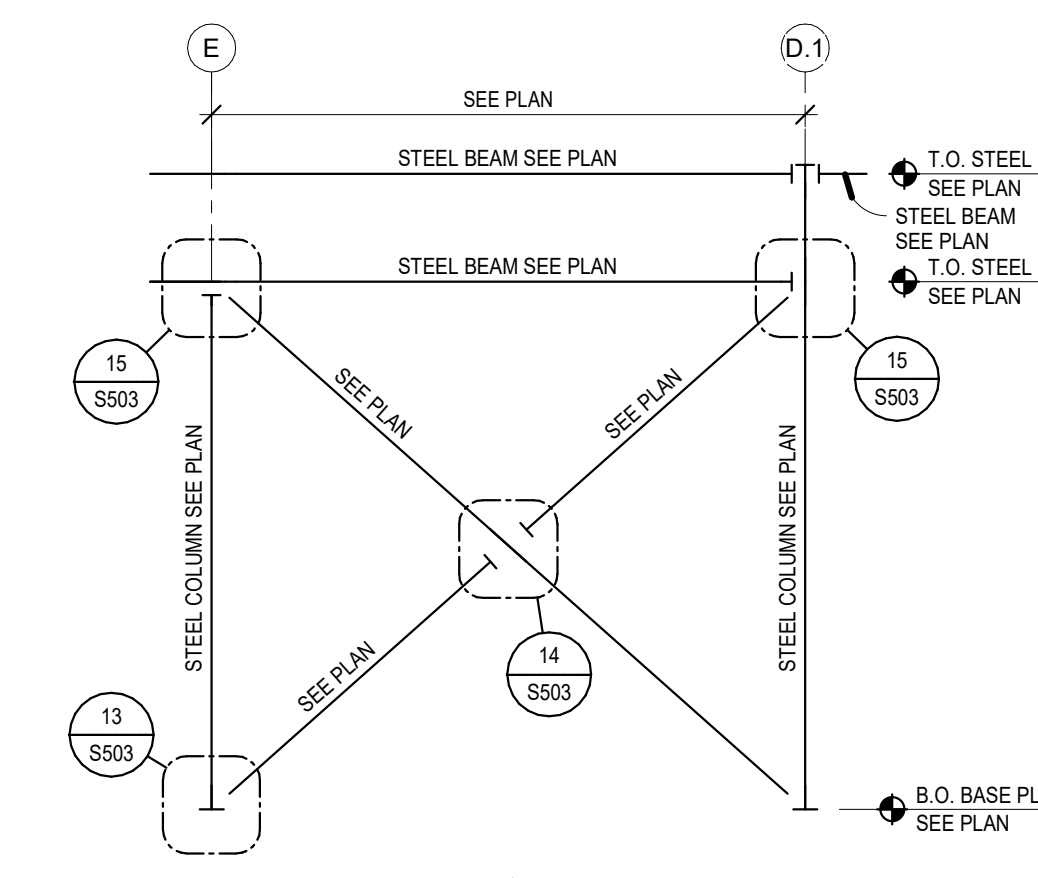


11 S503
Brace Elevation
3/16" = 1'-0"

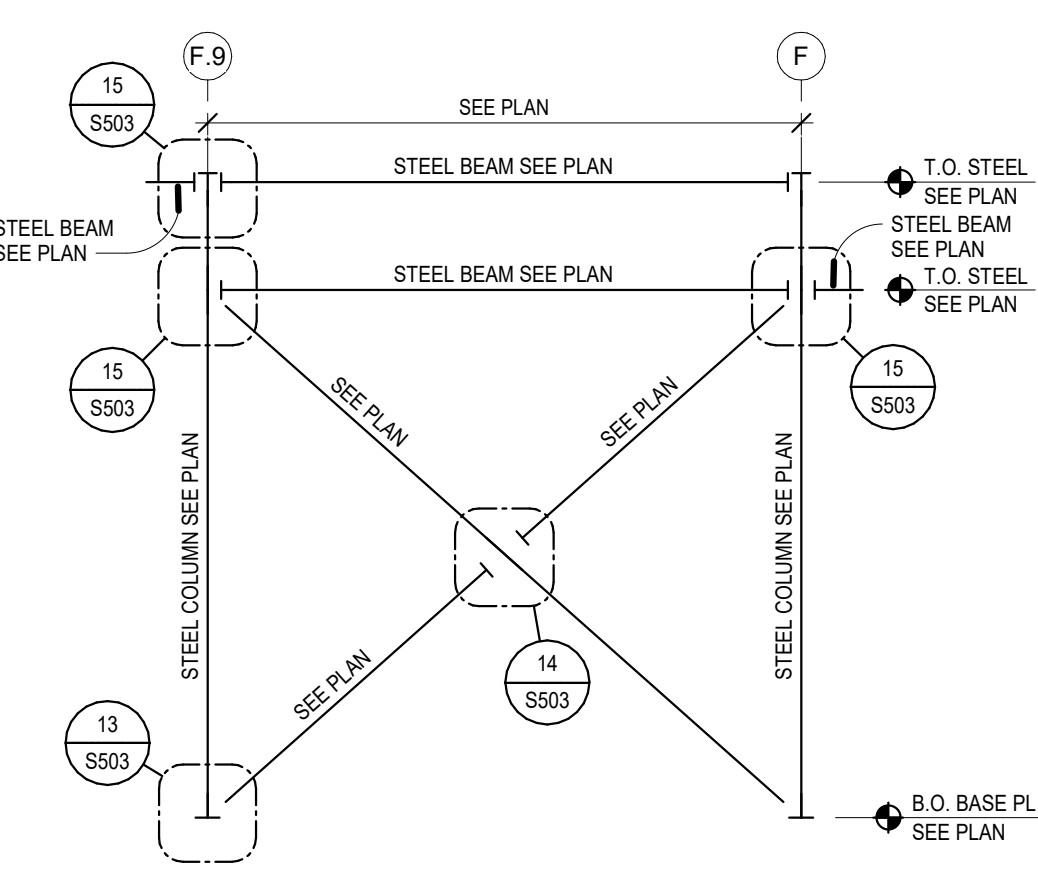


12 S503
Brace Elevation
NO SCALE

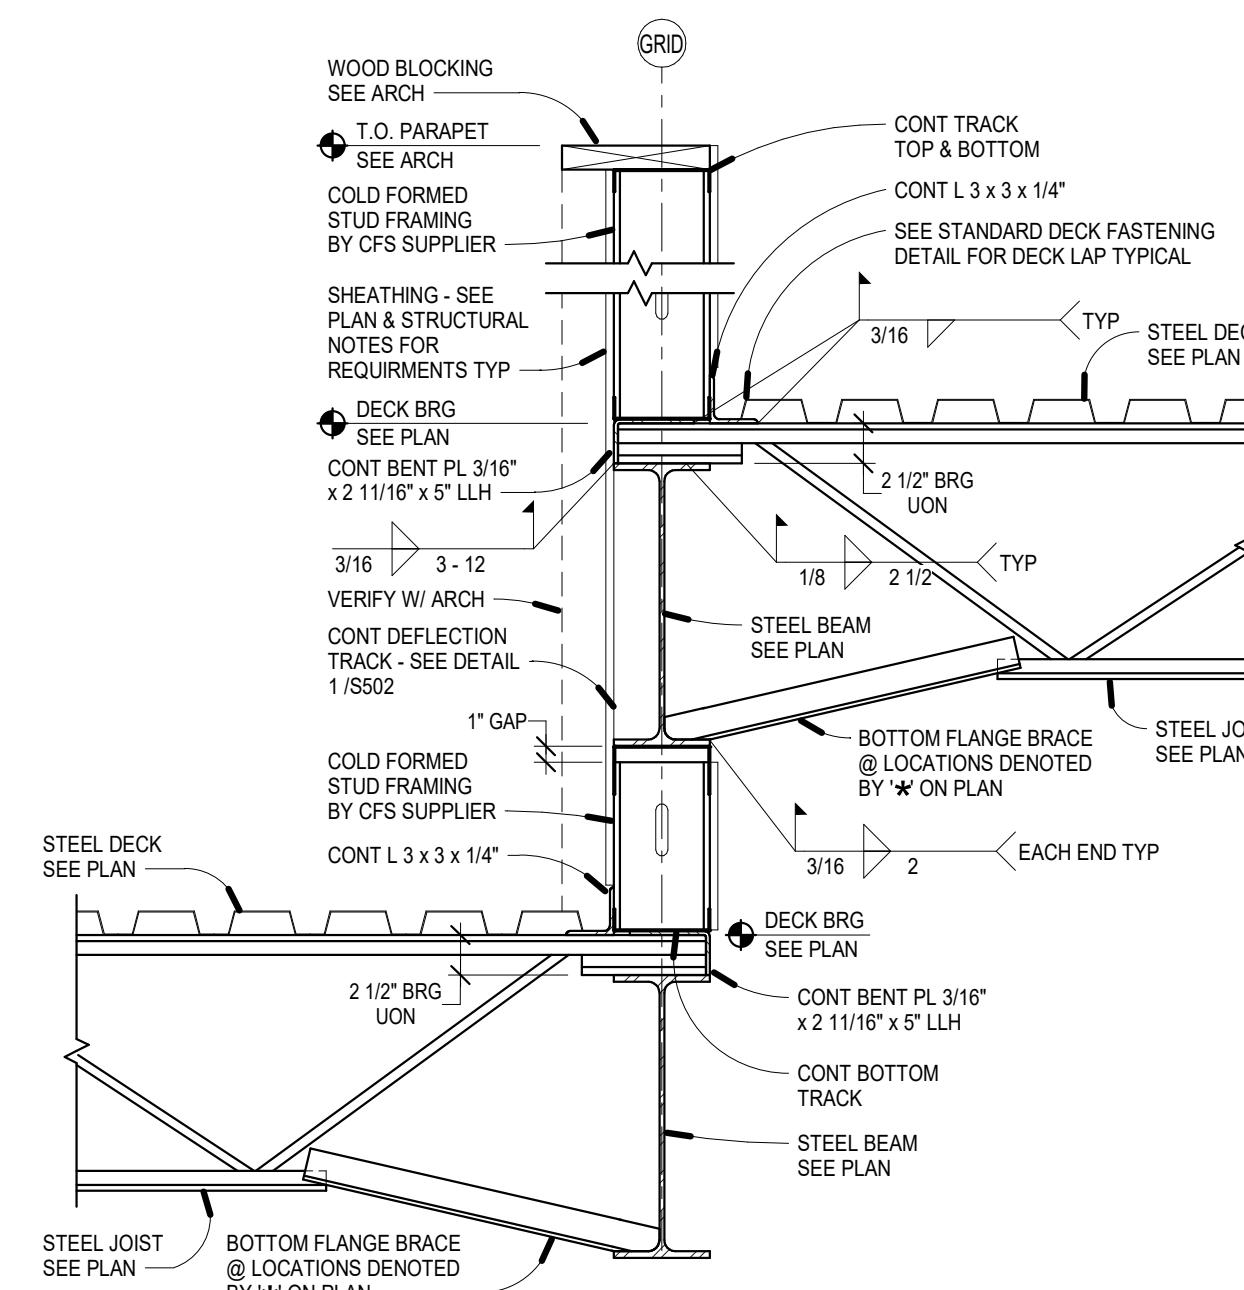


5 S503
Deck Bearing
1" = 1'-0"

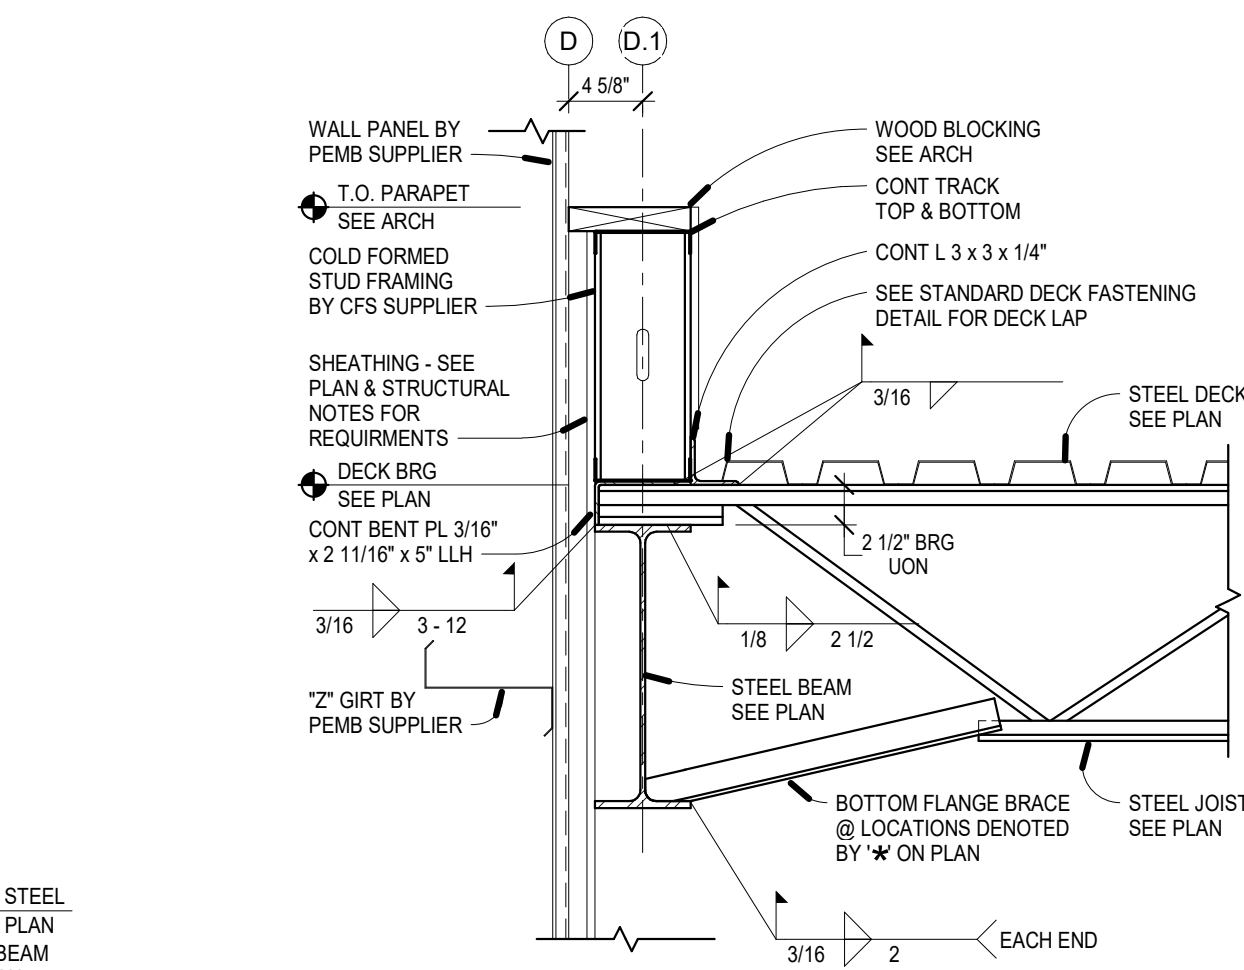


6 S503
Joist Bearing
1" = 1'-0"

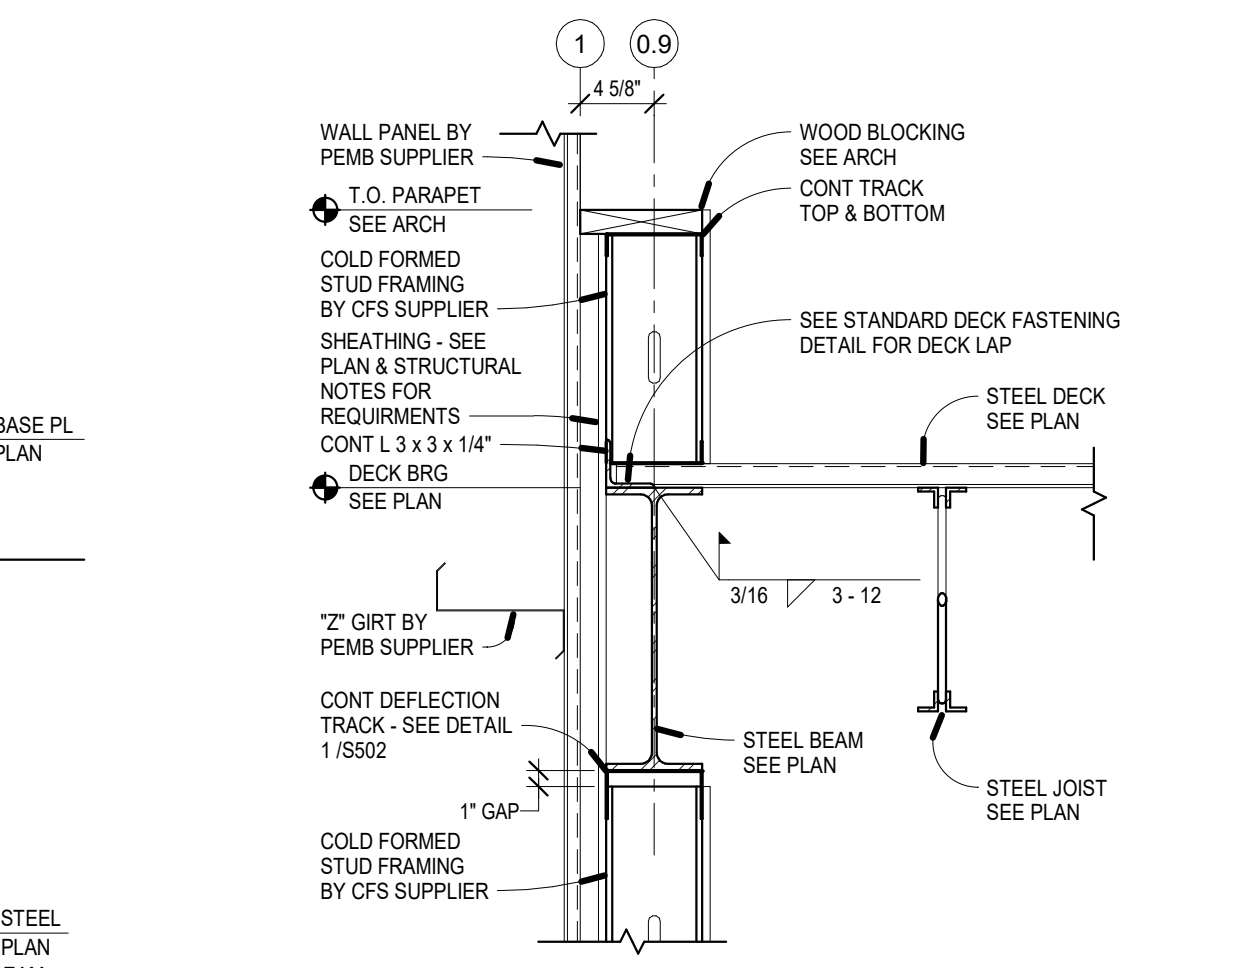


7 S503
Deck Bearing
1" = 1'-0"

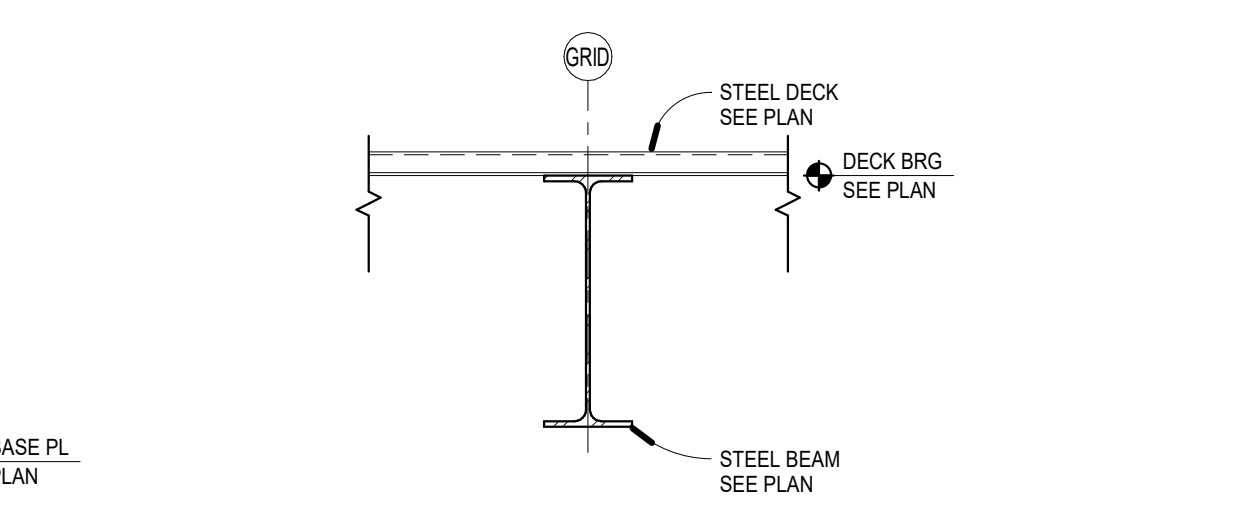


8 S503
Deck Bearing
1" = 1'-0"

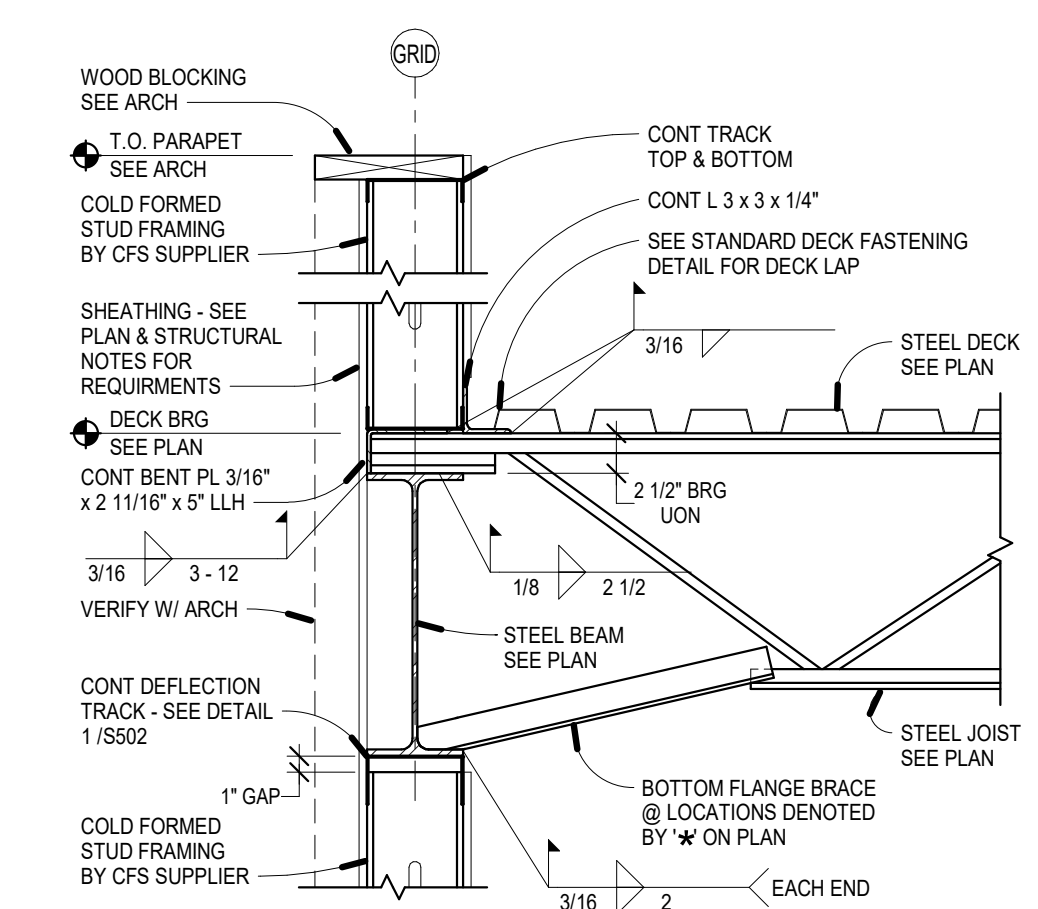


1 S503
Joist Bearing
1" = 1'-0"

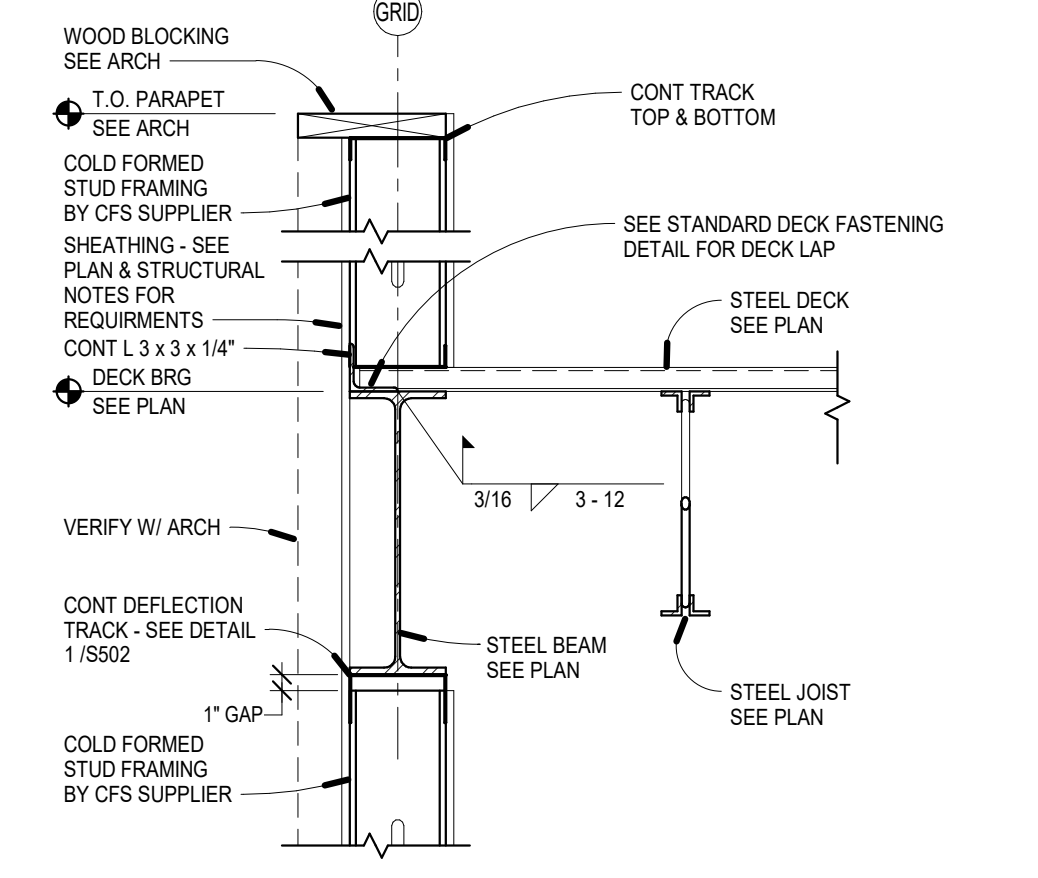


2 S503
Deck Bearing
1" = 1'-0"

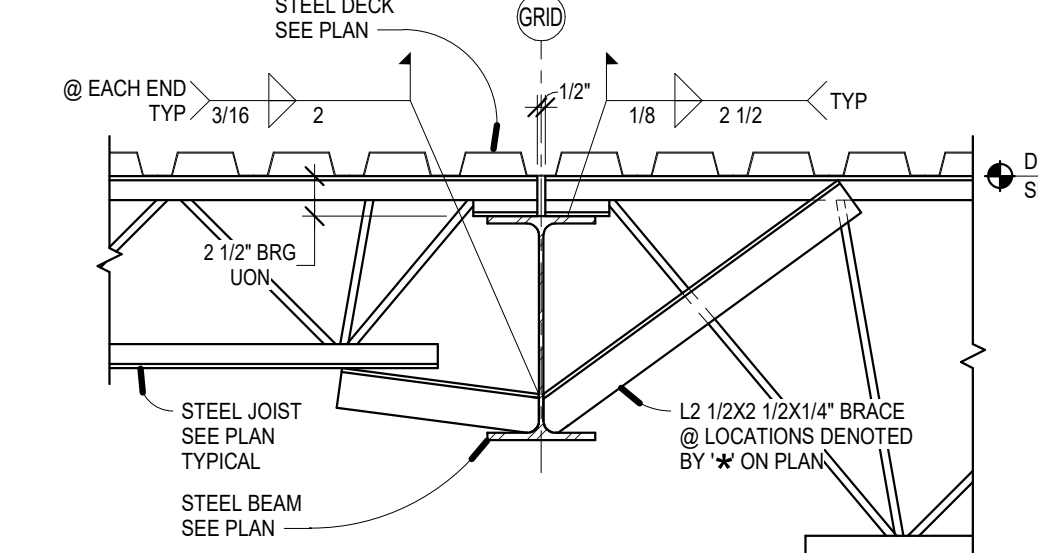

3 S503
Joist Bearing
1" = 1'-0"

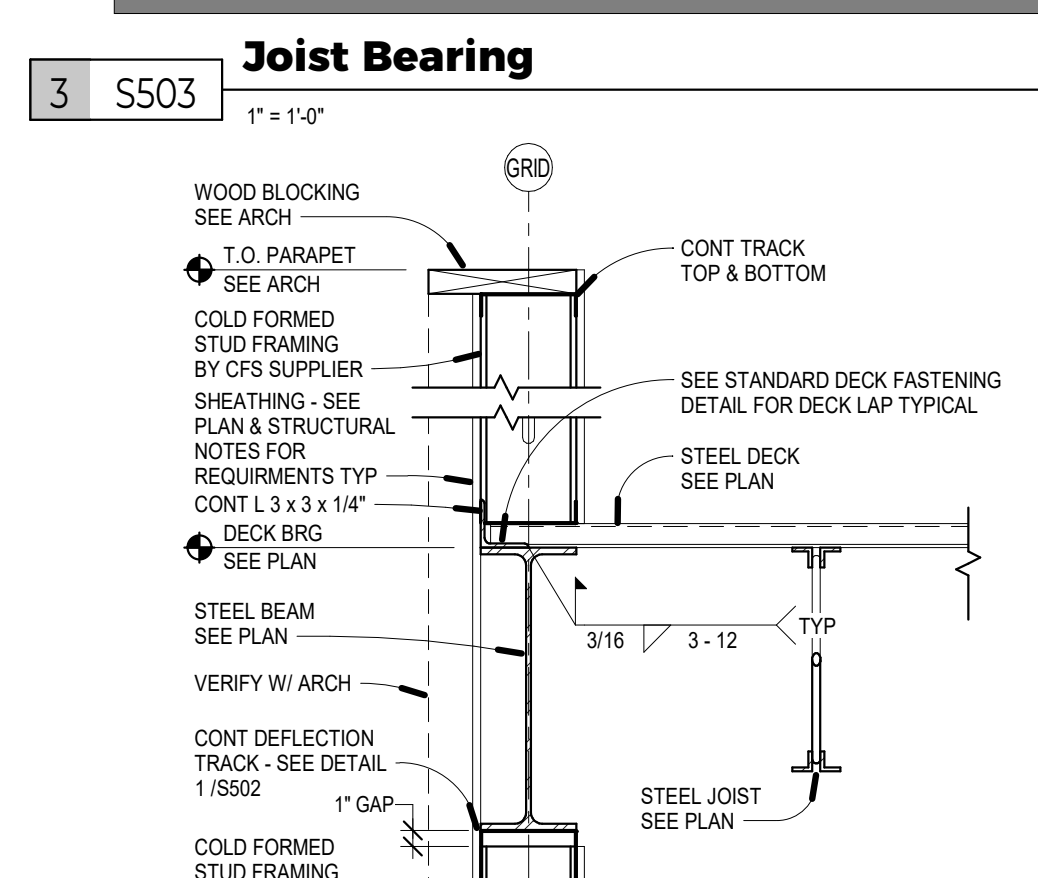

4 S503
Deck Bearing
1" = 1'-0"

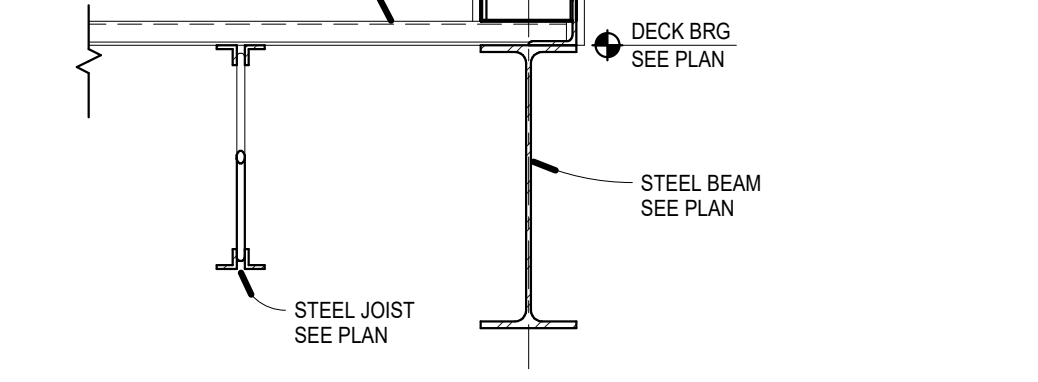

4 S503
Deck Bearing
1" = 1'-0"

NOTE:
• ANGLE BRACE ONLY REQUIRED ON ONE SIDE OF BEAM @ INDICATED LOCATIONS
• WHERE BEAM DEPTH IS GREATER THAN JOIST DEPTH BRACE TO JOIST BOTTOM CHORD PANEL POINT
• WHERE JOIST DEPTH IS GREATER THAN BEAM DEPTH BRACE TO JOIST TOP CHORD PANEL POINT



DRAWING HISTORY

NO.	DESCRIPTION	DATE
	CONSTRUCTION DOCUMENTS	01/15/2025

DRAWN BY: TO/AF JN: 24-054

Framing Details

SHEET
S503



**TURTLE MOUNTAIN COMMUNICATIONS
NEW BUILDING**
BOTTINEAU, NORTH DAKOTA

STRUCTURAL

ICON ARCHITECTURAL GROUP
222 EAST MAIN STREET, SUITE B
MANDAN, ND 58554
(701) 751.0430 OFFICE

MECHANICAL

MBN ENGINEERING, INC.
503 7TH STREET NORTH, SUITE 200
FARGO, ND 58102
(701) 478.6336 OFFICE

ELECTRICAL

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CIVIL

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SITE PLAN NOTES

1. ALL WORK PERFORMED WITHIN THE PUBLIC RIGHT-OF-WAY SHALL BE DONE IN ACCORDANCE WITH THE CITY OF BOTTINEAU, ND STANDARD CONSTRUCTION SPECIFICATIONS. PRIOR TO DOING AS WORK IN THE CITY RIGHT-OF-WAY THE CONTRACTOR SHALL CALL THE ENGINEERING DEPARTMENT AT (701) 228-3232.
2. ALL SIGNS TO BE APPROVED BY THE BOTTINEAU, ND INSPECTIONS DEPARTMENT (CONVENTIONAL ZONING) OR PLANNING DEPARTMENT (PLANNED UNIT DEVELOPMENT).

PROPERTY INFORMATION

UTMA OFFICE AND SHOP BUILDING
BOTTINEAU, ND
PARCEL A OF LOT 1 OF BLOCK 1 OF COBBLESTONE ADDITION
TO THE CITY OF BOTTINEAU
B-2 (CENTRAL BUSINESS)
UNITED AND TURTLE MOUNTAIN COMMUNICATIONS

PARKING REQUIREMENTS

PER BOTTINEAU CITY CODE, SECTION 6.0409
TOTAL REQUIRED = 21 SPOTS
TOTAL PARKING PROVIDED = 21 SPOTS

PARKING REQUIREMENTS



21 SPACES PROVIDED IN LOT
12 SPACES PROVIDED IN GARAGE
1 ACCESSIBLE SPACE PROVIDED IN LOT

PARKING REQUIREMENTS

B-2 (CENTRAL BUSINESS) SECTION 6, 6.0409.1
USES PERMITTED - OFFICE BUILDINGS SECTION 6, 6.0409.4
SETBACKS - NONE SECTION 6, 6.0409.4

KEYNOTES - SITE PLAN

- ① FENCE AROUND PERIMETER OF GRAVEL AREA - SEE CIVIL
- ② PROPANE TANK LOCATION (BY OWNER)
- ③ CONCRETE APRON - SEE CIVIL
- ④ BOLLARD LOCATION - SEE 2/A001
- ⑤ FENCE AROUND PERIMETER OF GRAVEL AREA - SEE CIVIL
- ⑥ ALTERNATE - GENERATOR PAD - (16'x7') - SEE CIVIL
- ⑦ DUMPSTER ENCLOSURE (BY OWNER)
- ⑧ GRAVEL COVERED LOT - SEE CIVIL
- ⑨ NEW VALLEY GUTTER - SEE CIVIL
- ⑩ DROP CURB SECTION - SEE CIVIL
- ⑪ ACCESSIBLE PARKING STALL - SEE CIVIL
- ⑫ NEW RIP RAP WALL - SEE CIVIL
- ⑬ NEW SEEDING - SEE CIVIL
- ⑭ ROLLER GATE
- ⑮ KNOX BOX LOCATION
- ⑯ PAYMENT AND EQUIPMENT DROP BOX
- ⑰ MAIL BOX LOCATION

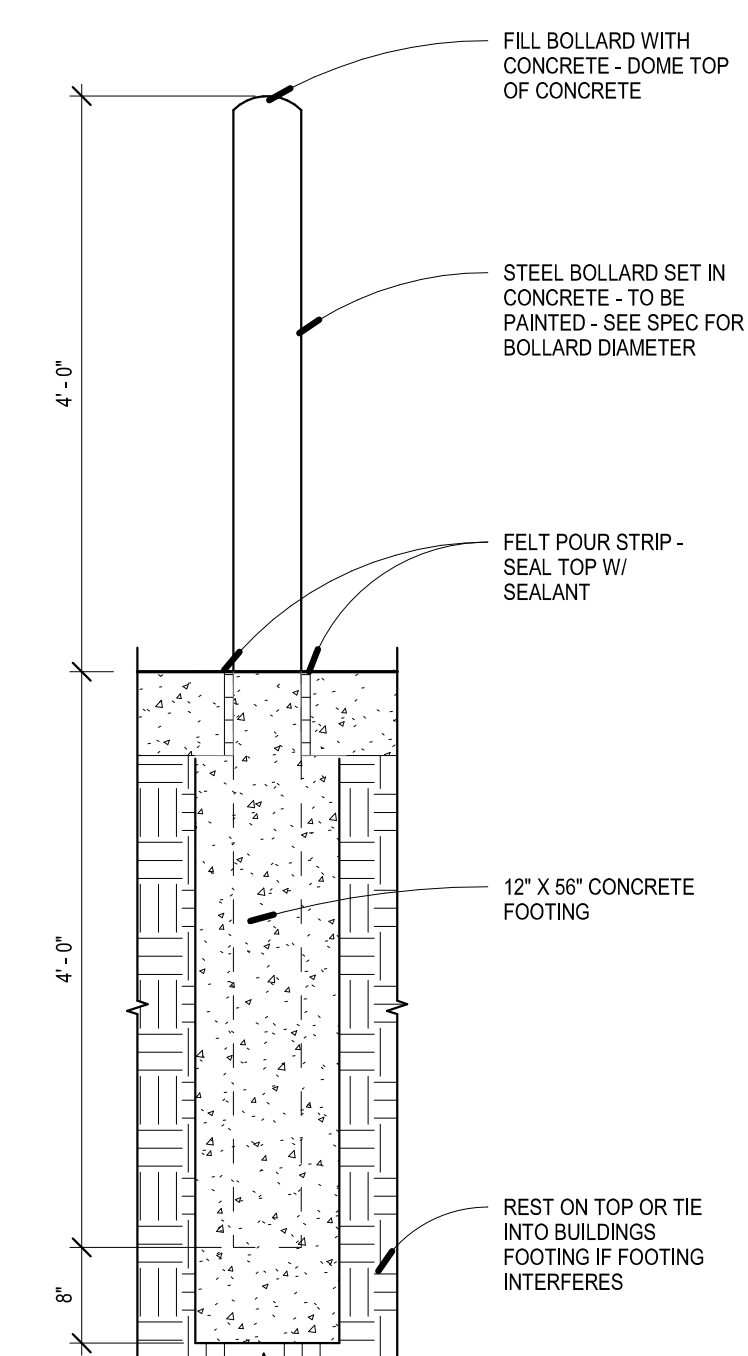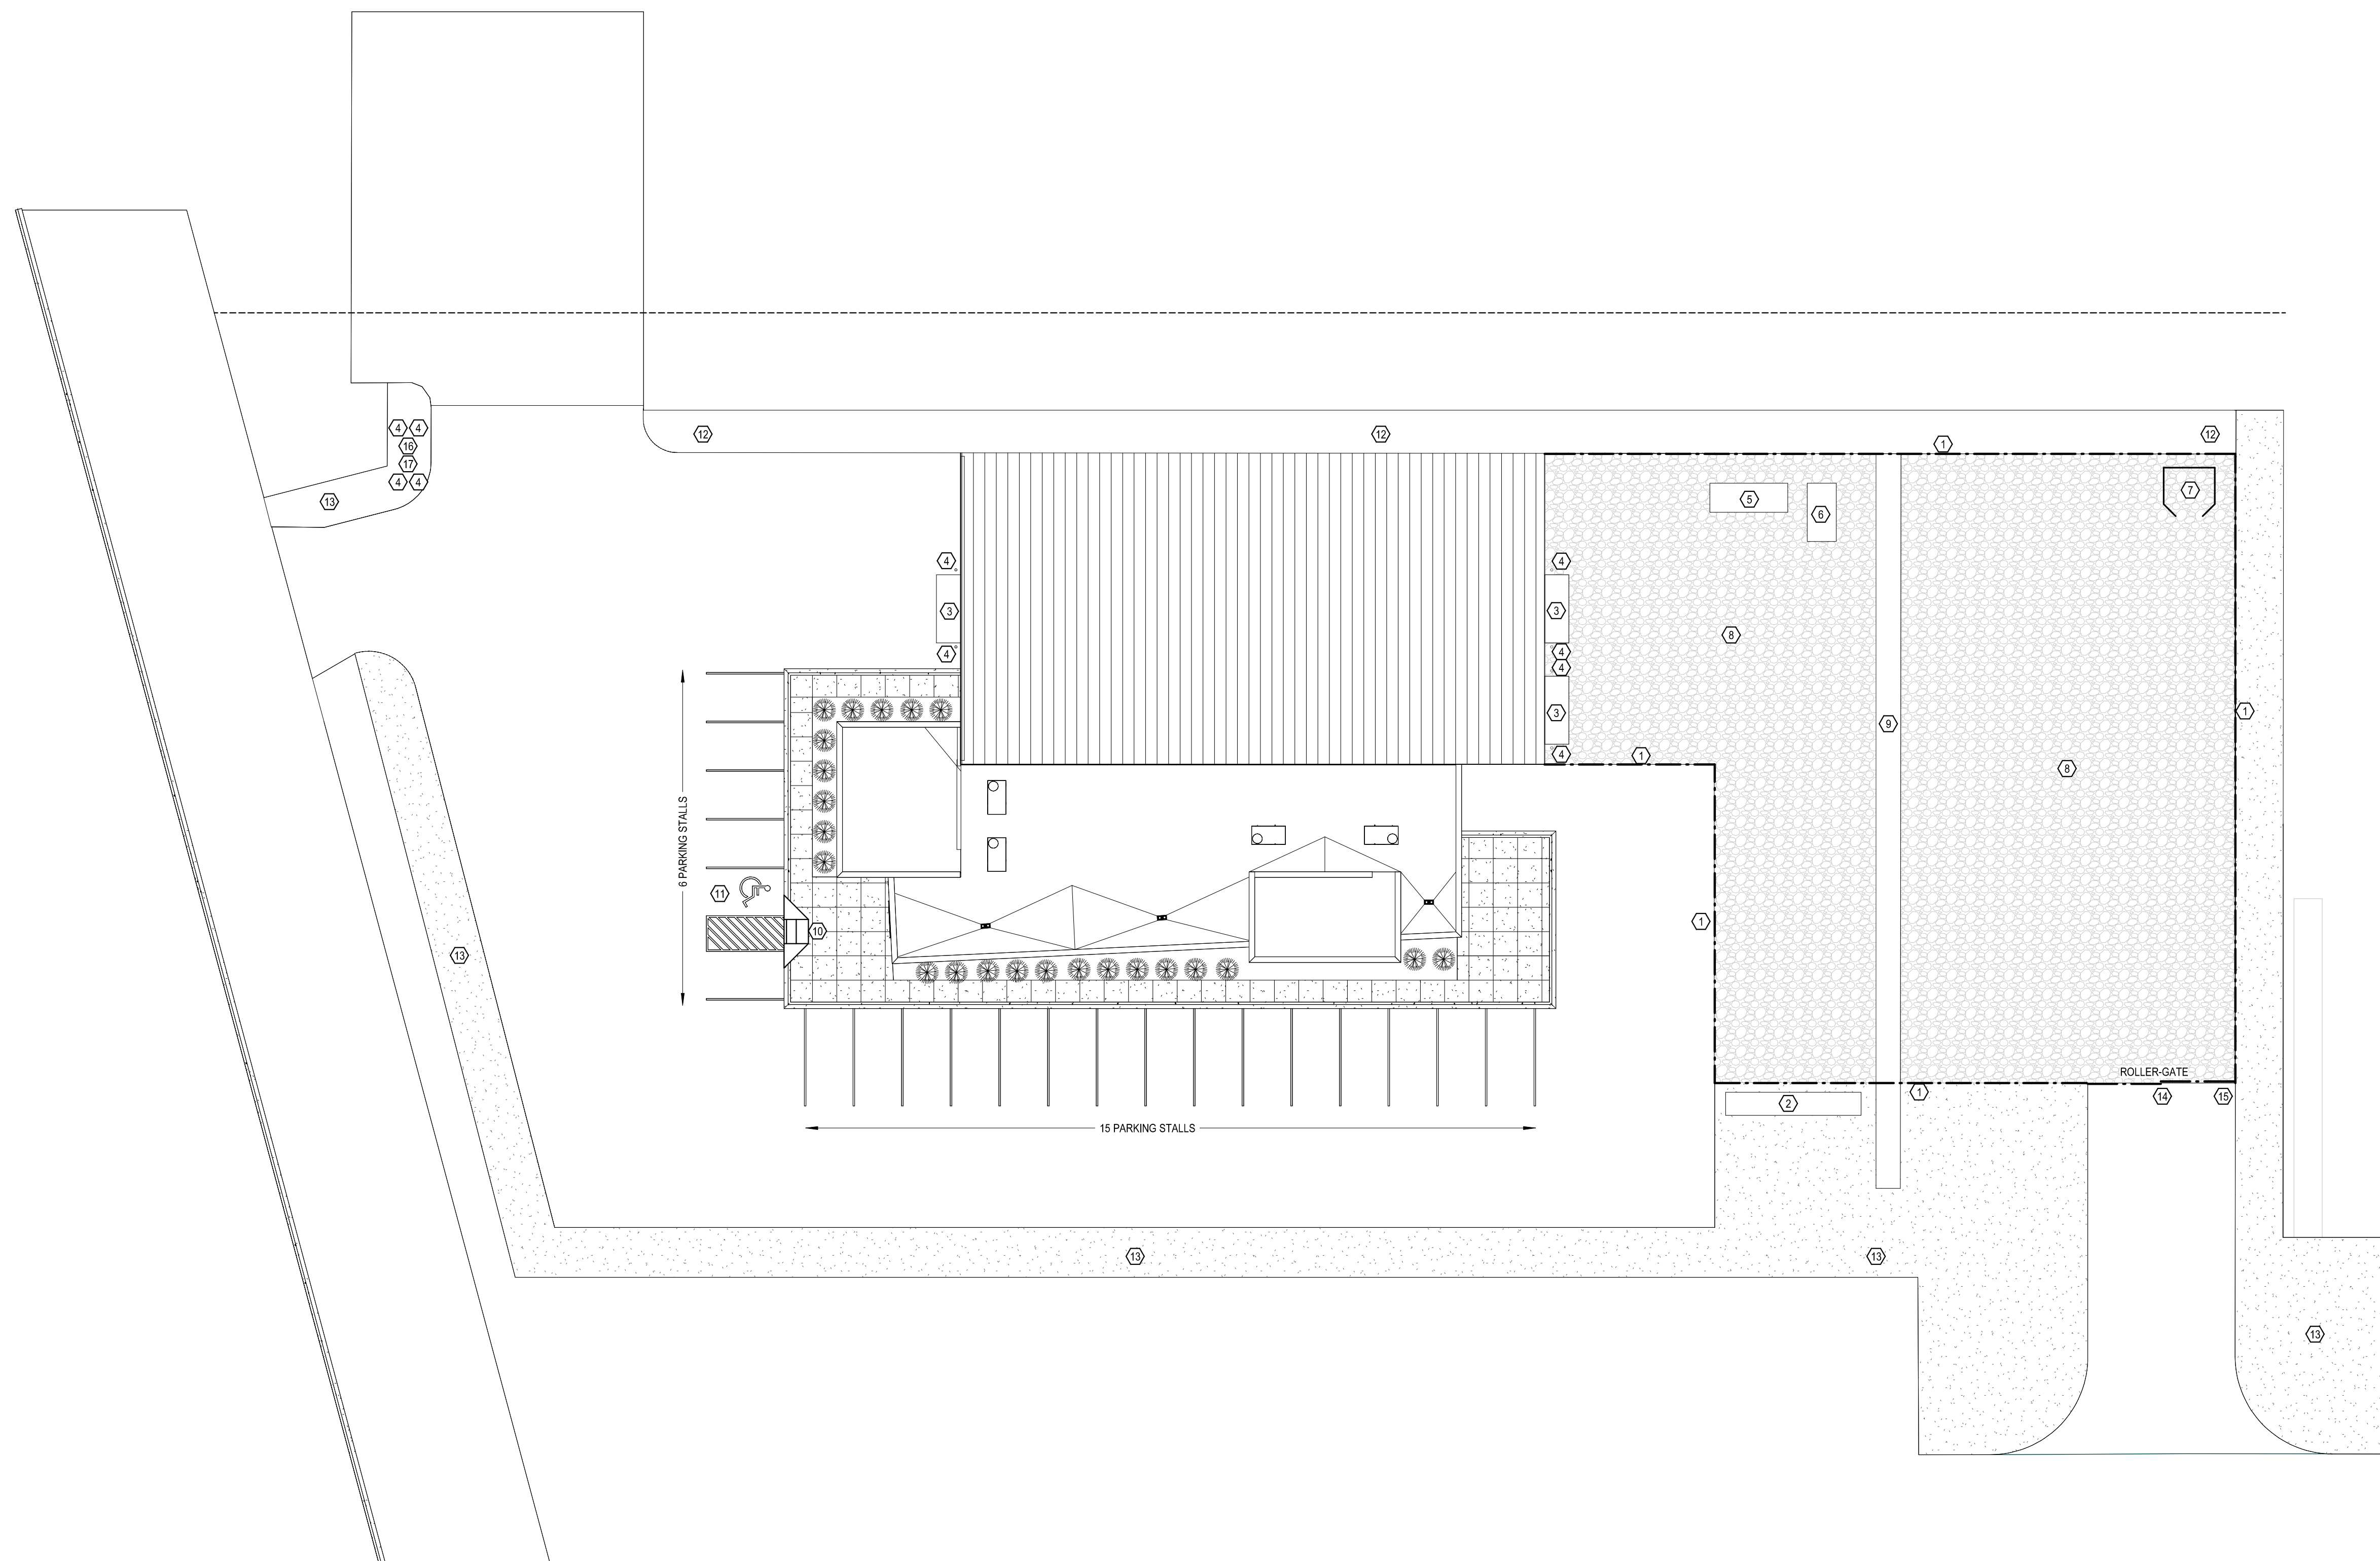

DRAWING HISTORY

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1	CONSTRUCTION DOCUMENTS	01/15/2025

DRAWN BY: Author JN: 24-054

Architectural Site Plan

SHEET

A001



S STEEL STUD W/ GYPSUM - STANDARD				SH STEEL STUD HAT CHANNEL FURRING W/ GYPSUM				SF STEEL STUD FURRING W/ GYPSUM			
<p>UL #404, #419, #423 - 1 HOUR RATING (ASSEMBLY DESIGN RECD WHEN RATING IS PRESENT) (FYI: UL DESIGN COVERS VARIATIONS WITHOUT INSULATION, AND WITH WOOD PANELS AND/OR RESILIENT FURRING CHANNELS.)</p>											
WALL TAG	STUD WIDTH	ASSEMBLY WIDTH	NOTES	WALL TAG	STUD WIDTH	ASSEMBLY WIDTH	NOTES	WALL TAG	STUD WIDTH	ASSEMBLY WIDTH	NOTES
S6	6"	7 1/4" + MODIFIER		SH1	7/8"	1 1/2" + MODIFIER		SF3	3 5/8"	4 1/4" + MODIFIER	

INTERIOR WALL TYPE TAG DESCRIPTION LEGEND

WALL TYPE DESIGNATION SYMBOL:
SEE SPECIFIC WALL TYPE ASSEMBLY FOR DESCRIPTION OF WALL COMPONENTS.

FIRST LETTER INDICATES CONSTRUCTION MATERIAL OF PARTITION WALL:

MATERIAL LEGEND:
S = STEEL STUDS
W = WOOD
M = MASONRY
P = PRECAST
C = CONCRETE

WALL TYPE MODIFIERS:
IF MODIFIER LETTERS ARE LOCATED ON THE TAG, THE FOLLOWING REQUIREMENTS SHALL BE IMPLEMENTED INTO THE WALL ASSEMBLY:

R = IMPACT RESISTANT GYPSUM BOARD (INSTALL FROM FLOOR TO 8' A.F.F.)
A = ACOUSTICAL SEAL ALL PENETRATIONS, AND SIDES, TOP AND BOTTOM OF WALL - BOTH SIDES
S = STRUCTURAL WOOD SHEAR PANEL (FINAL LOCATIONS BY STRUCTURAL) (IF NOT COORDINATED - DELETE)
N = NO ACOUSTICAL BATT INSULATION
X = ADDITIONAL MODIFIERS MAY BE ADDED BY ARCHITECT - VARIES PER PROJECT. MODIFIERS TO BE SIMPLE AND CLEAR, OTHERWISE CREATE A NEW WALL TYPE.

WALL HEIGHT INDICATOR:
IF A NUMBER IS NOTED, FOLLOWED BY AFF, THE REFERENCE IS TO INDICATE WALL HEIGHT ABOVE FINISHED FLOOR.

WALL TAG W/ MODIFIERS
???
? HR

GENERAL NOTES - FRAMED PARTITIONS

- ALL LOAD BEARING WALLS TO BE CONSTRUCTED PER STRUCTURAL ENGINEERS DESIGN REQUIREMENTS. SEE STRUCTURAL SHEETS FOR INFORMATION.
- ALL PENETRATIONS THROUGH FIRE RATED ASSEMBLIES TO BE FIRE SAFE BY THE TRADE/ CONTRACTOR THAT CREATED THE PENETRATION.
- ALL STEEL STUD AND WOOD STUD PARTITIONS TO HAVE BATT INSULATION U.N.O. ON PLANS
- ALL UL ASSEMBLIES SHOWN ARE REPRINTED FROM THE ONLINE CERTIFICATIONS DIRECTORY WITH PERMISSION FROM UNDERWRITERS LABORATORIES INC. COPYRIGHT 2015 UNDERWRITERS LABORATORIES, INC. CONTRACTORS MAY REFER TO WWW.U.L.COM FOR ONLINE ACCESS TO ALL ASSEMBLIES AND MODIFICATIONS.
- PARTITION HEIGHT IS ASSUMED TO EXTEND TO BOTTOM OF ROOF/ FLOOR DECK ABOVE U.N.O. FRAMING AND GYPSUM BOARD TO JOG AROUND JOIST AND BEAMS, WHERE NECESSARY FIRE SAFE GAP WHERE FIRE RATING IS REQUIRED.
- PARTITIONS WITHIN WET AREAS INCLUDING BUT NOT LIMITED TO RESTROOMS AND KITCHENS SHALL HAVE WATER RESISTANT GYPSUM BOARD WHEN GYPSUM BOARD IS CALLED OUT AS THE FINISH IN THE WALL ASSEMBLY.
- CONTRACTOR IS RESPONSIBLE FOR BLOCKING NEEDED FOR ANY WALL MOUNTED ACCESSORY.
- STEEL STUD PARTITIONS ARE TO HAVE DEFLECTION TRACK U.N.O.
- DEFLECTION TRACK TO BE INSTALLED AT TOP OF METAL STUD PARTITIONS WHERE METAL STUD PARTITIONS ARE INSTALLED TO HORIZONTAL HOLLOW CORE PLANK.
- SEE STRUCTURAL DRAWINGS FOR SHEAR WALL LOCATIONS AND SCHEDULES. THE NOTED WALL ASSEMBLY WIDTHS MAY NOT ACCOUNT FOR STRUCTURAL SHEAR PANELS.

GENERAL NOTES - UL WALL ASSEMBLIES

- WHEN HOURLY RATING IS SHOWN ON A WALL TAG, OR ON THE CODE STUDY PLAN, THE WALL IS TO BE CONSTRUCTED PER THE UL ASSEMBLY REQUIREMENTS.

NOTE: UNDERWRITERS LABORATORIES ALLOWS FOR MODIFICATIONS TO INDIVIDUAL DESIGNS. SOME MODIFICATIONS INCLUDE BUT ARE NOT LIMITED TO THE FOLLOWING: SCREWS MAY BE SUBSTITUTED FOR NAILS, ONE FOR ONE WHEN THE HEAD DIAMETER, LENGTH, AND SPACING EQUALS OR EXCEEDS THE REQUIREMENTS FOR THE SPECIFIED NAILS.



GYPSUM BOARD THICKNESS SPECIFIED IN SPECIFIC DESIGNS ARE MINIMUMS. GREATER THICKNESS OF GYPSUM BOARD ARE PERMITTED AS LONG AS THE FASTENER LENGTH IS INCREASED PROPORTIONALLY. ADDITIONAL LAYERS OF GYPSUM BOARD ARE PERMITTED TO BE ADDED TO ANY DESIGN. THE SIZE OF THE STUDS ARE MINIMUMS UNLESS OTHERWISE STATED IN THE DESIGN.

THE GENERIC WALL MAKE-UP SHOWN UNDER EACH WALL TYPE DESIGNATION SHOWS THE DESIGN INTENT FOR THAT SPECIFIC PARTITION, ALTHOUGH IT MAY NOT EXACTLY MATCH THE UL ASSEMBLY. IT HAS BEEN DESIGNED USING THE ALLOWED MODIFICATIONS. THE CONTRACTOR IS TO CONSTRUCT THE WALL BASED ON THE GENERIC MAKE-UP FOLLOWING THE UL DESIGN STANDARD WHEN THE WALL IS RATED. IF THE CONTRACTOR WISHES TO MODIFY COMPONENTS AND REQUIREMENTS OUTLINED IN THE UL ASSEMBLY, APPROVAL FOR A SUBSTITUTION MUST BE PROVIDED BY ARCHITECT PRIOR TO IMPLEMENTING.

GENERAL NOTES


5 PSF = TYP FOR 5/8" GWB EA SIDE
7.5 PSF = TYP FOR WALLS BACKED WITH CEMENTITIOUS BACKER BOARD AND TILE; WALL MOUNTED EQUIPMENT

- BASED ON 16" O.C. STUD SPACING
- USE ONLY FOR NONLOAD BEARING INTERIOR STEEL STUD PARTITION WALLS - DIVISION 9
- BRIDGING SHALL BE REQUIRED ABOVE WHERE GYPSUM BOARD STOPS OR WHERE GYPSUM BOARD IS ONLY ON ONE SIDE OF STUD. LOCATION OF BRIDGING SHALL BE 24" O.C.
- GRAPHIC IS A GENERAL GUIDELINE AND IS NOT LIMITED TO THE OPTIONS GUIDED BY THE STEEL FRAMING INDUSTRY ASSOCIATION (SFA) TECHNICAL GUIDE FOR COLD-FORMED STEEL FRAMING PRODUCTS - "LIMITING WALL HEIGHTS - NON-COMPOSITE". TECHNICAL GUIDE COMPLES WITH THE 2021 IBC, AISI S100-16 AND AISI S240-15. CONTRACTOR SHALL COORDINATE WITH DRAWINGS FOR DESIGN INTENT AND WALL SIZES INDICATED AND COMMUNICATE ANY DISCREPANCIES TO THE ARCHITECT PROMPTLY.

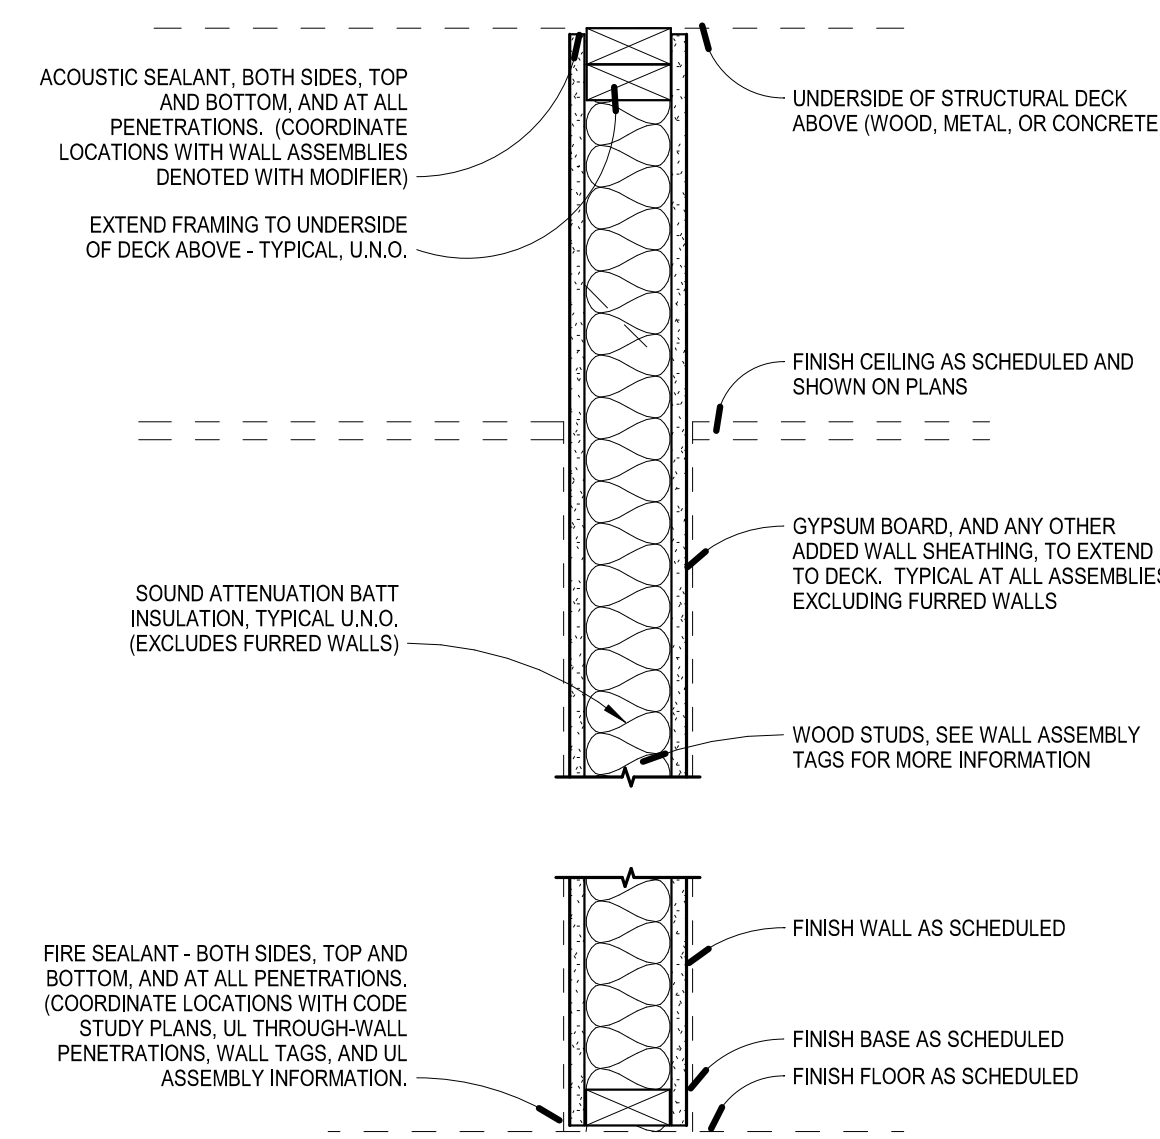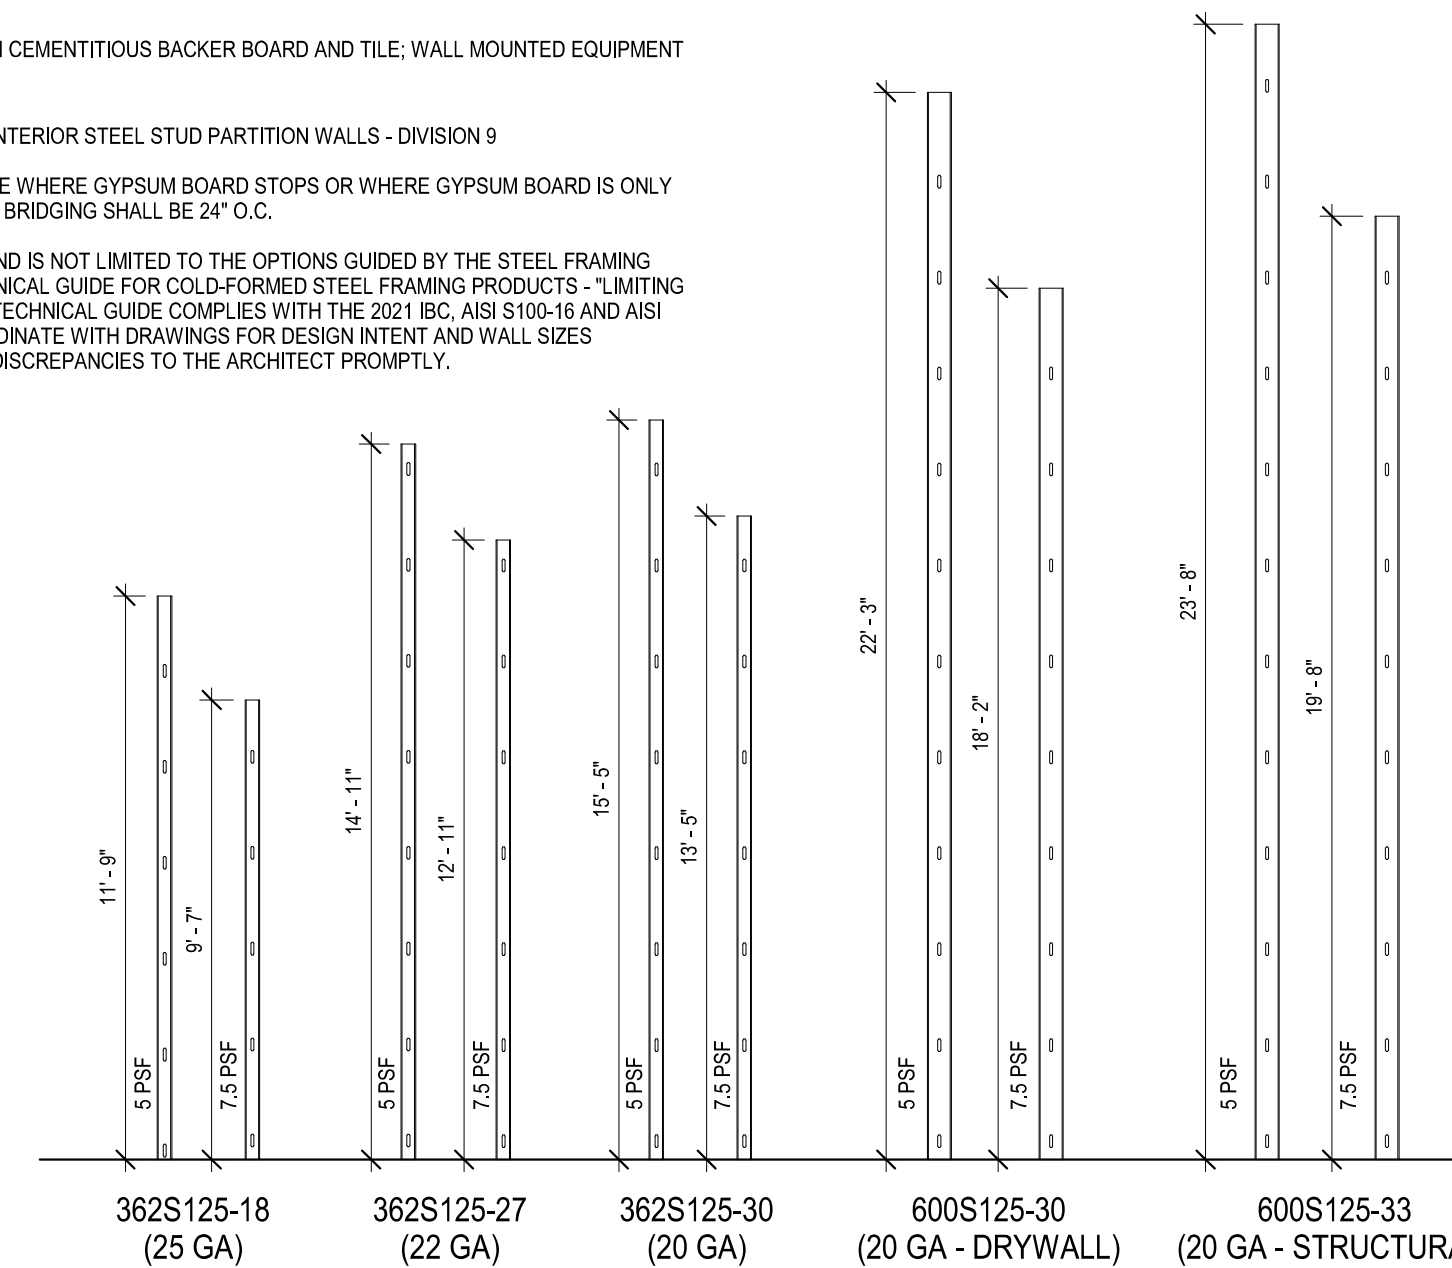

1 Typical Wood Stud Wall Assembly

1 1/2" = 1'-0"

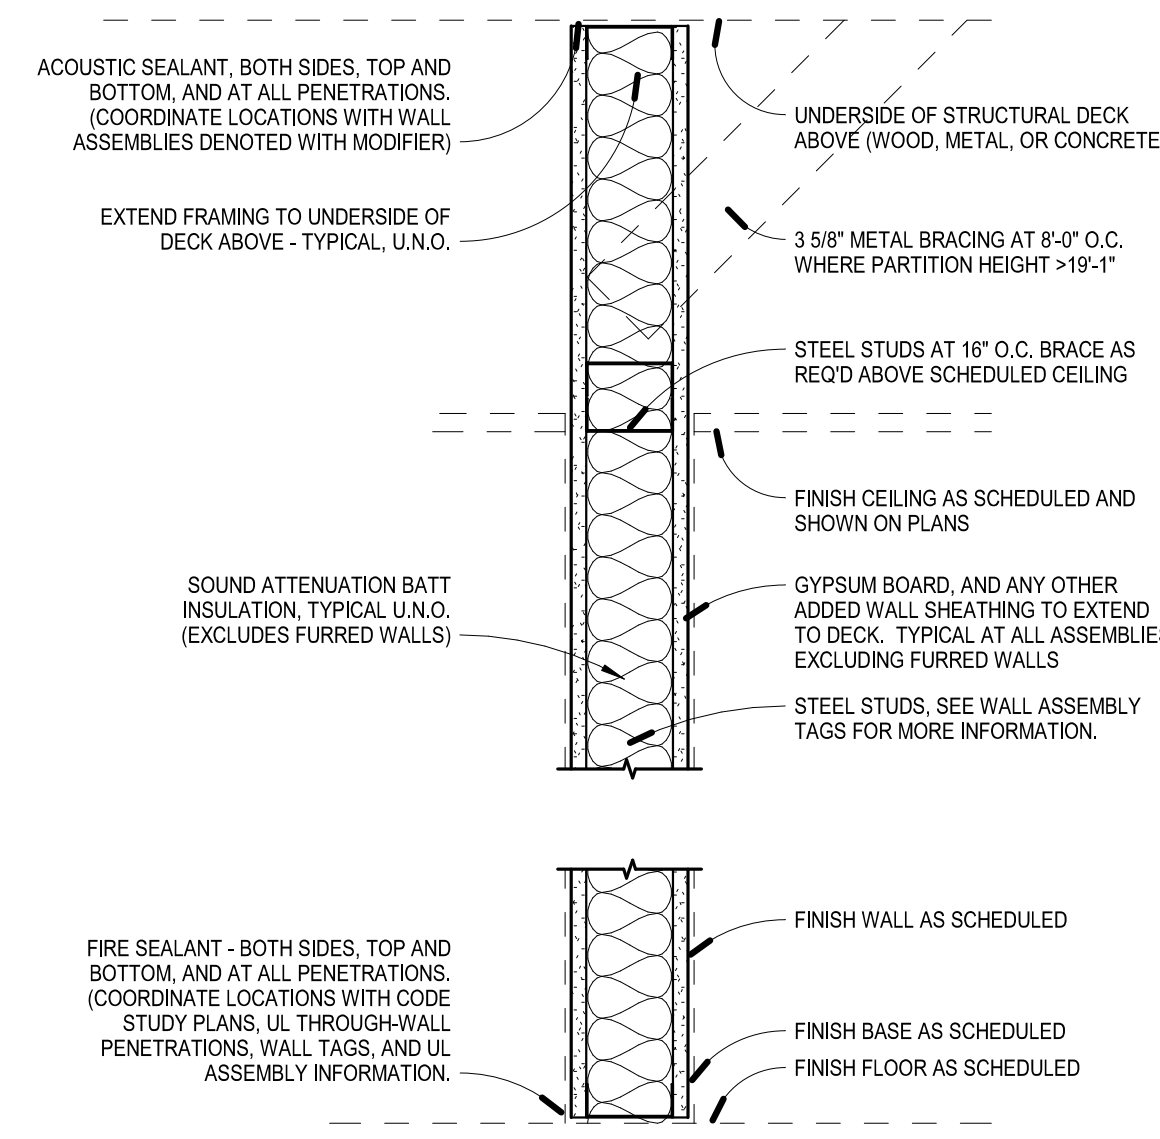

2 Typical Steel Stud Wall Assembly

1 1/2" = 1'-0"



STRUCTURAL

MECHANICAL

ELECTRICAL

CIVIL



DRAWING HISTORY

NO.	DESCRIPTION	DATE
1	CONSTRUCTION DOCUMENTS	01/15/2025

DRAWN BY: Author JN: 24-054

Interior Wall Assemblies

SHEET

A091



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DRAWN BY: Author JN: 24-054

Exterior Wall & Horizontal Assemblies

SHEET
A092

EXTERIOR WALL TYPE TAG DESCRIPTION LEGEND

WALL TYPE DESIGNATION SYMBOL:
SEE SPECIFIC WALL TYPE ASSEMBLY FOR DESCRIPTION OF WALL COMPONENTS.

FIRST LETTER INDICATES FINISH MATERIAL ON THE EXTERIOR WALL SURFACE:
I = INSULATION
N = METAL PANEL
S = NICHHA SIDING

SECOND LETTER INDICATES CONSTRUCTION MATERIAL OF THE BACK-UP WALL:
S = STEEL STUDS
G = GIRT
C = CONCRETE

NUMBER INDICATES DEPTH OF THE BACK-UP WALL CONSTRUCTION MATERIAL:

WALL TYPE MODIFIERS:
IF MODIFIER LETTERS ARE LOCATED ON THE TAG, THE FOLLOWING REQUIREMENTS SHALL APPLY TO THE WALL ASSEMBLY:
R = IMPACT RESISTANT GYPSUM BOARD (INSTALL FROM FLOOR TO F.A.F.F.)
A = ACOUSTICAL SEAL ALL PENETRATIONS, AND SIDES, TOP AND BOTTOM OF WALL - BOTH SIDES
N = NO ACOUSTICAL BATT INSULATION

FIRE RATINGS AT WALL ASSEMBLY:
IF AN HOURLY FIRE RATING IS PRESENT, CONSTRUCT WALL PER LISTED UL DESIGN NOTED IN THE WALL TYPE ASSEMBLY. (WALL RATINGS ARE ALSO INDICATED ON CODE STUDY PLANS, IF NOT TAGGED, THE MOST RESTRICTIVE SHALL GOVERN.)

WALL TAG W/ MODIFIERS
???
? HR

GENERAL NOTES - UL WALL ASSEMBLIES

1. WHEN HOURLY RATING IS SHOWN ON A WALL TAG, OR ON THE CODE STUDY PLAN, THE WALL IS TO BE CONSTRUCTED PER THE UL ASSEMBLY REQUIREMENTS.

NOTE: UNDERWRITERS LABORATORIES ALLOWS FOR MODIFICATIONS TO INDIVIDUAL DESIGNS. SOME MODIFICATIONS INCLUDE BUT ARE NOT LIMITED TO THE FOLLOWING: SCREWS MAY BE SUBSTITUTED FOR NAILS, ONE FOR ONE WHEN THE HEAD DIAMETER, LENGTH, AND SPACING EQUALS OR EXCEEDS THE REQUIREMENTS FOR THE SPECIFIED NAILS.

GYPSUM BOARD THICKNESS SPECIFIED IN SPECIFIC DESIGNS ARE MINIMUMS. GREATER THICKNESS OF GYPSUM BOARD ARE PERMITTED AS LONG AS THE FASTENER LENGTH IS INCREASED PROPORTIONALLY. ADDITIONAL LAYERS OF GYPSUM BOARD ARE PERMITTED TO BE ADDED TO ANY DESIGN. THE SIZE OF THE STUDS ARE MINIMUMS UNLESS OTHERWISE STATED IN THE DESIGN.

THE GENERIC WALL MAKE-UP SHOWN UNDER EACH WALL TYPE DESIGNATION SHOWS THE DESIGN INTENT FOR THAT SPECIFIC PARTITION, ALTHOUGH IT MAY NOT EXACTLY MATCH THE UL ASSEMBLY. IT HAS BEEN DESIGNED USING THE ALLOWED MODIFICATIONS. THE CONTRACTOR IS TO CONSTRUCT THE WALL BASED ON THE GENERIC MAKE-UP FOLLOWING THE UL DESIGN STANDARD WHEN THE WALL IS RATED. IF THE CONTRACTOR WISHES TO MODIFY COMPONENTS AND REQUIREMENTS OUTLINED IN THE UL ASSEMBLY, APPROVAL FOR A SUBSTITUTION MUST BE PROVIDED BY ARCHITECT PRIOR TO IMPLEMENTING.

HORIZONTAL ASSEMBLY TYPE DESCRIPTION LEGEND

ASSEMBLY TYPE DESIGNATION SYMBOL:
SEE SPECIFIC ASSEMBLY FOR DESCRIPTION OF CONSTRUCTION MATERIALS.

FIRST LETTER INDICATES THE LOCATION OF THE HORIZONTAL ASSEMBLY:
R = ROOF / CEILING
F = FLOOR / CEILING (OR SLAB)

SECOND LETTER INDICATES CONSTRUCTION MATERIAL AT THE HORIZONTAL ASSEMBLY:
S = STEEL TRUSSES AND/OR BEAMS
C = CONCRETE OR COMPOSITE SYSTEMS

NUMBERS ARE USED TO DIFFERENTIATE BETWEEN INDIVIDUAL ASSEMBLY TYPES. THEY DO NOT INDICATE ASSEMBLY DEPTHS.

FIRE RATINGS AT ASSEMBLY:
IF AN HOURLY FIRE RATING IS PRESENT, CONSTRUCT ASSEMBLY PER LISTED UL DESIGN NOTED IN THE ASSEMBLY TYPE. (RATINGS ARE ALSO INDICATED ON CODE STUDY PLANS, IF NOT TAGGED ON THE BUILDING OR WALL SECTIONS, THE MOST RESTRICTIVE SHALL GOVERN.)

TYPICAL HORIZONTAL ASSEMBLY TAG
??


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1. WHEN HOURLY RATING IS SHOWN ON A WALL TAG, OR ON THE CODE STUDY PLAN, THE WALL IS TO BE CONSTRUCTED PER THE UL ASSEMBLY REQUIREMENTS.

NOTE: UNDERWRITERS LABORATORIES ALLOWS FOR MODIFICATIONS TO INDIVIDUAL DESIGNS. SOME MODIFICATIONS INCLUDE BUT ARE NOT LIMITED TO THE FOLLOWING: SCREWS MAY BE SUBSTITUTED FOR NAILS, ONE FOR ONE WHEN THE HEAD DIAMETER, LENGTH, AND SPACING EQUALS OR EXCEEDS THE REQUIREMENTS FOR THE SPECIFIED NAILS.


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THE GENERIC ASSEMBLY MAKE-UP SHOWN UNDER EACH TYPE DESIGNATION SHOWS THE DESIGN INTENT FOR THAT SPECIFIC HORIZONTAL ASSEMBLY, ALTHOUGH IT MAY NOT EXACTLY MATCH THE UL ASSEMBLY. IT HAS BEEN DESIGNED USING THE ALLOWED MODIFICATIONS. THE CONTRACTOR IS TO CONSTRUCT THE WALL BASED ON THE GENERIC MAKE-UP FOLLOWING THE UL DESIGN STANDARD WHEN THE WALL IS RATED. IF THE CONTRACTOR WISHES TO MODIFY COMPONENTS AND REQUIREMENTS OUTLINED IN THE UL ASSEMBLY, APPROVAL FOR A SUBSTITUTION MUST BE PROVIDED BY ARCHITECT PRIOR TO IMPLEMENTING.




NOTE: MUST MEET IECC 2021 REQUIREMENTS. R-26 MIN. WALL ASSEMBLY

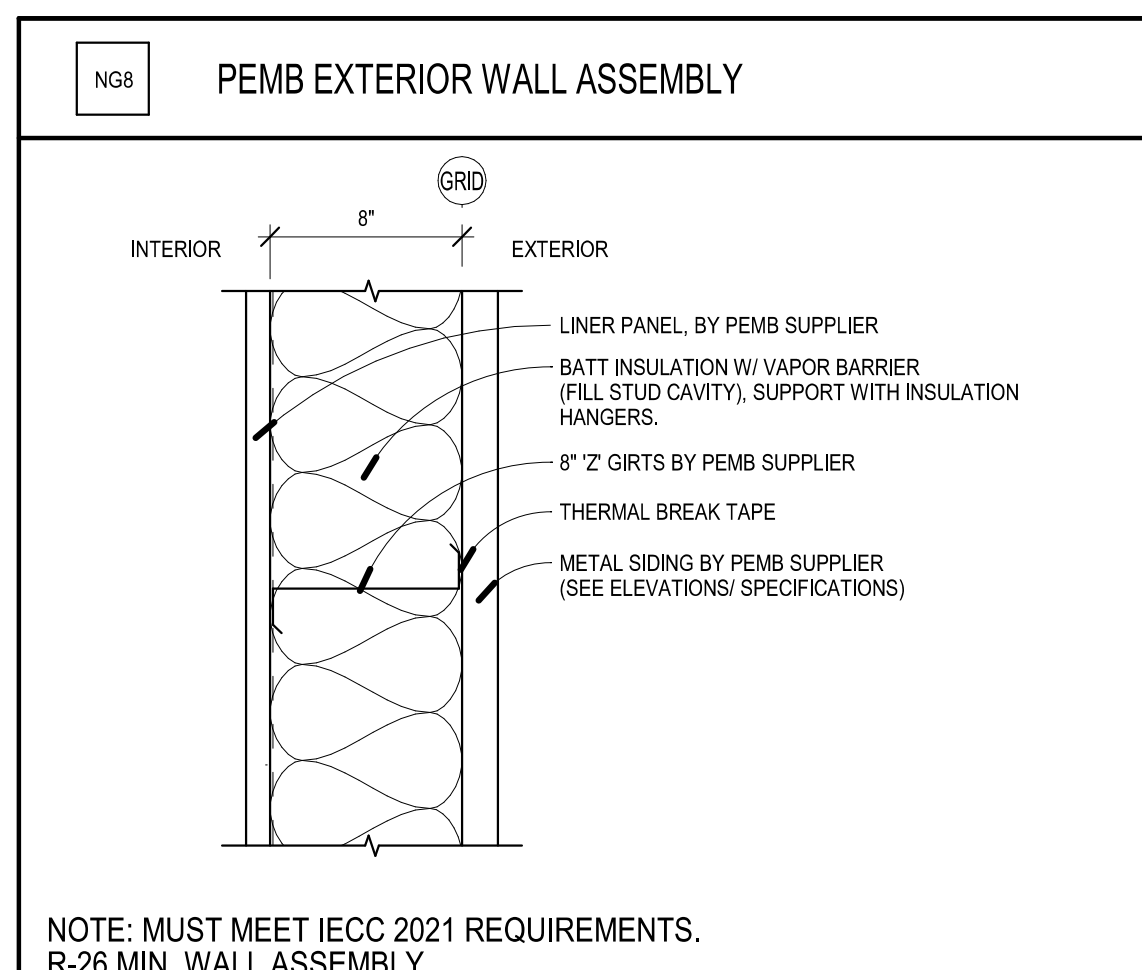
WALL TAG	STUD WIDTH	ASSEMBLY WIDTH	NOTES
NG8	8"	8" (+ MTL & LINER PANEL)	

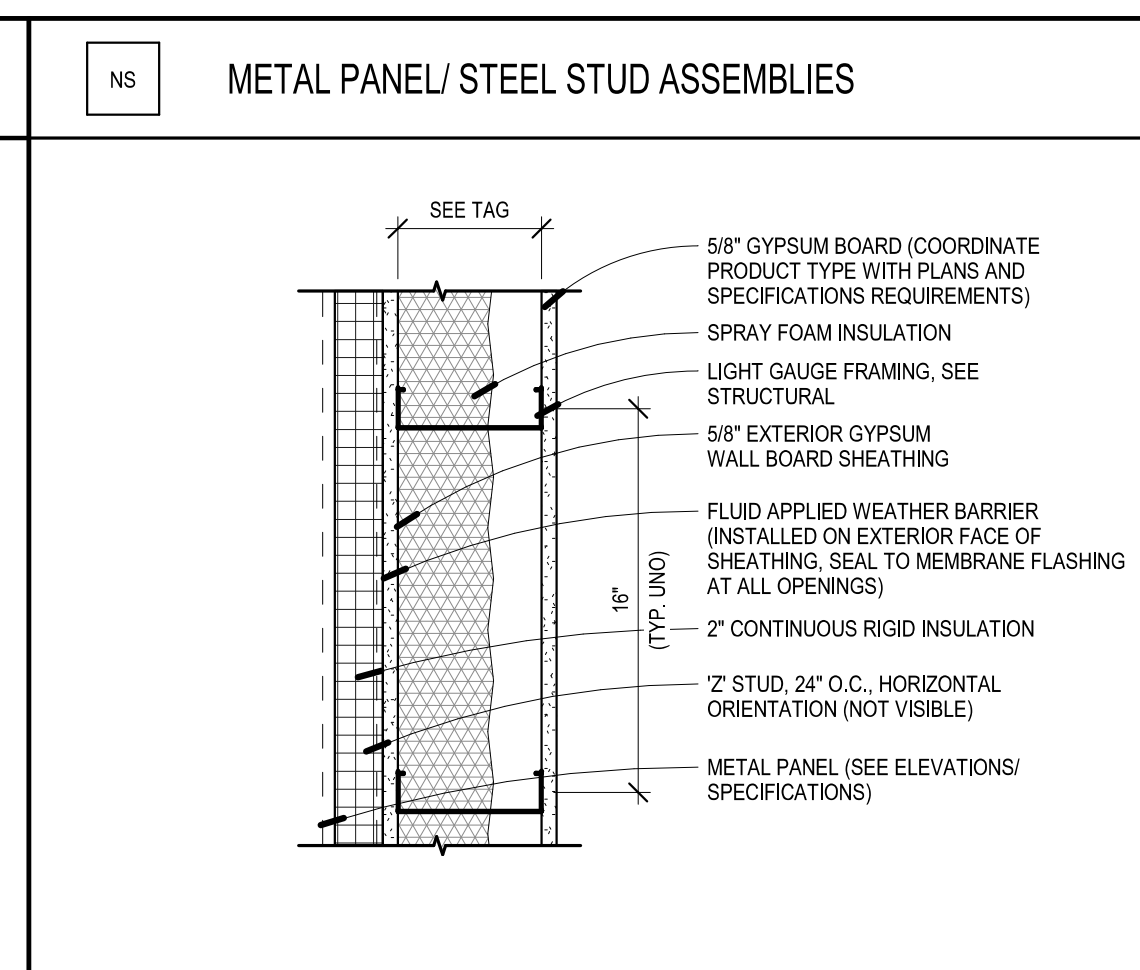

WALL TAG	STUD WIDTH	ASSEMBLY WIDTH	NOTES
NS6	6"	+/- 9 1/4" (+ MTL PANEL)	

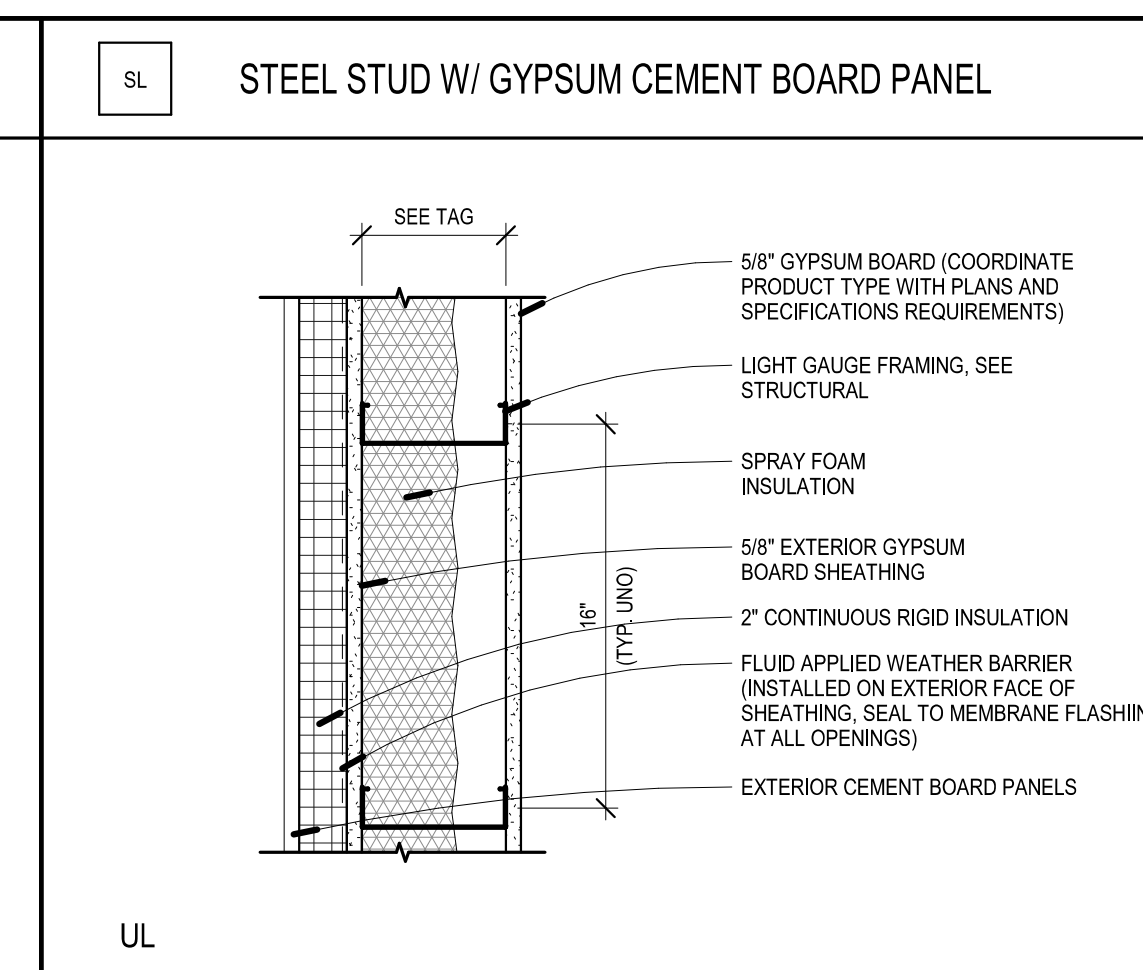


WALL TAG	STUD WIDTH	ASSEMBLY WIDTH	NOTES
SL6	6"	+/- 9 7/8"	



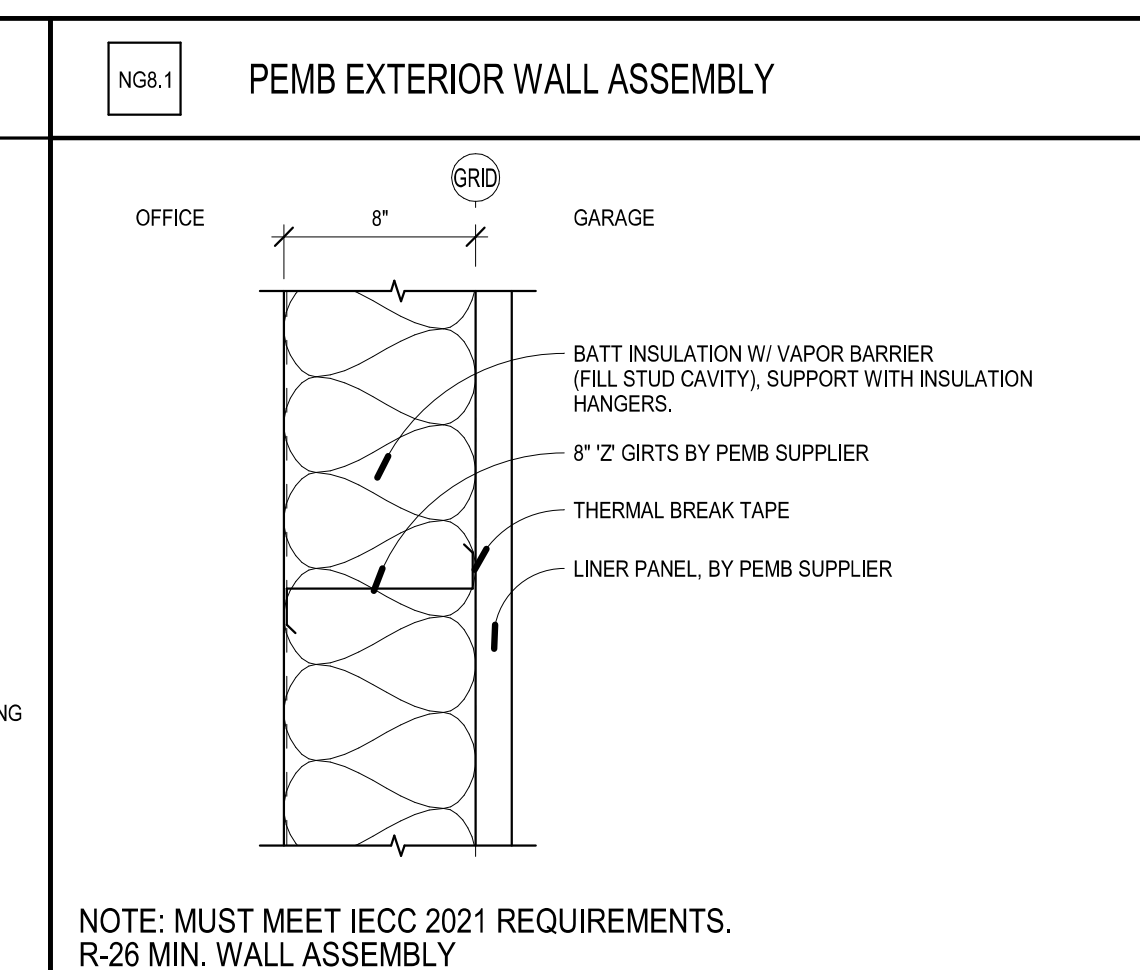


NOTE: MUST MEET IECC 2021 REQUIREMENTS. R-26 MIN. WALL ASSEMBLY

WALL TAG	STUD WIDTH	ASSEMBLY WIDTH	NOTES
NG8.1	8"	8" (+ MTL PANEL)	

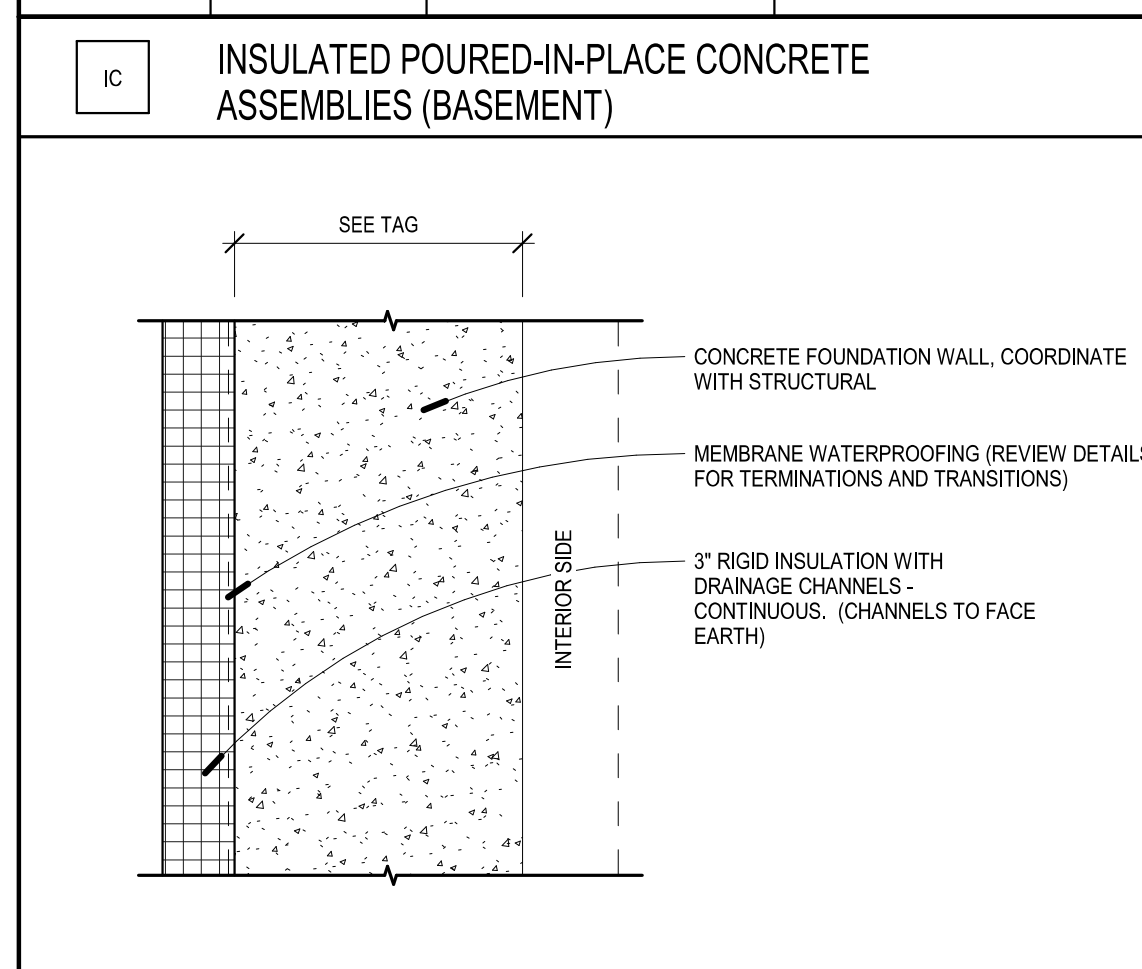

WALL TAG	WIDTH	ASSEMBLY WIDTH	NOTES
IC8	8"	-	
IC10	10"	-	
IC12	12"	-	

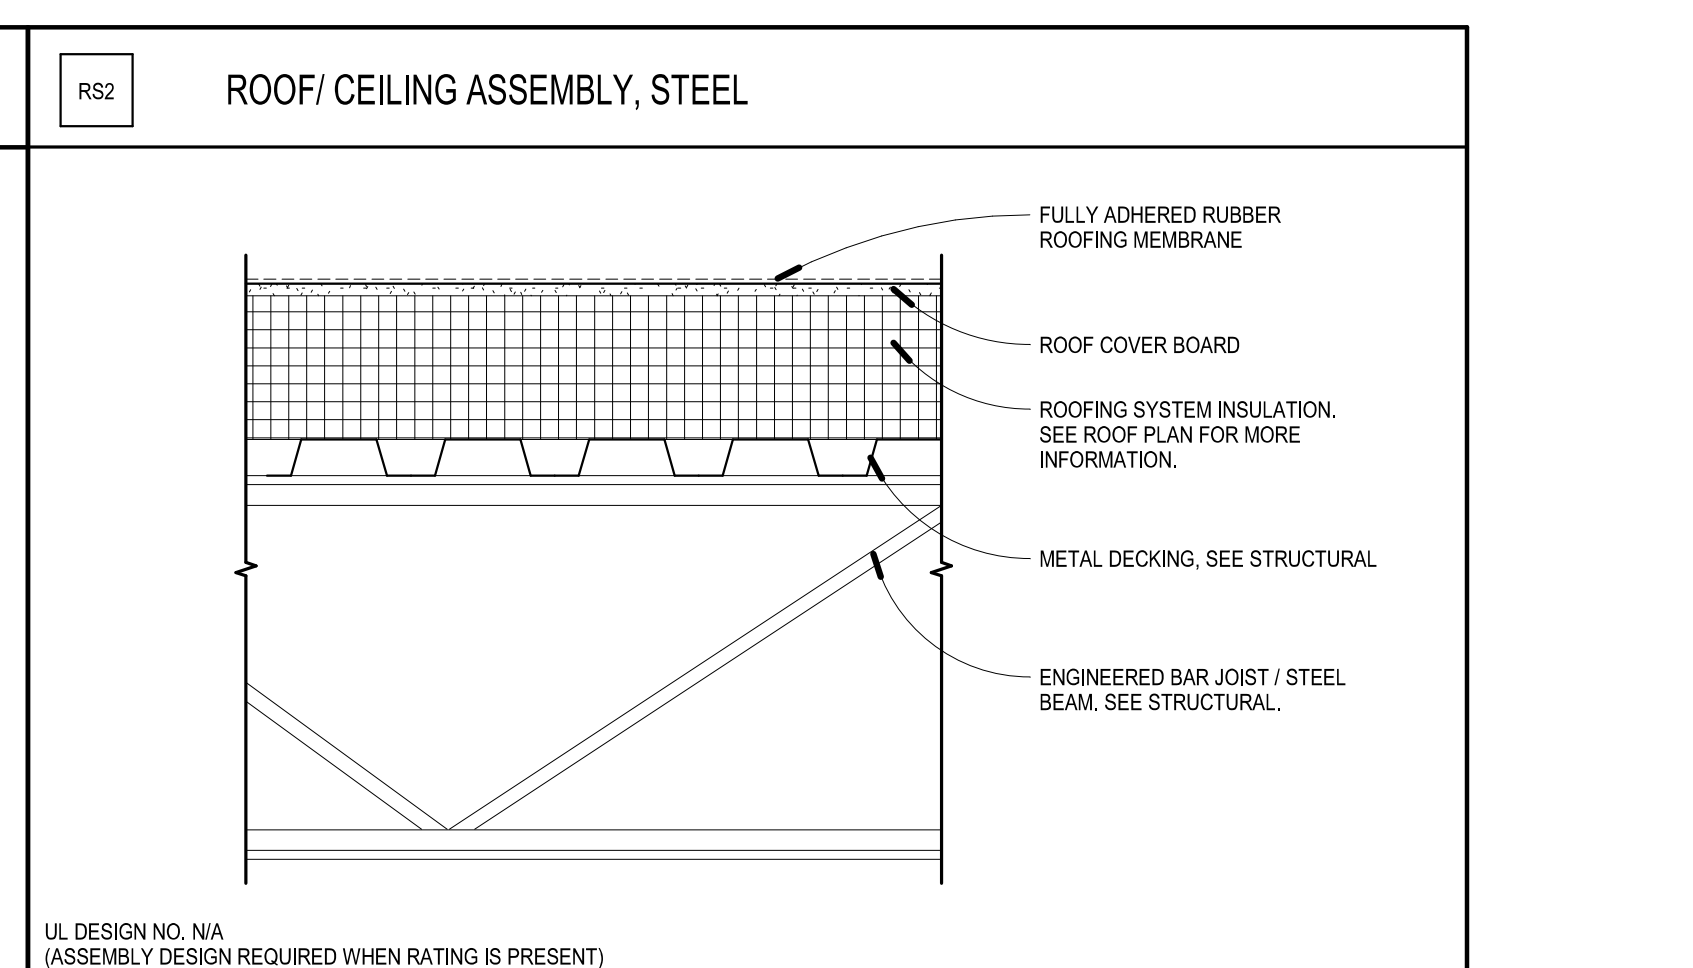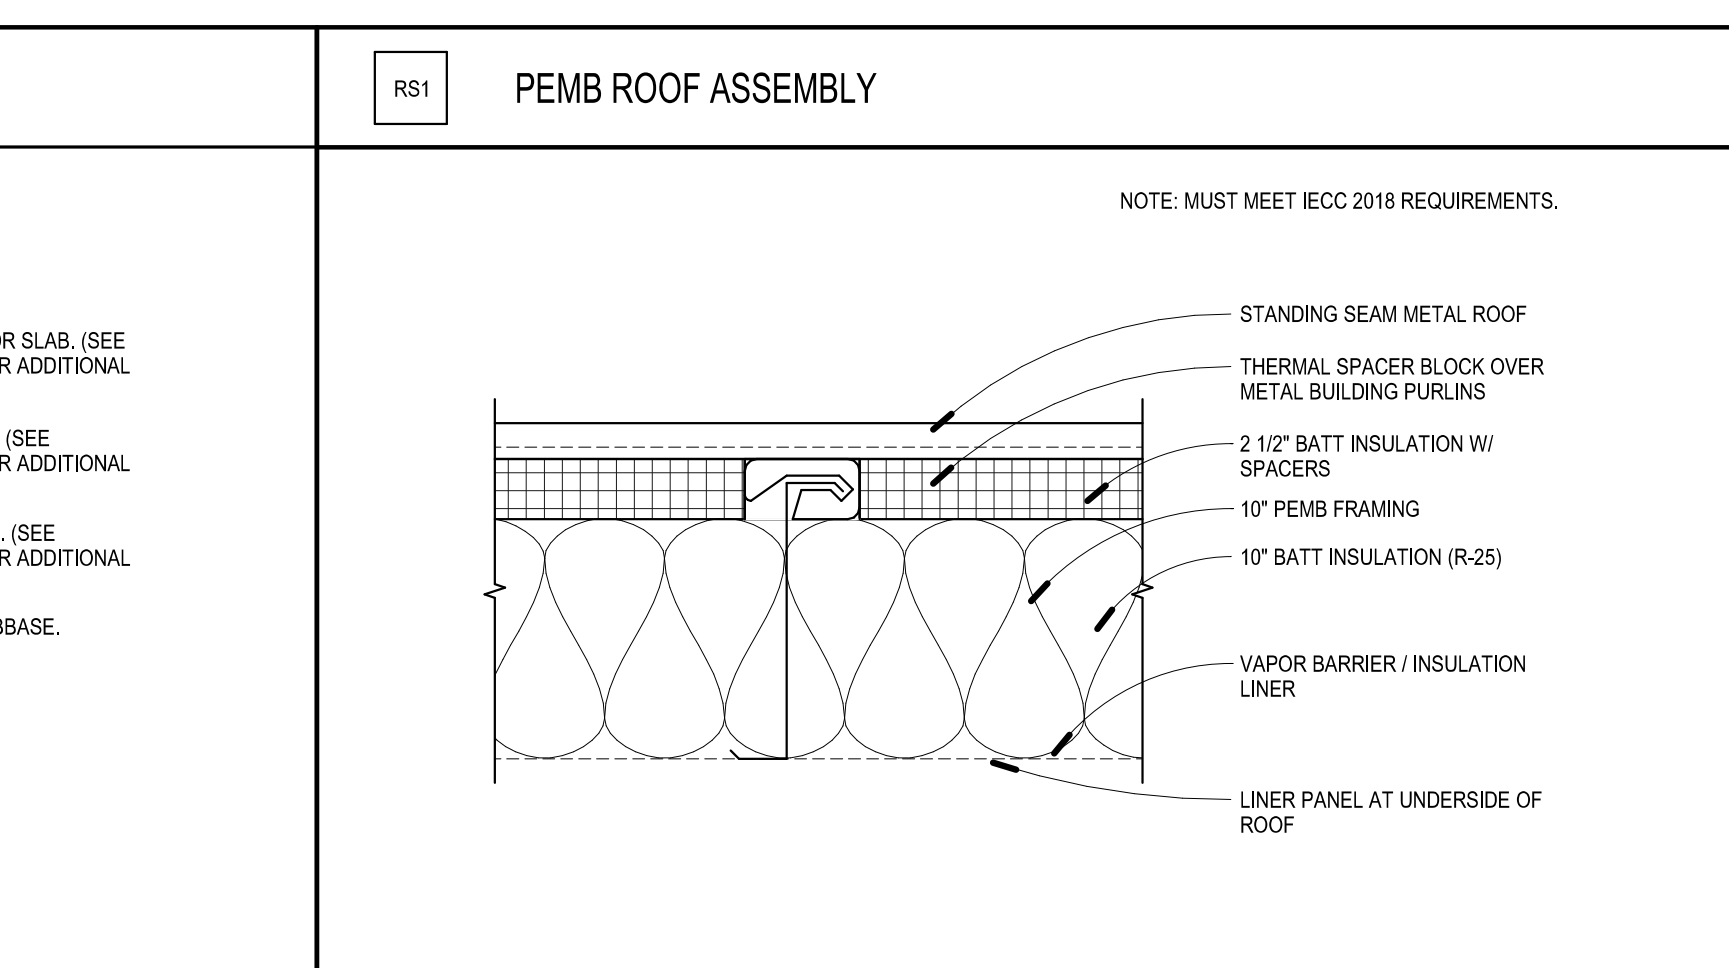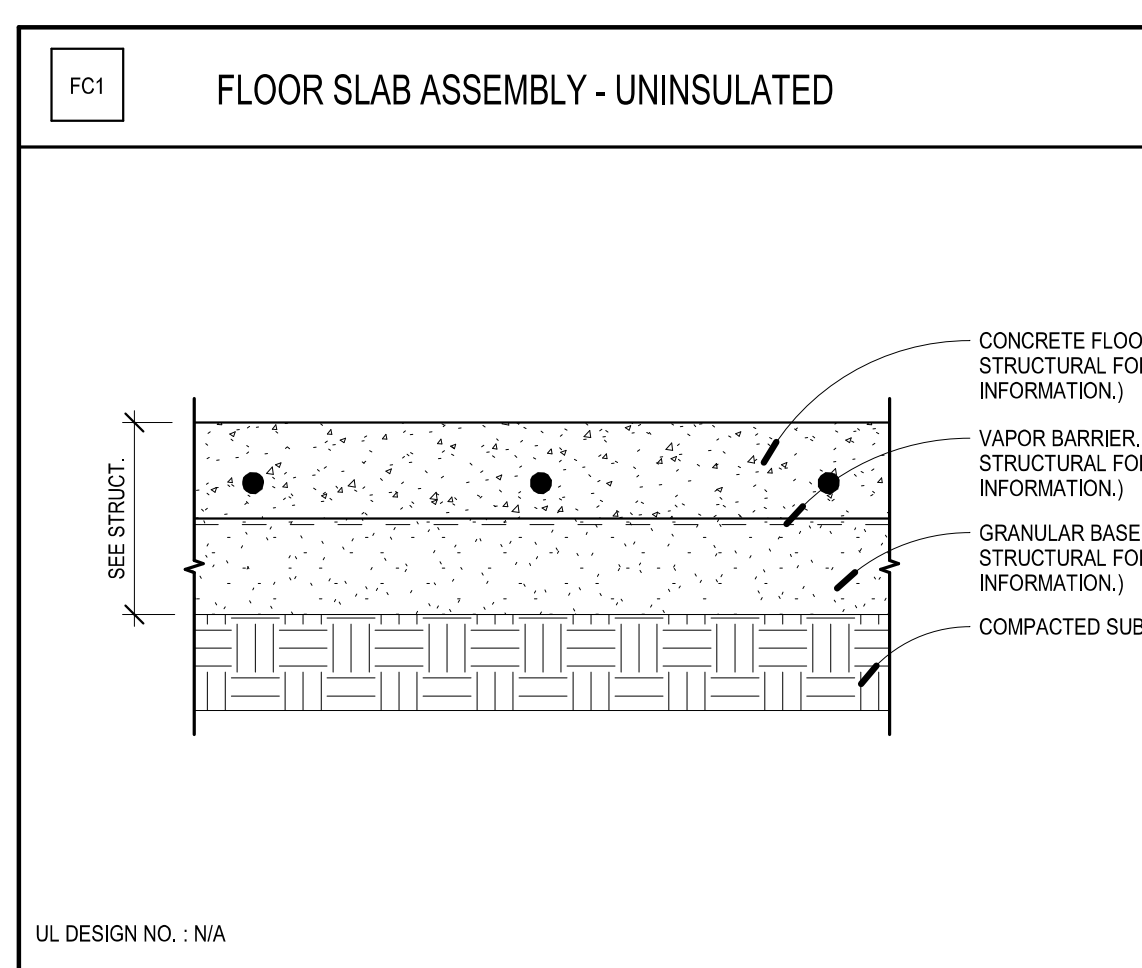

1/15/2025 2:38:36 PM Autodesk Docs:224-054 UTMA-054 UTMA-054 UTMA-054



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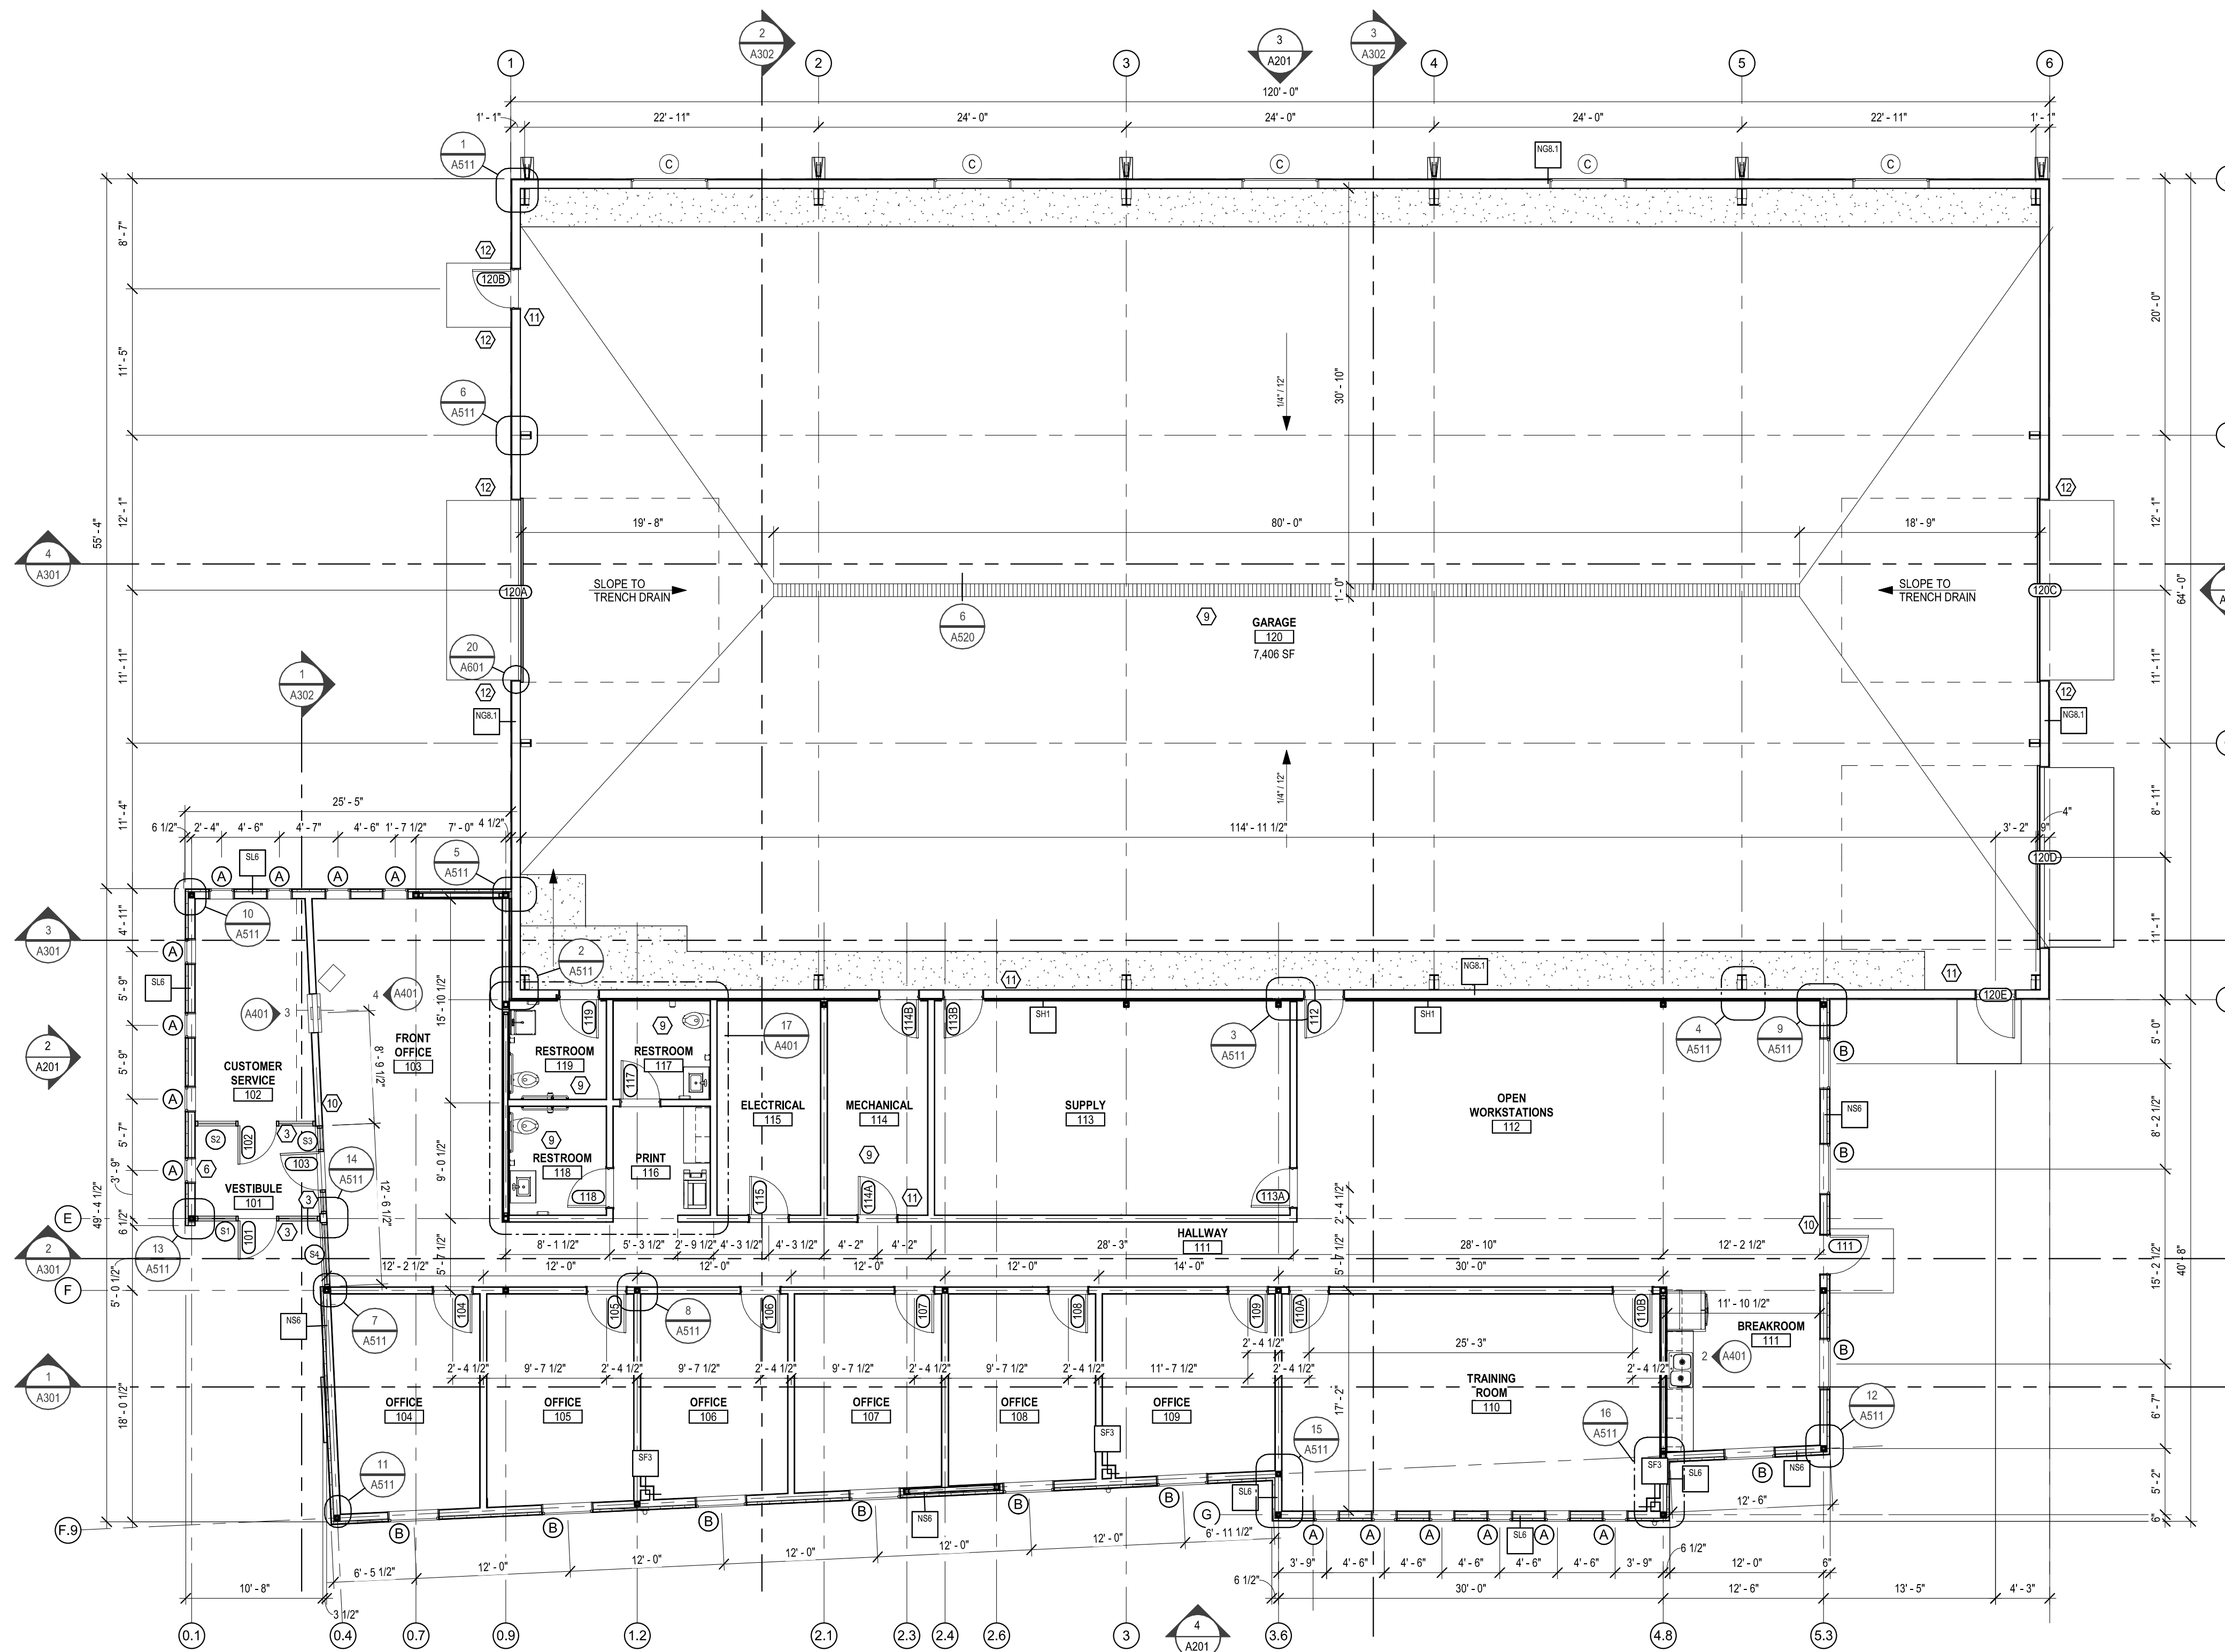
GENERAL NOTES - FLOOR PLAN

- COORDINATE WALL TYPES AND RATINGS, AND HORIZONTAL ASSEMBLY RATINGS & TAGS, WITH CODE STUDY DRAWINGS AND ASSEMBLY TYPE DRAWINGS.
- ALL INTERIOR WALLS TO BE TYPE S6, UNLESS NOTED OTHERWISE. ALL INTERIOR FURRING WALLS TO BE TYPE SF3, UNLESS NOTED OTHERWISE.
- EXTERIOR DIMENSIONS ARE TO FACE OF STUD OR NOMINAL FACE OF METAL PANEL AT FRAMED WALLS. (VERIFY ACTUAL THICKNESS OF WALL ASSEMBLY)
- INTERIOR DIMENSIONS ARE TO CENTER OF STUD OR FACE OF STUD AT FURRING WALLS. (WHERE A CLR NOTE IS PROVIDED BELOW THE DIMENSION STRING, THE DISTANCE PROVIDED IS A MINIMUM BETWEEN FINISHED SURFACES.) DIMENSIONS INDICATED AS "CLEAR" SHALL BE MAINTAINED IN CASE OF DISCREPANCY.
- DIMENSIONS ARE SHOWN TO NOMINAL / WHOLE NUMBER. OPENING SIZES ARE TO ACCOUNT FOR WOOD BUCKING. COORDINATE WITH DETAILS. COORDINATE ALL ROUGH OPENINGS WITH THE ACTUAL WINDOW UNIT, DOOR FRAME, CURTAIN WALLS (STOREFRONT, OR LOUVER SIZES AND REQUIREMENTS).
- ALL WINDOW OPENINGS IN BRICK ARE MASONRY OPENINGS. DIMENSIONS ARE SHOWN TO NOMINAL / WHOLE NUMBER. OPENING SIZES ARE TO ACCOUNT FOR WOOD BUCKING. COORDINATE WITH DETAILS. (WINDOW JAMBS ARE TO ALIGN ON EACH FLOOR.)
- WORK FROM GIVEN DIMENSIONS. IN GENERAL, LARGE-SCALE DETAILS TAKE PRECEDENCE OVER SMALLER SCALE PLANS, ELEVATIONS AND BUILDING SECTIONS. NOTIFY THE ARCHITECT OF ANY DIMENSIONAL DISCREPANCIES PRIOR TO COMMENCING THE WORK, AND DO NOT BEGIN WORK UNTIL SUCH DISCREPANCIES ARE RESOLVED BY THE ARCHITECT.
- DO NOT SCALE THE DRAWINGS.
- UNLESS NOTED OTHERWISE, THE LOCATION OF DOOR FRAMES SHALL BE 4" FROM THE ADJACENT WALL STUDS TO THE HINGE SIDE OF THE ROUGH OPENING.
- GC TO PROVIDE BLOCKING AS REQUIRED FOR INSTALLATION OF CASEWORK, EQUIPMENT, AND ACCESSORIES.
- ITEMS BY OWNER OR NIC SHOWN DASHED GRAY.

12. TYPICAL DETAIL NOTES:
THE FOLLOWING NOTES ARE TYPICAL THROUGHOUT THIS PROJECT AND APPLY IN ALL CASES UNLESS SPECIFICALLY NOTED OTHERWISE. THESE NOTES AND ASSOCIATED DETAILS MAY NOT BE DIRECTLY REFERENCED ON THE DRAWINGS.
- ALL FREESTANDING INTERIOR COLUMNS SHALL BE ENCLOSED WITH GWB ON METAL LGMF.
 - ALL ROOF LEADERS, HEAT PIPING, SPRINKLER RISERS, PLUMBING VENTS, SANITARY PLUMBING OR MISCELLANEOUS PIPING SHALL BE ENCLOSED WITHIN THE WALL CONSTRUCTION.
 - ALL DUCT PENETRATIONS THROUGH FLOORS SHALL BE ENCLOSED IN A CHASE.

KEYNOTES - FLOOR PLAN

- PLACE STUD FRAMING IN A MANNER TO ALLOW FOR DRYWALL TO PASS BY TIGHT TO FACE OF COLUMN ON THE SIDE DEPICTED.
- CENTER STUD FRAMING ON COLUMN OR STEEL FRAME. GWB TO PASS BY ON EACH SIDE OF STEEL WITHOUT INTERRUPTION.
- HANDICAP DOOR ACTUATOR PUSH BUTTON ON STOREFRONT MULLION. COORDINATE WITH ELECTRICAL AND HARDWARE SPECIFICATIONS.
- STEEL STUD FRAMING LOCATED INSIDE STRUCTURAL STEEL DIAGONAL BRACED FRAME. GWB TO PASS BY ON EACH SIDE OF STEEL WITHOUT INTERRUPTION. TYPICAL WHERE TAGGED WITH KEYNOTE, COORDINATE WITH STRUCTURAL.
- NOT USED.
- CABINET UNIT HEATER. COORDINATE WITH MECHANICAL AND ELECTRICAL.
- NOT USED.
- SOLID SURFACE WINDOW SILL - TYPICAL THROUGHOUT AT ALL WINDOWS NOT EXTENDING TO FLOOR LINE.
- FLOOR DRAIN. COORDINATE WITH MECHANICAL.
- FIRE EXTINGUISHER CABINET - RECESSED.
- FIRE EXTINGUISHER ON WALL BRACKET.
- BOLLARD



1 A101 First Floor Plan
1/8" = 1'-0"

DRAWING HISTORY

NO.	DESCRIPTION	DATE
1	CONSTRUCTION DOCUMENTS	01/15/2025

DRAWN BY: BS JN: 24-054

First Floor Plan

SHEET
A101





TURTLE MOUNTAIN COMMUNICATIONS NEW BUILDING
BOTTINEAU, NORTH DAKOTA

STRUCTURAL

ICON ARCHITECTURAL GROUP
222 EAST MAIN STREET, SUITE B
MANDAN, ND 58554
(701) 751.0430 OFFICE

MECHANICAL

MBN ENGINEERING, INC.
503 7TH STREET NORTH, SUITE 200
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ELECTRICAL

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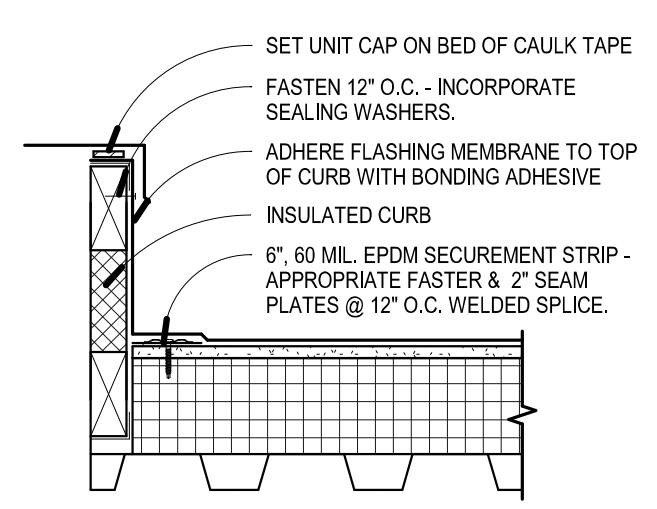
GENERAL NOTES - ROOF PLAN

- COORDINATE FULL EXTENT OF ROOF PENETRATIONS AND EQUIPMENT CURBS WITH MECHANICAL AND ELECTRICAL DRAWINGS.
- ROOF MEMBRANE TO RUN UP VERTICAL PARAPET FACE AND OVER TOP OF WALL. TYPICAL THROUGHOUT. COORDINATE WITH DETAILS.
- CONTRACTOR IS RESPONSIBLE FOR MAKING A WATER-TIGHT ROOF SYSTEM.
- SEE SPECIFICATIONS FOR ROOF SYSTEM WARRANTY REQUIREMENTS.
- PROTECT ALL OPENINGS CUT IN THE ROOF. PROVIDE TEMPORARY ROOFING IF WORK IS TO BE UNFINISHED DURING ADVERSE WEATHER CONDITIONS THROUGHOUT THE CONSTRUCTION PHASE.
- ROOF DRAINAGE SHALL BE SIZED TO MEET PLUMBING REQUIREMENTS AND VERIFIED WITH ARCHITECT.
- PROVIDE FLASHING AT ALL ROOF PENETRATIONS. PENETRATIONS MAY NOT BE INDICATED ON THE ROOF PLAN. REFER TO STRUCTURAL, MECHANICAL AND ELECTRICAL PLANS FOR NUMBER, LOCATION, AND SIZE OF PENETRATIONS. COORDINATE ALL LOCATIONS AND PENETRATIONS WITH PLUMBING, ELECTRICAL, AND HVAC CONTRACTOR.
- TAPERED INSULATION SHALL BE SLOPED 1/4" PER FOOT MINIMUM.
- 2" MIN. ROOF INSULATION AT ROOF DRAINS
- PROTECT ROOFING MATERIALS FROM CONSTRUCTION OPERATIONS.
- PROVIDE CURBS AND PRESSURE TREATED WOOD BLOCKING AS REQUIRED FOR ALL ROOF MOUNTED EQUIPMENT, UNLESS NOTES OTHERWISE.
- CONTRACTOR TO COORDINATE LOCATIONS AND SIZES OF ALL NEW ROOF TOP UNITS. LOADS SHALL BE VERIFIED W/ STRUCTURAL ENGINEER.
- PROVIDE A 2 FEET WIDE WALKWAY WITH PROTECTION STRIPS ENTIRELY AROUND ALL ROOF TOP MECHANICAL UNITS AND CREATE A PROTECTION STRIP PATHWAY, 2 FEET WIDE, FROM THE ROOF ACCESS LOCATION(S) TO EACH MECHANICAL UNIT.


KEYNOTES - ROOF PLAN

- SLOPED ROOF TRUSS W/ 5" MINIMUM ROOF INSULATION ABOVE STRUCTURE DECK.
- CRICKET, (SLOPED INSULATION TO PROVIDE)
- ROOF DRAINS, (PAIRED PRIMARY AND SECONDARY DRAIN BASIN. CONNECT PRIMARY DRAIN TO STORM SEWER IN BASEMENT. SECONDARY DRAIN TO DISCHARGE ABOVE GRADE. SEE ELEVATIONS. COORDINATE WITH MECHANICAL)
- TAPERED INSULATION ABOVE LEVEL DECK. 1/4" / 1' - 0" MINIMUM SLOPE. (_ " MINIMUM INSULATION DEPTH AROUND DRAIN)
- NOT USED
- METAL COPING, TYPICAL AT ALL ROOF PARAPETS (COORDINATE WITH ELEVATIONS AND DETAILS)
- NOT USED
- ROOF TOP EQUIPMENT. SEE MECHANICAL.
- NOT USED
- NOT USED
- NOT USED
- STANDING SEAM METAL ROOFING.


NOTES:
1. REFER TO ROOF ASSEMBLY DETAIL ON A102.
2. EXACT CONDITIONS TO BE FIELD VERIFIED.
3. ALL WORK PER MANUFACTURERS SPECIFICATIONS.
CONTRACTOR TO SUBMIT SHOP DRAWINGS FOR ALL ROOFING DETAILS. SEE PROJECT MANUAL.



4 A105 Curb @ Mech Equip. Detail
1/2" = 1'-0"

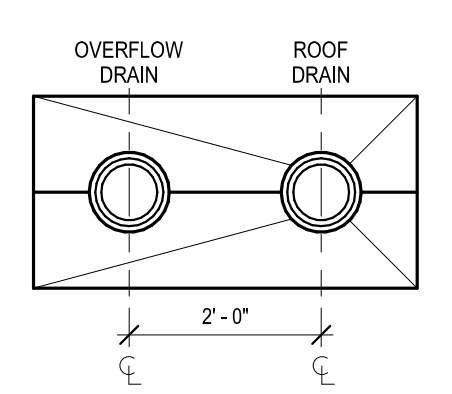


3 A105 Roof Drain Plan Detail
1/2" = 1'-0"

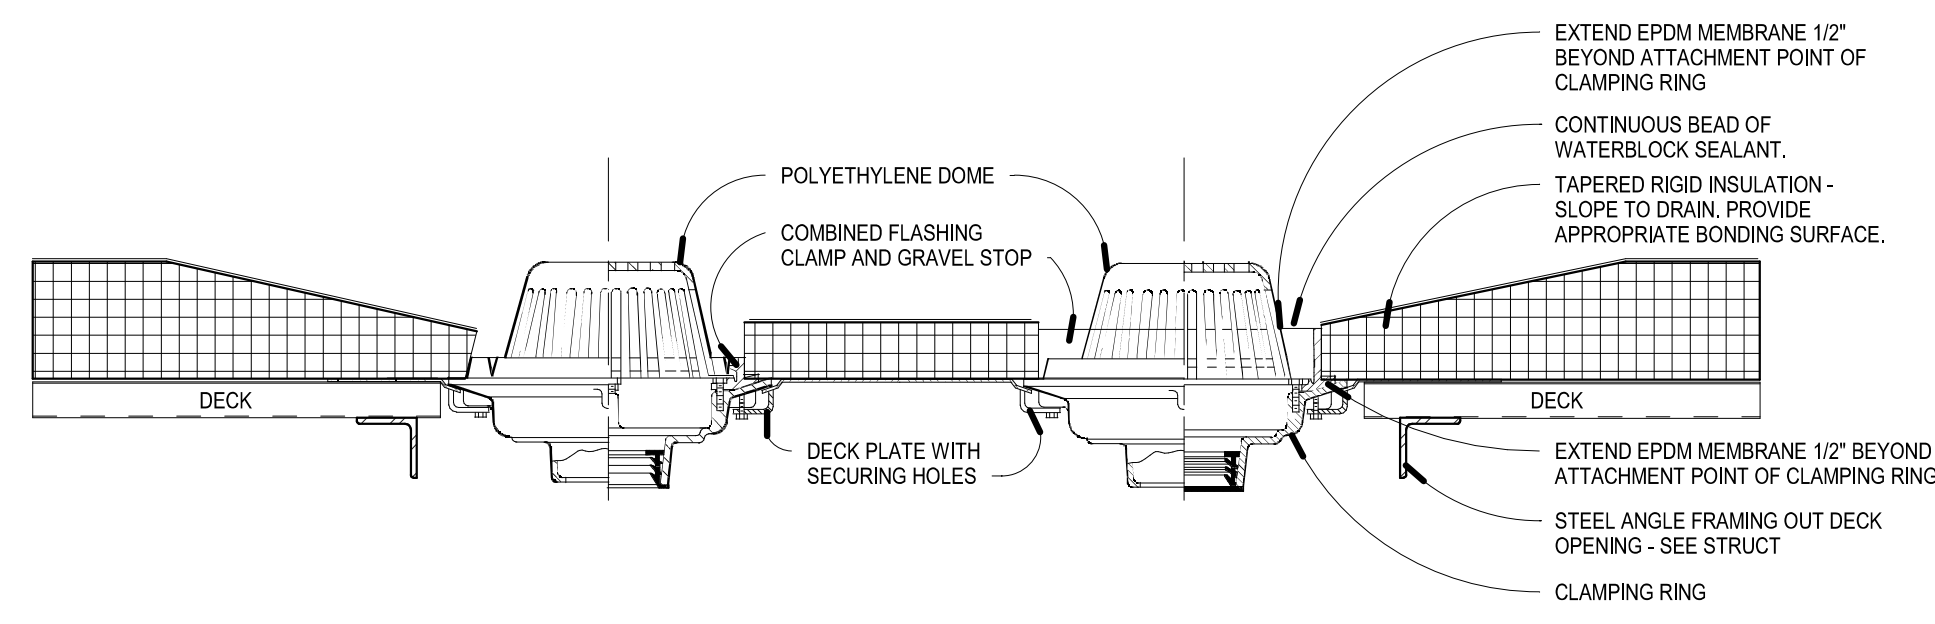


2 A105 Roof Drain & Overflow Detail
1/2" = 1'-0"

NOTES:
1. REFER TO ROOF ASSEMBLY DETAIL ON A102.
2. EXACT CONDITIONS TO BE FIELD VERIFIED.
3. ALL WORK PER MANUFACTURERS SPECIFICATIONS.
CONTRACTOR TO SUBMIT SHOP DRAWINGS FOR ALL ROOFING DETAILS. SEE PROJECT MANUAL.

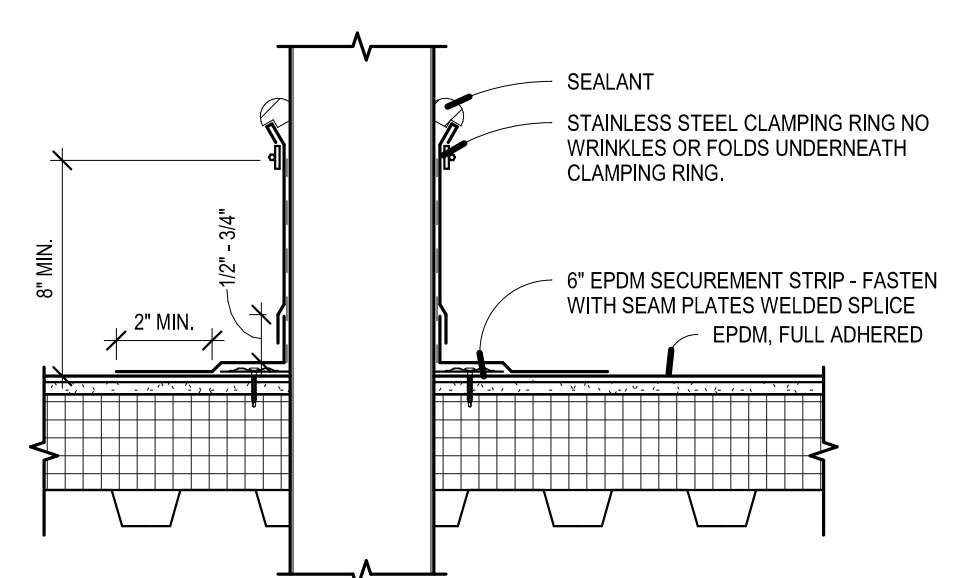

5 A105 Pipe Flashing Detail (Typ.)
1/2" = 1'-0"

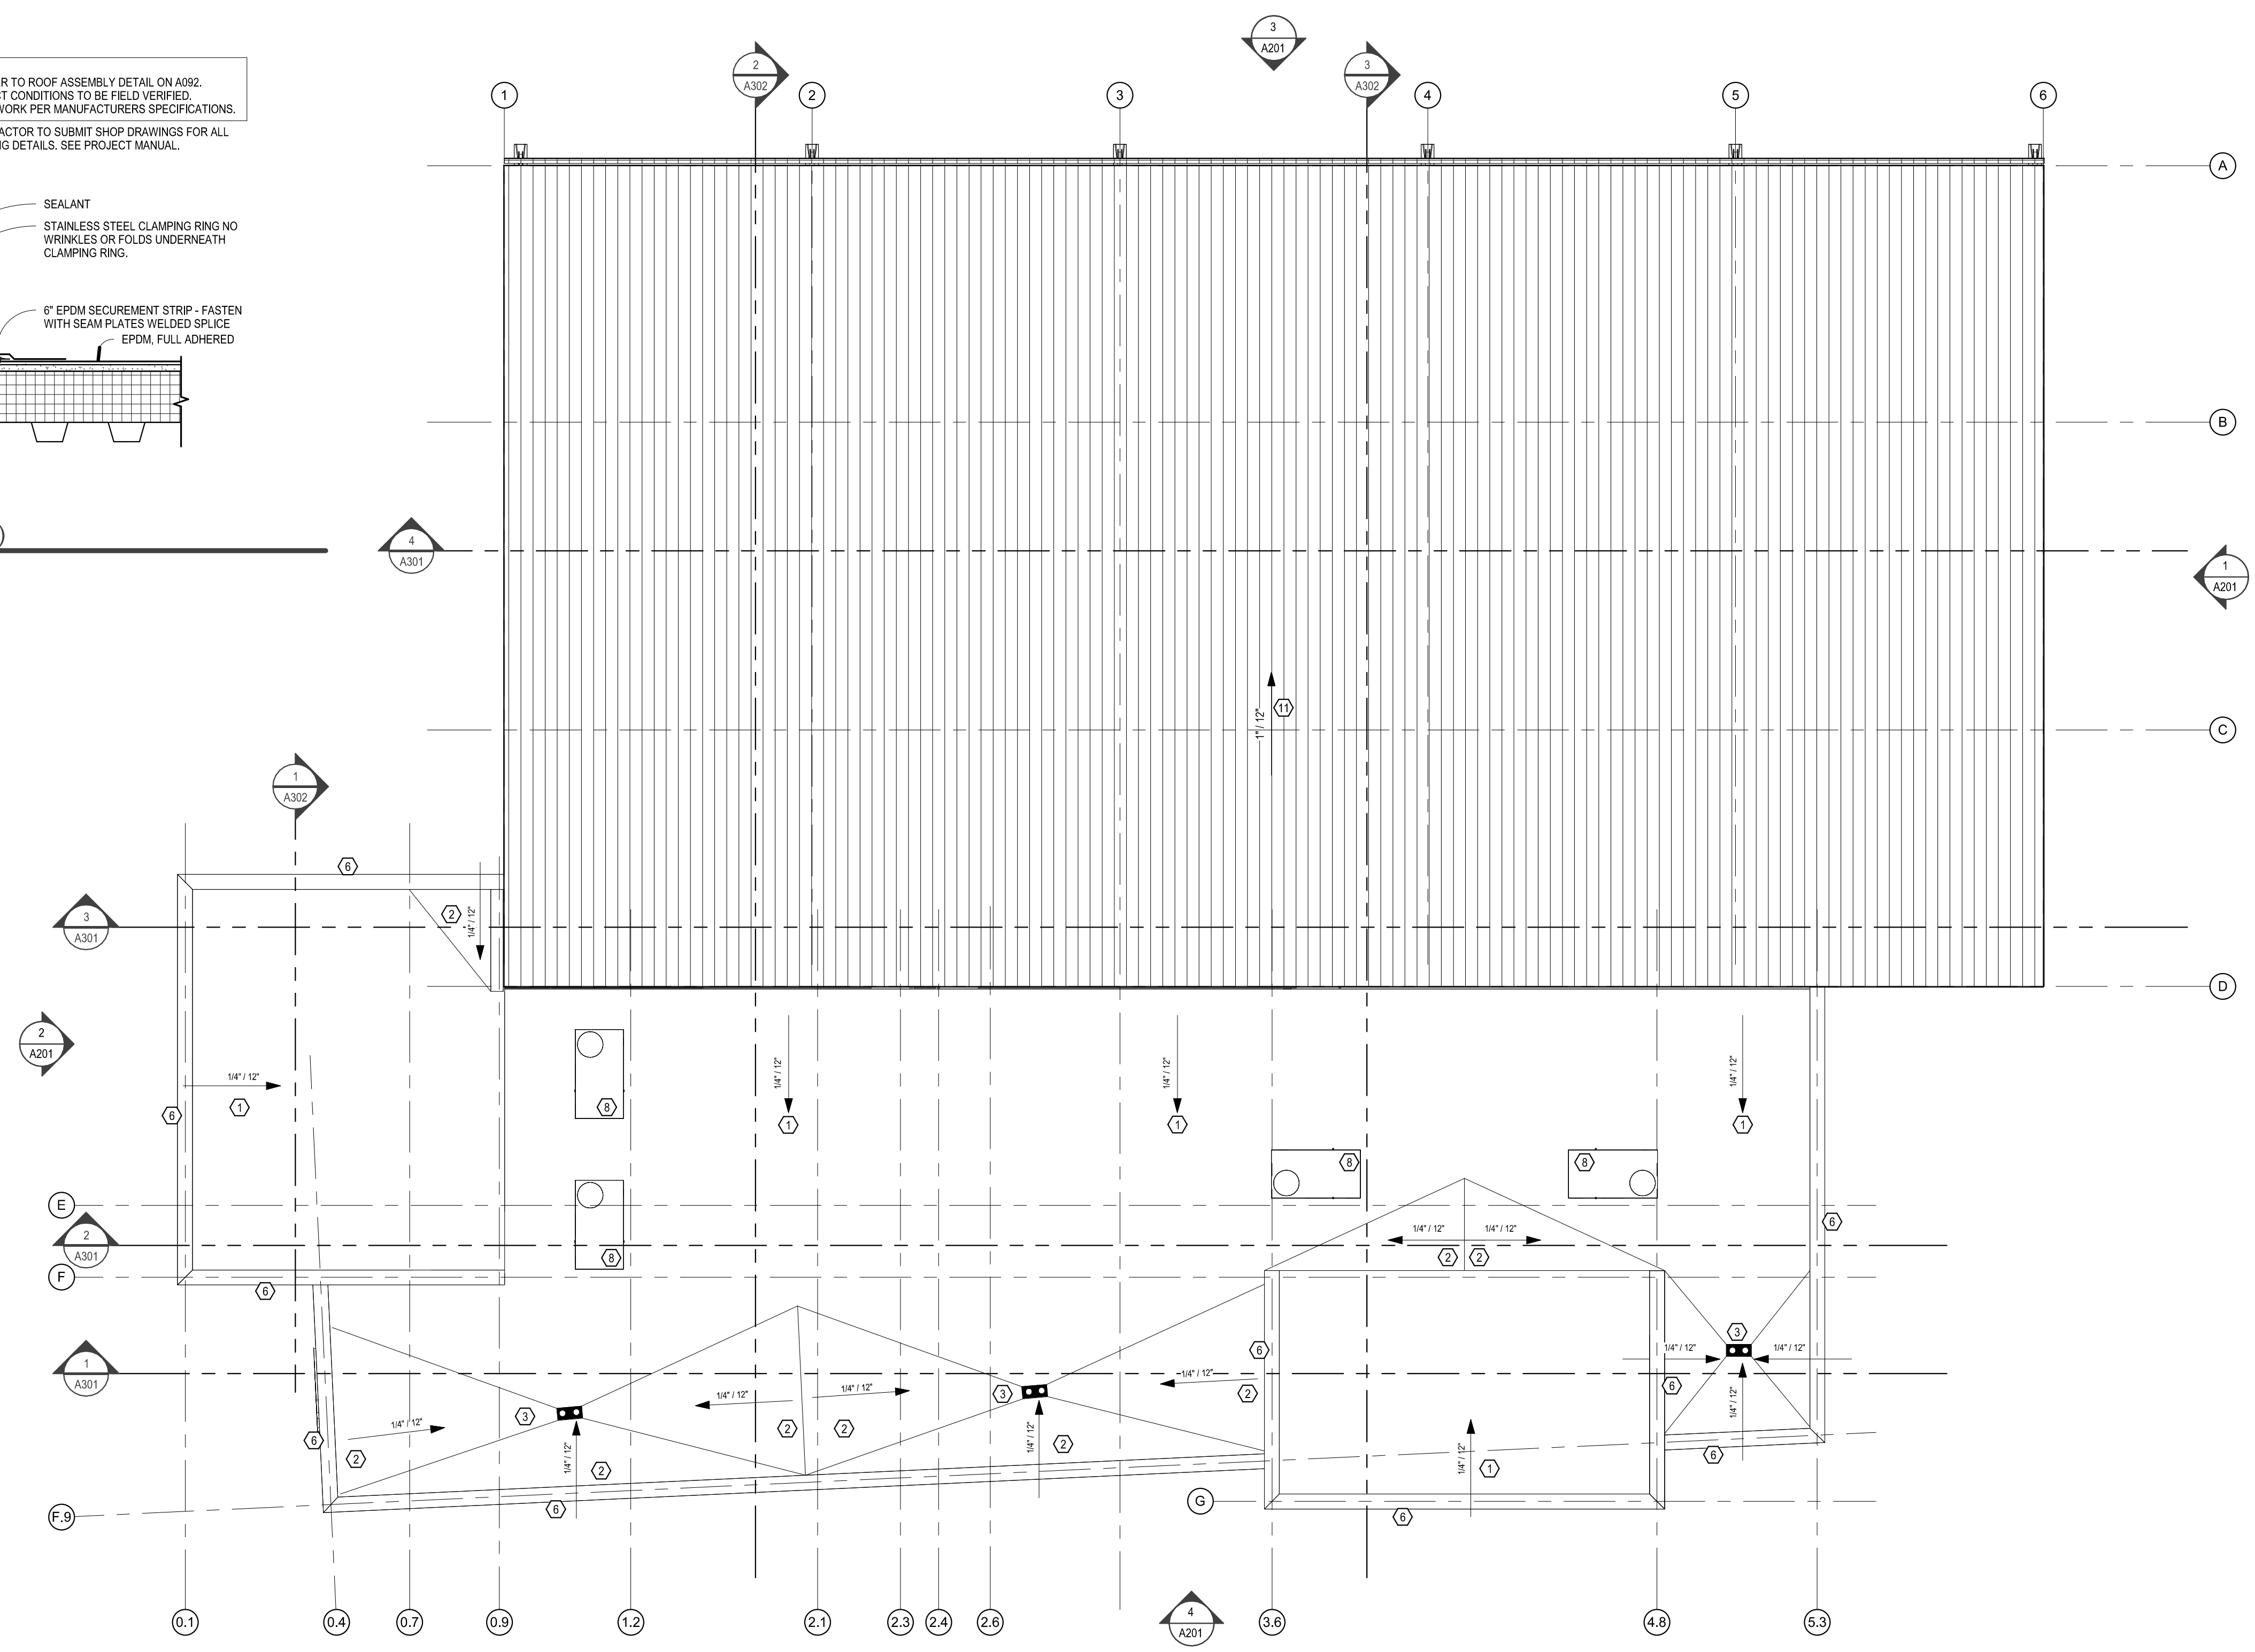

1 A105 Roof Plan
1/8" = 1'-0"

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DRAWING HISTORY

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Roof Plan

SHEET

A105



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GENERAL NOTES - RCP


- CEILING PLANS DO NOT SHOW EVERY FIXTURE OR COMPONENT. REFER TO ELECTRICAL, PLUMBING, MECHANICAL, FIRE PROTECTION, AND STRUCTURAL DRAWINGS FOR EXTENT OF ALL CEILING PENETRATIONS AND INSTALLATIONS AND COORDINATE PRIOR TO INSTALLATION.
- WALLS TO EXTEND TO DECK ABOVE, AS PER WALL TYPE LEGEND ON DRAWING. CUT AROUND STEEL BEAMS AND/OR TRUSSES AS REQUIRED. UTILIZE SLIP TRACK AT HEAD AT ALL STEEL STUD PARTITIONS. (SEE CODE STUDY DRAWINGS FOR LOCATIONS OF RATED WALLS.)
- ALL COMPONENTS MOUNTED IN OR BELOW A SUSPENDED ACOUSTIC CEILING SHALL BE CENTERED IN THE CEILING TILE OR IN THE 2X2 PORTION OF REGULAR CEILING TILES, UNLESS NOTED OTHERWISE. THIS SHALL INCLUDE, BUT NOT BE LIMITED TO, LIGHT FIXTURES, DIFFUSERS, SPEAKERS, SMOKE DETECTORS, AND SPRINKLER HEADS.
- LIGHTS AND GRIDS ARE TYPICALLY CENTERED IN ROOMS, OR BETWEEN SELECT WALLS WITHIN A GIVEN AREA. UNDO COORDINATE EACH AREA WITH ELECTRICAL SHEETS AND FIELD VERIFICATION PRIOR TO INSTALL. LIGHT LOCATIONS GOVERN OVER OTHER MECHANICAL AND ELECTRICAL DEVICES.
- GRID LAYOUT SHOWN FOR DESIGN INTENT ONLY. CONTRACTOR SHALL VERIFY THE FINAL LAYOUT WITH FIELD CONDITIONS AND OBTAIN OWNER AND ARCHITECT APPROVAL OF CHANGES PRIOR TO INSTALLATION.
- ALL CONSTRUCTION SHALL CONFORM TO THE CURRENT INTERNATIONAL BUILDING CODE.
- ALL INTERIOR FINISHES TO COMPLY WITH STATE/LOCAL CODES AND ORDINANCES.
- PRIOR TO THE INSTALLATION OF CEILINGS, ALLOW FOR AN ABOVE-CEILING INSPECTION OF COMPONENTS THAT WILL NOT BE VISIBLE WHEN THE CEILINGS HAVE BEEN INSTALLED, INCLUDING INSPECTION OF FIRE, SMOKE, AND ACOUSTICAL SEPARATIONS.
- COORDINATE EXIT LIGHT LOCATIONS. ELECTRICAL CONTRACTOR IS RESPONSIBLE FOR CORRECT PLACEMENT OF ALL REQUIRED EXIT LIGHTS AND MEANS OF EGRESS LIGHTING.
- ALL CONDUIT SHALL BE BURIED IN WALLS WHERE POSSIBLE. EXPOSED ELECTRICAL CONDUIT SHALL BE INSTALLED IN A NEAT AND ORDERLY FASHION. EXPOSED CONDUIT SHALL BE PAINTED TO MATCH ADJACENT FINISHES.
- PROVIDE HOLD DOWN CLIPS AT SUSPENDED CEILING ASSEMBLIES AT EXTERIOR DOORS AS RECOMMENDED BY CEILING MANUFACTURER.
- AT METAL ACOUSTICAL DECK LOCATIONS, WEDGE HANGERS TO BE USED FOR ALL ROOF OR FLOOR HUNG ITEMS. (SUSPENDED CEILINGS, PIPES, DUCTS, ELECTRICAL, PLUMBING, ECT.) SEE A097 FOR ASSEMBLIES.

KEYNOTES - RCP


- ① LINER PANEL CEILING
- ② GYPSUM BOARD BULKHEAD.
- ③ SUSPENDED WOOD CEILING
- ④ EXPOSED ROOF TRUSSES, ELECTRICAL CONDUIT, AND MECHANICAL SYSTEMS. PAINT ALL SURFACES ABOVE BOTTOM CHORD OF TRUSSES PT-5.
- ⑤ EXTERIOR SOFFIT / OVERHANG. SEE EXTERIOR ELEVATIONS FOR FINISHES.

REFLECTED CEILING PLAN LEGEND


- GARAGE LIGHTING
- ▭ LINEAR HANGING SHOP LIGHT
- ⊗ 2X4 PARABOLIC LIGHT
- ⊗ 2X2 PARABOLIC LIGHT
- PENDANT LIGHT
- HANGING STRIP LIGHT
- RECESSED CAN LIGHT
- SURFACE MOUNTED LIGHT
- ⊗ SUPPLY DIFFUSER
- ⊗ RETURN DIFFUSER

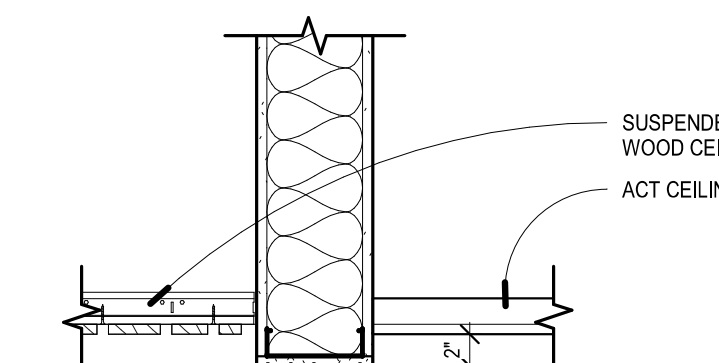

2 A111 Ceiling Transition Wood To ACT
1" = 1'-0"

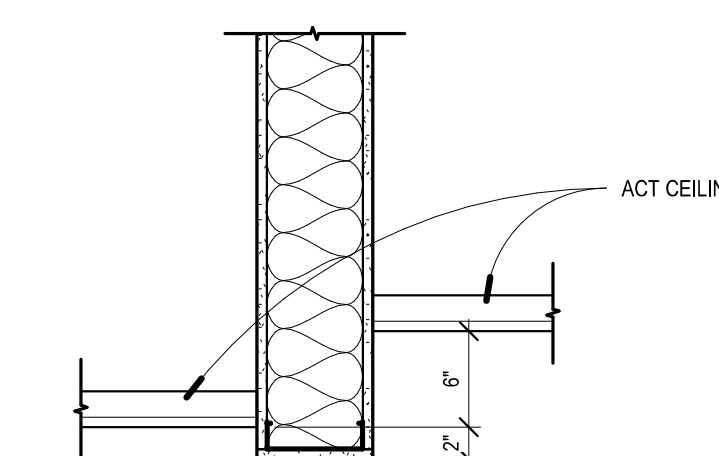

3 A111 Ceiling Transition ACT To ACT
1" = 1'-0"

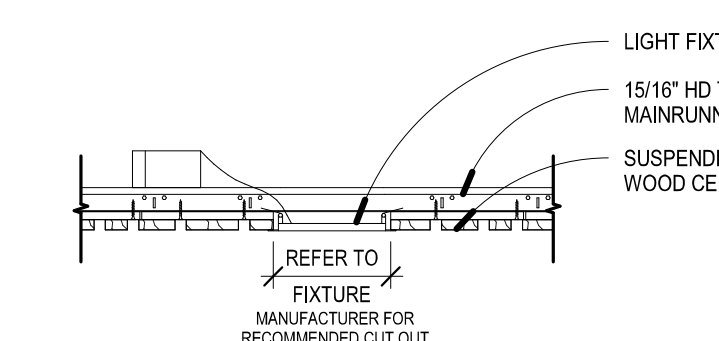

4 A111 Can Light @ Wood Slat
1" = 1'-0"



DRAWING HISTORY


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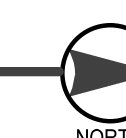
First Floor Reflected Ceiling Plan


SHEET

A111




1 A111 Reflected Ceiling Plan
1/8" = 1'-0"

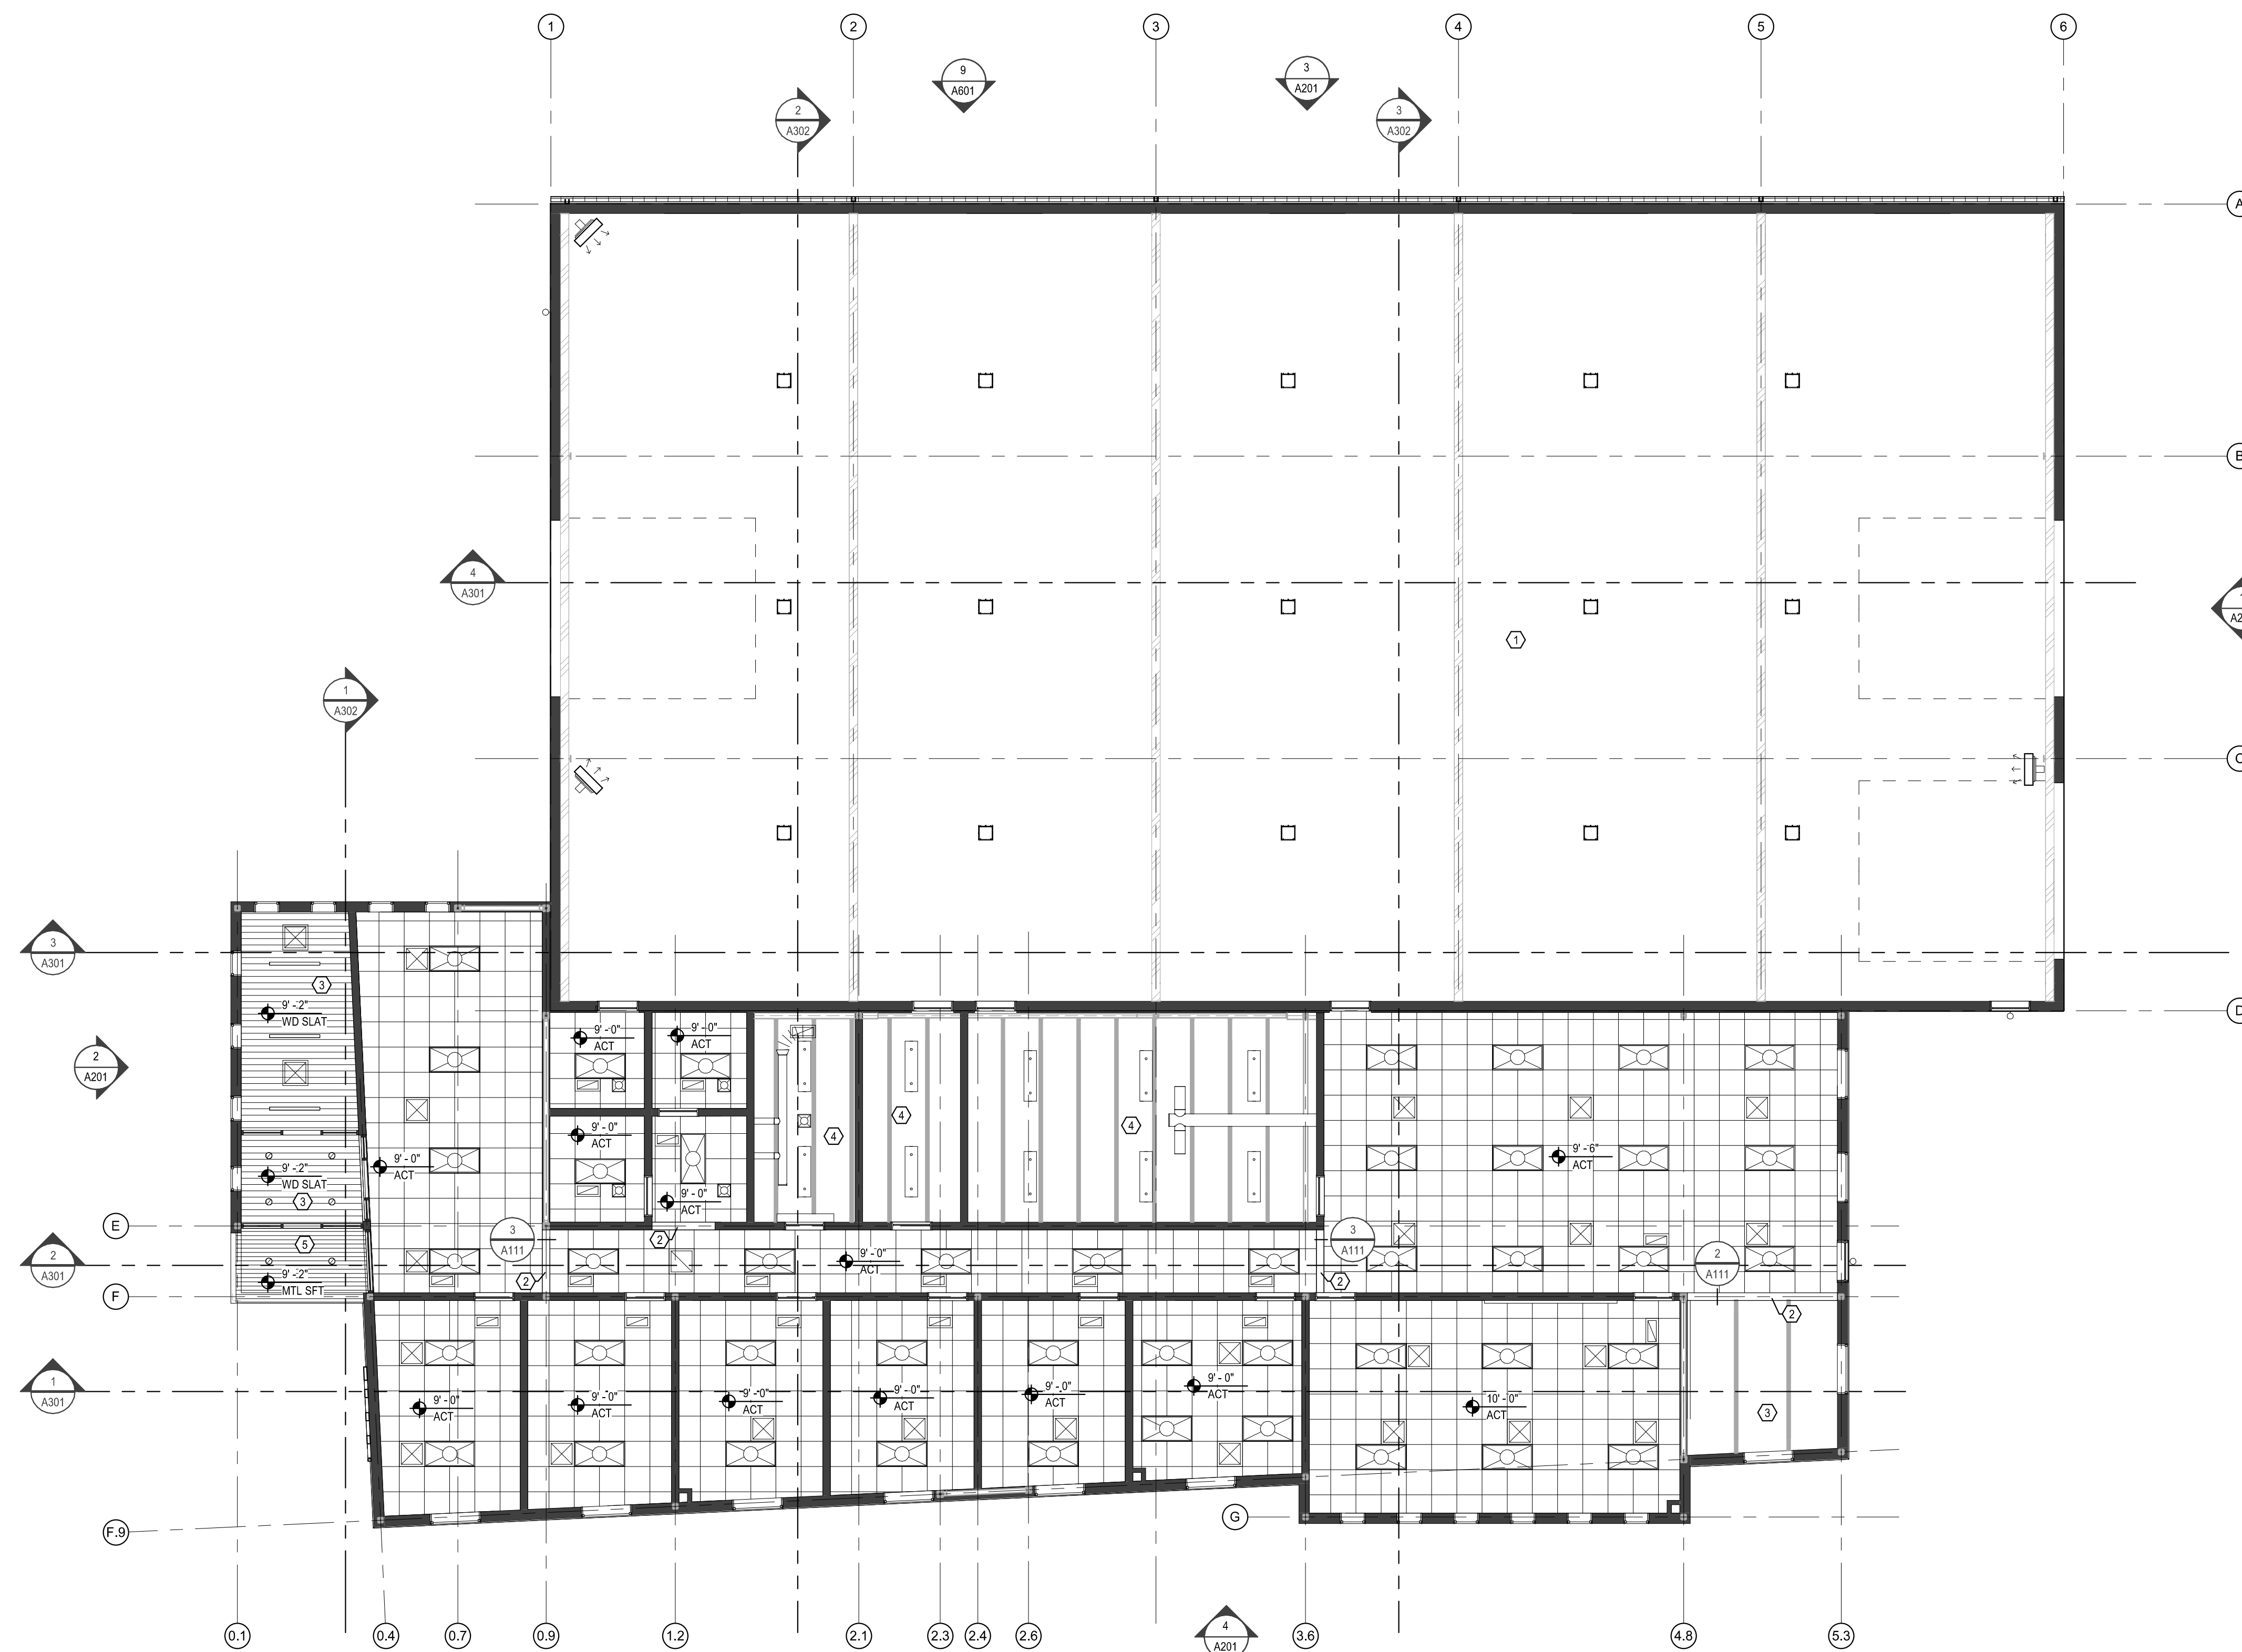


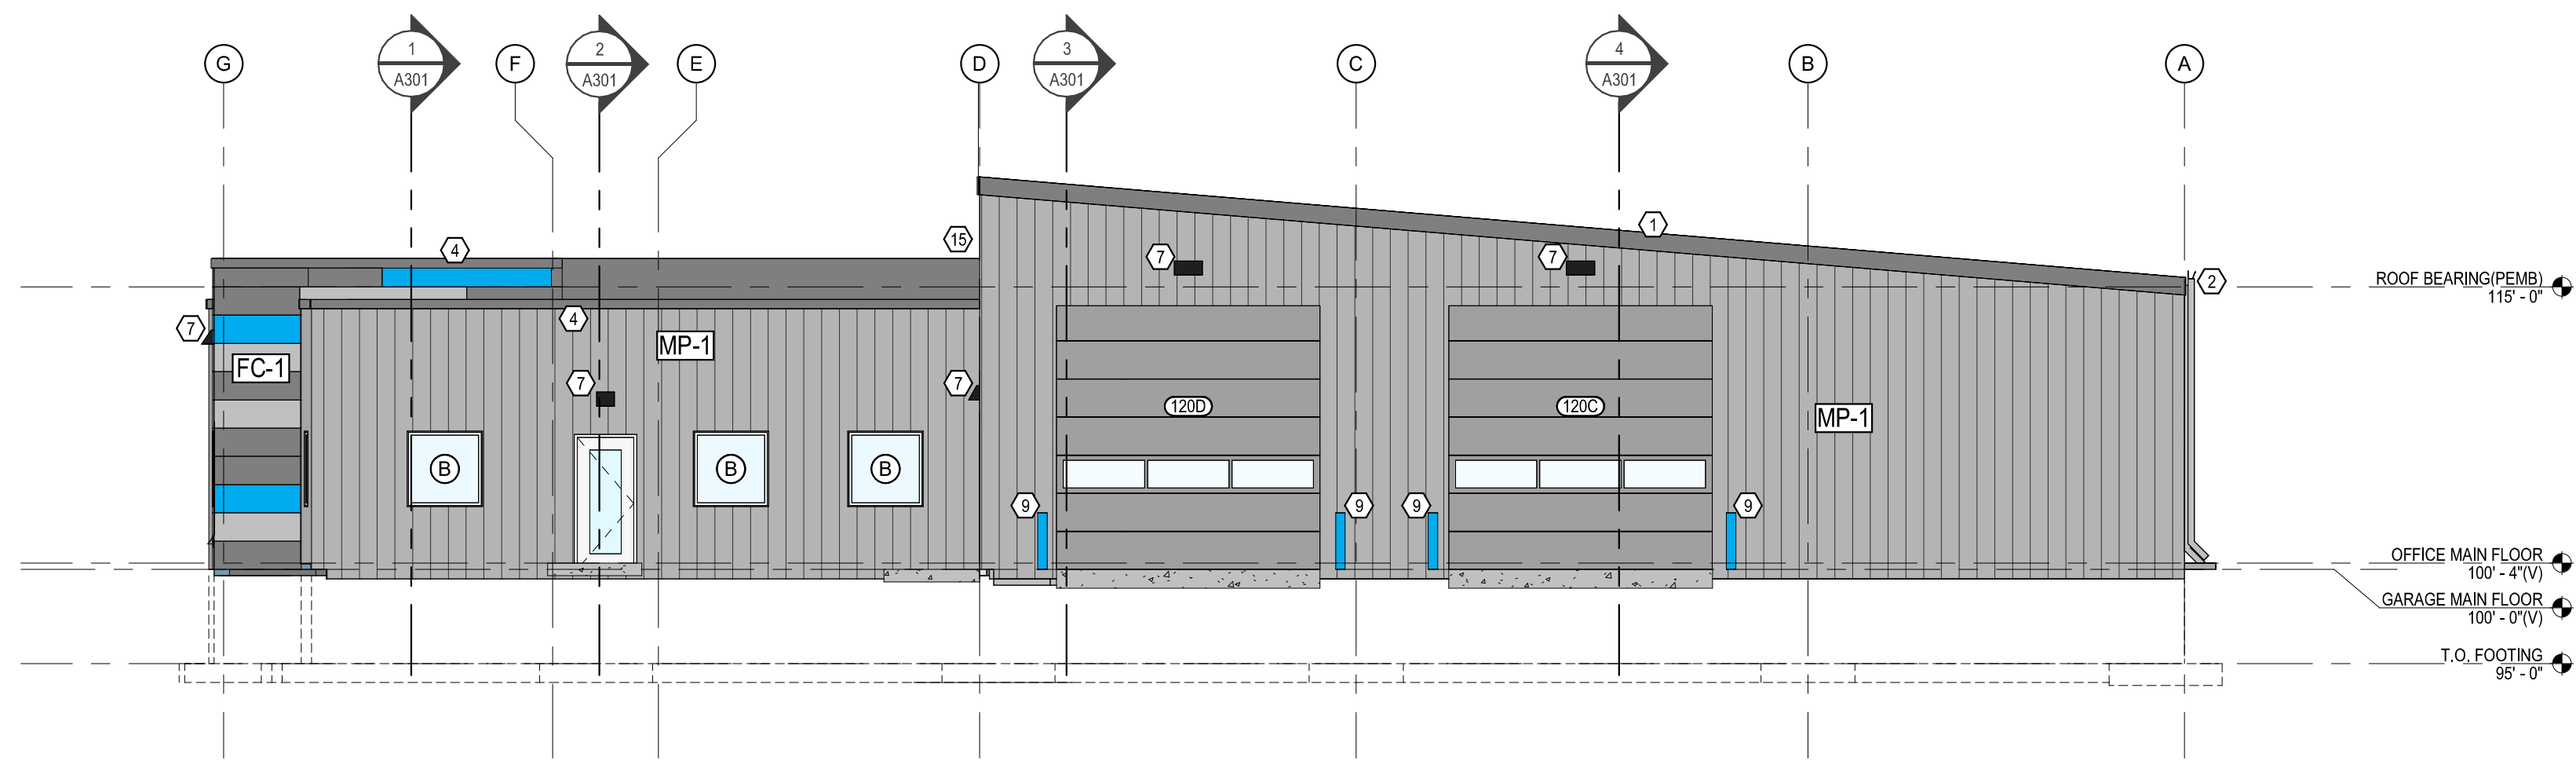


1 A201 North Elevation
1/8" = 1'-0"

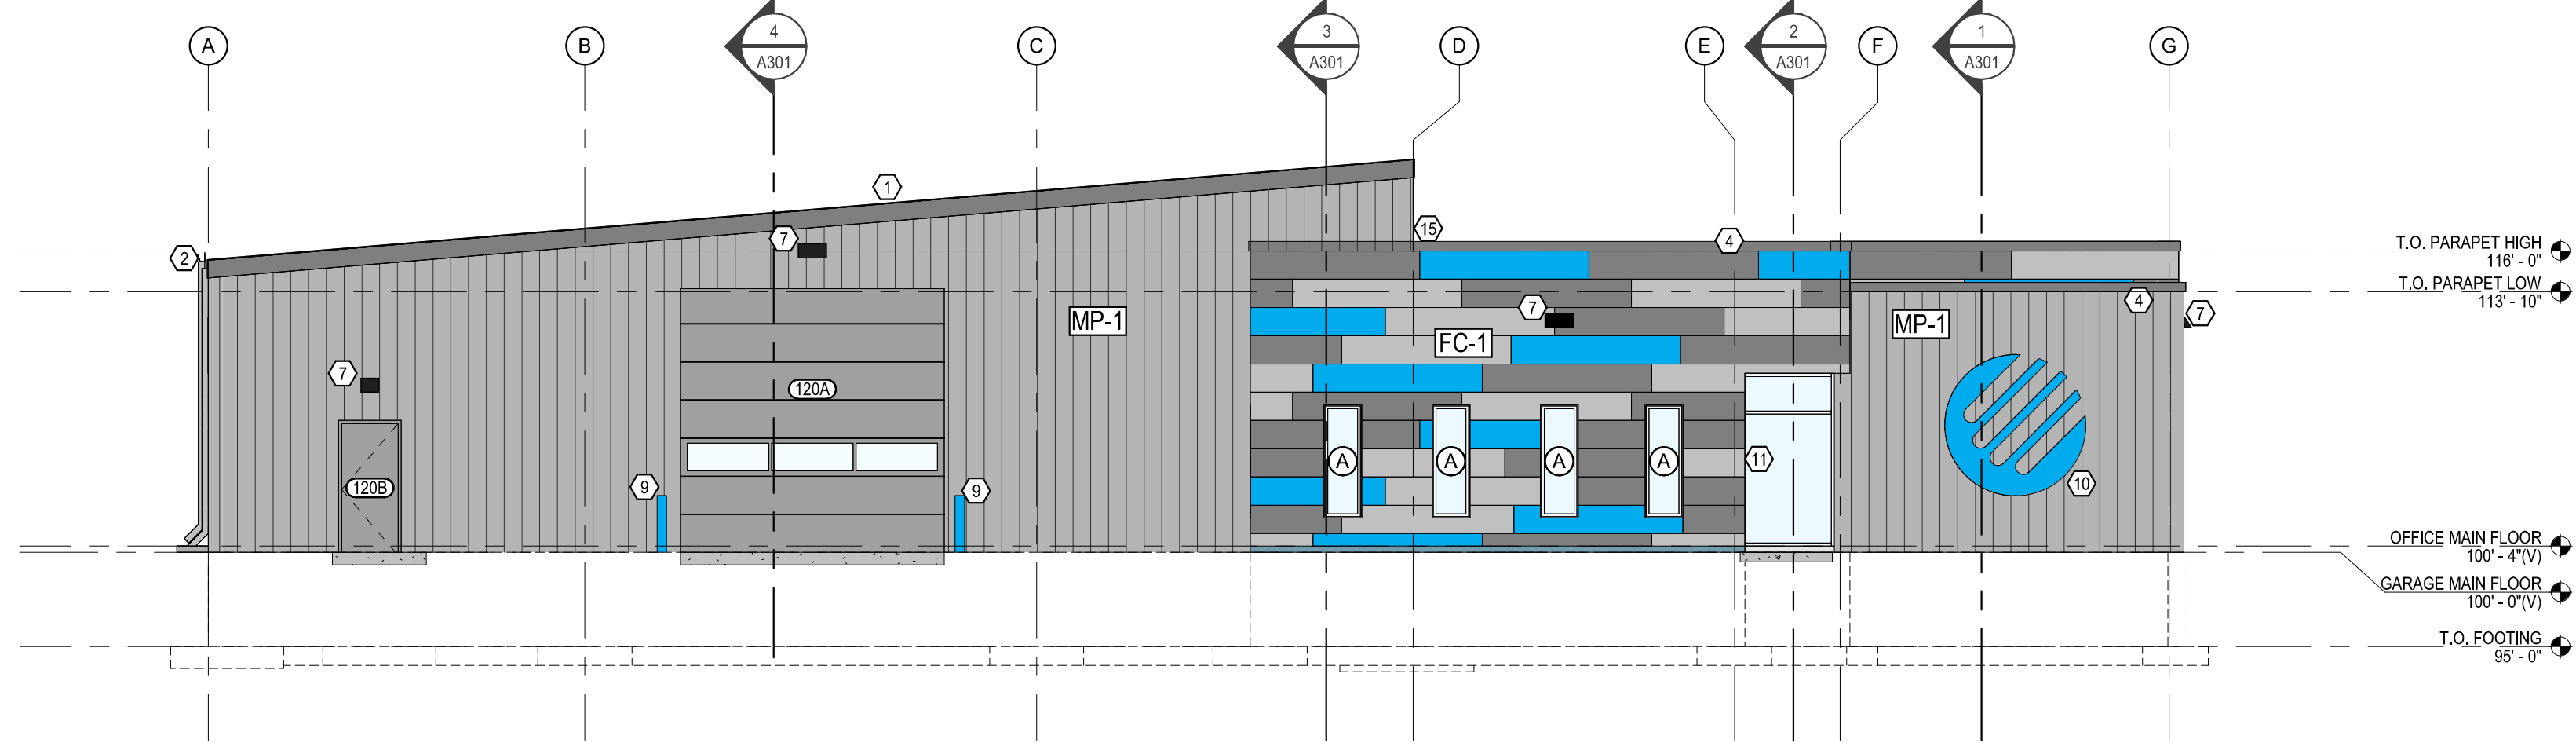

2 A201 South Elevation
1/8" = 1'-0"

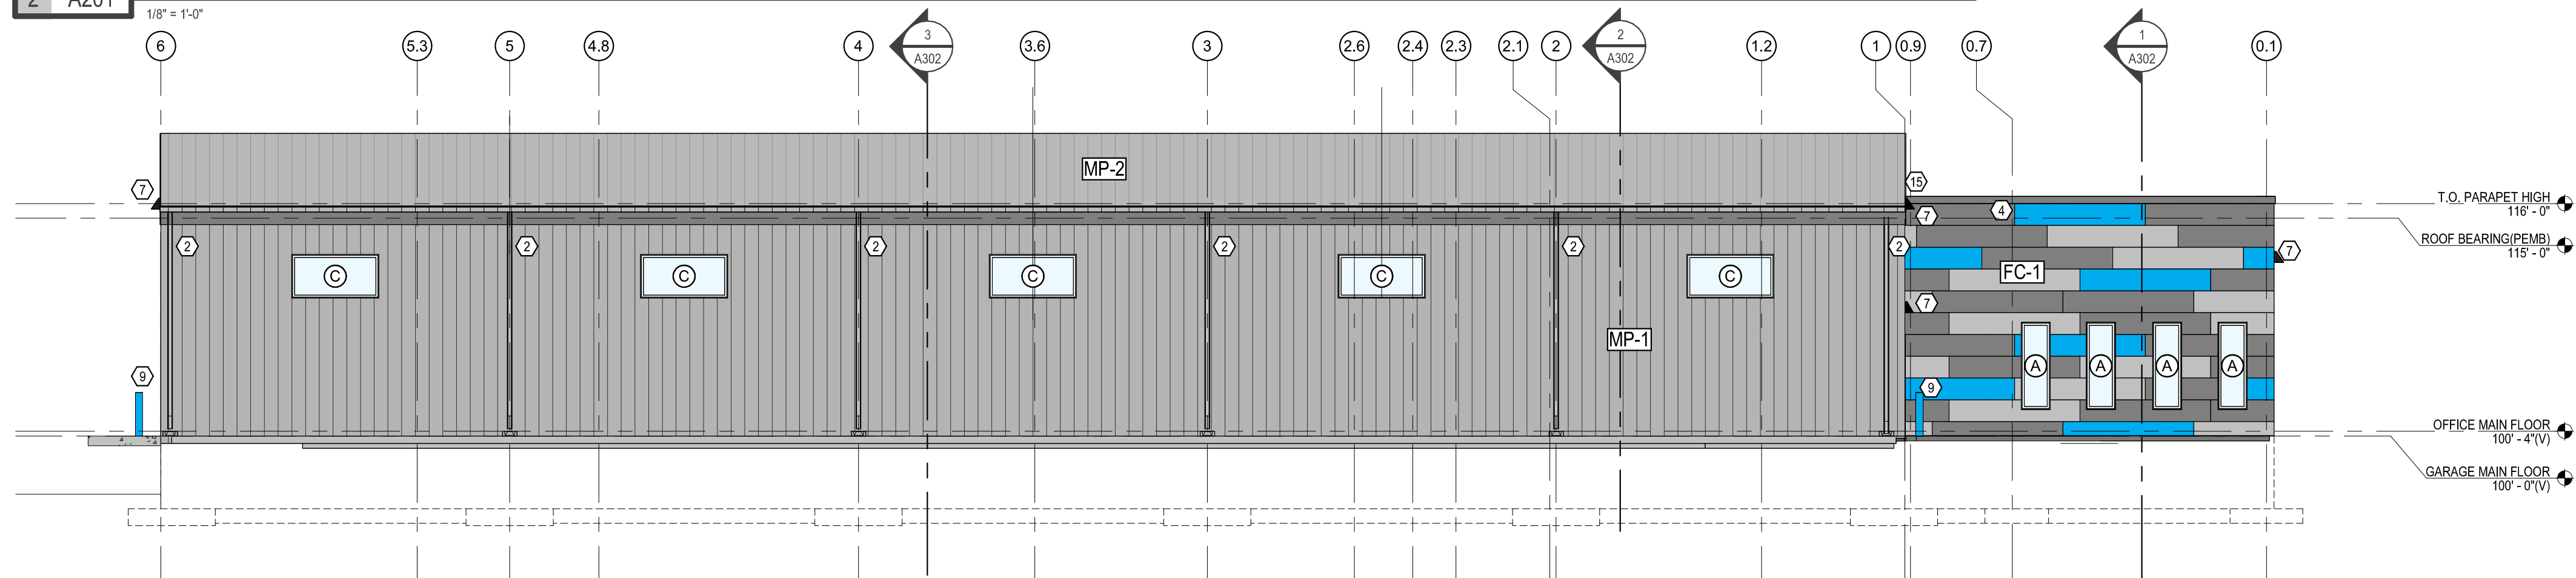

3 A201 West Elevation
1/8" = 1'-0"

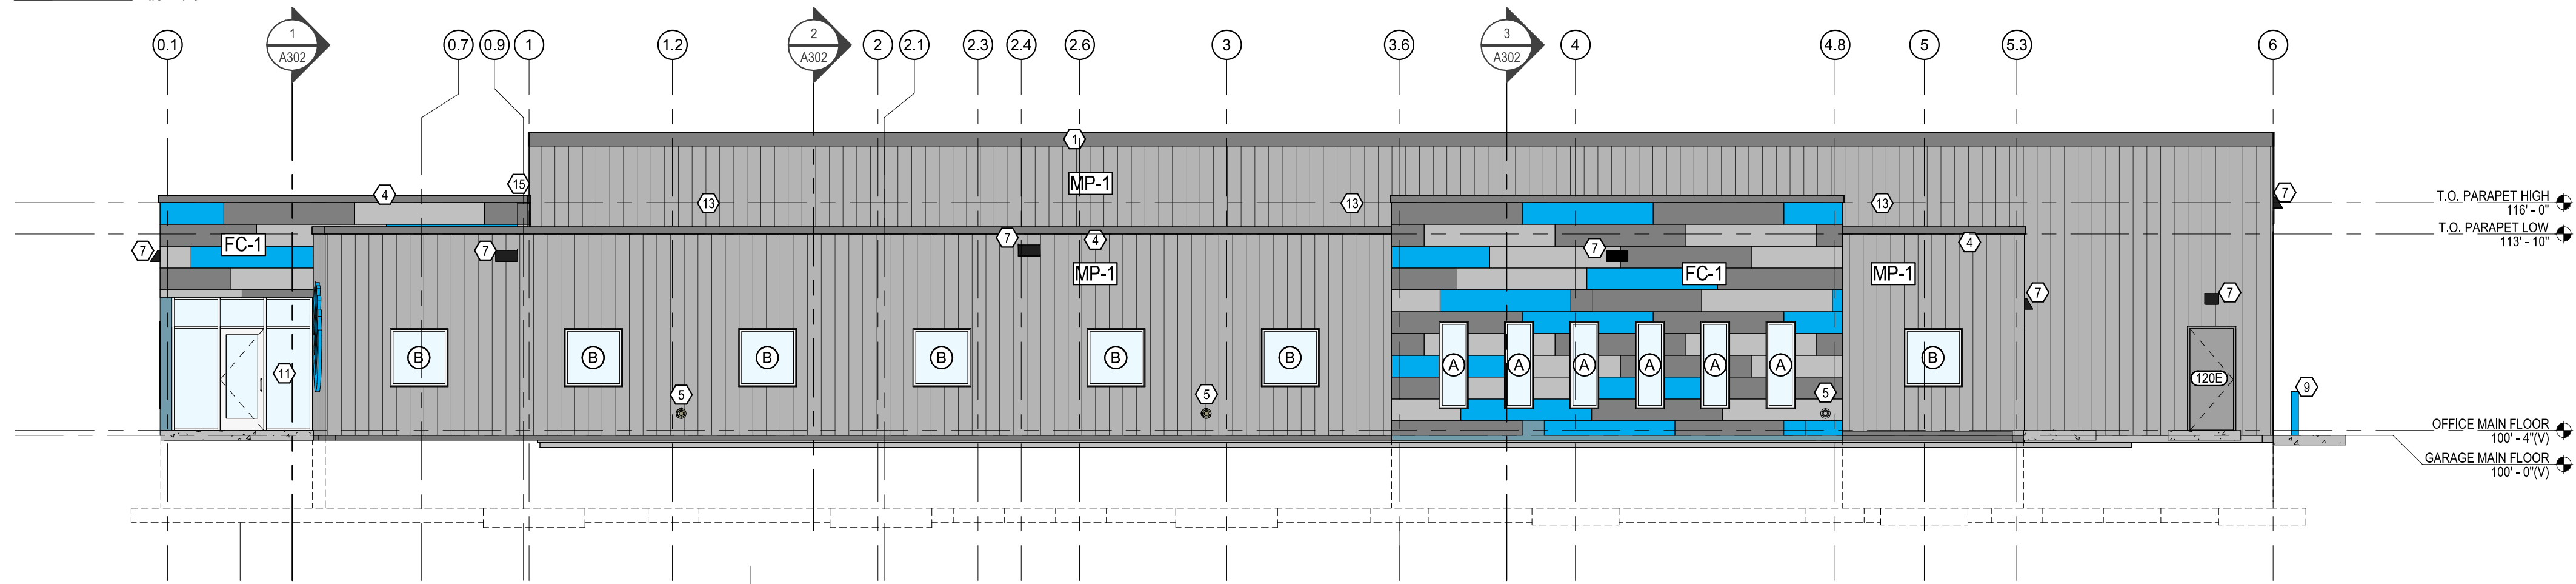

4 A201 East Elevation
1/8" = 1'-0"

GENERAL NOTES - EXTERIOR ELEVATIONS

- REVIEW EXTERIOR WALL TYPES AND DETAILS FOR ALL EXTERIOR WALL COMPONENTS.
- REVIEW SPECIFICATIONS FOR PRODUCT AND INSTALLATION REQUIREMENTS, AND FOR POTENTIAL ASSEMBLY MOCK-UPS.
- SEE WINDOW TYPES AND OPENING DETAILS ON THE A600 DRAWINGS.
- ARCHITECTURAL / STRUCTURAL ELEVATION 100' - 0" EQUALS ELEVATION ON CIVIL DRAWINGS.

KEYNOTES - EXTERIOR ELEVATIONS

- ① METAL ROOF FASCIA, BY PEMB SUPPLIER, COLOR TBD.
- ② GUTTERS/DOWNSPOUTS, COLOR TBD.
- ③ VENT, SEE MECHANICAL.
- ④ METAL ROOF COPING, TYPICAL AT ALL PARAPETS COLOR TBD.
- ⑤ RAIN LEADER DISCHARGE PIPING, 16" ABOVE GRADE, COORDINATE WITH MECHANICAL.
- ⑥ LOUVER, SEE MECHANICAL.
- ⑦ BUILDING MOUNTED LIGHTING, SEE ELECTRICAL.
- ⑧ NOT USED.
- ⑨ BOLLARDS, SEE DETAILS.
- ⑩ BACKLIT BUILDING SIGNAGE, PROVIDE BLOCKING AS NEEDED, SEE SPEC & DETAILS.
- ⑪ ADA PUSH BUTTON.
- ⑫ WALL HYDRANT, SEE MECHANICAL.
- ⑬ EQUIPMENT, SEE MECHANICAL.
- ⑭ NOT USED.
- ⑮ 2' EXPANSION JOINT BETWEEN PEMB SHOP PORTION AND REMAINDER OF BUILDING, SEE DETAIL 24/A540.

EXTERIOR MATERIAL LEGEND

- AL-1** ALUMINUM FRAMES ON STOREFRONT: CLEAR ANODIZED
- MP-1** BASIS OF DESIGN, AVP PANEL BY STAR BUILDING SYSTEMS, VERTICAL INSTALLATION COLOR "TUNDRA"
- FC-1** BASIS OF DESIGN, ILLUMINATION FIBER CEMENT PANELS BY NICHHA, STAGGERED HORIZONTAL INSTALLATION 9'-0" X 1'-6" COLOR SELECTION OF (3) DIFFERENT PAINT COLORS
- MP-2** METAL ROOFING PANEL, COLOR: TBD PVDF PAINT FINISH, PROFILE: CRF DOUBLELOCK STANDING SEAM ROOF SYSTEM, MECHANICALLY SEALED 360, PANEL WIDTH: 24", GAUGE: 24 GA.



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Exterior Elevations

SHEET

A201



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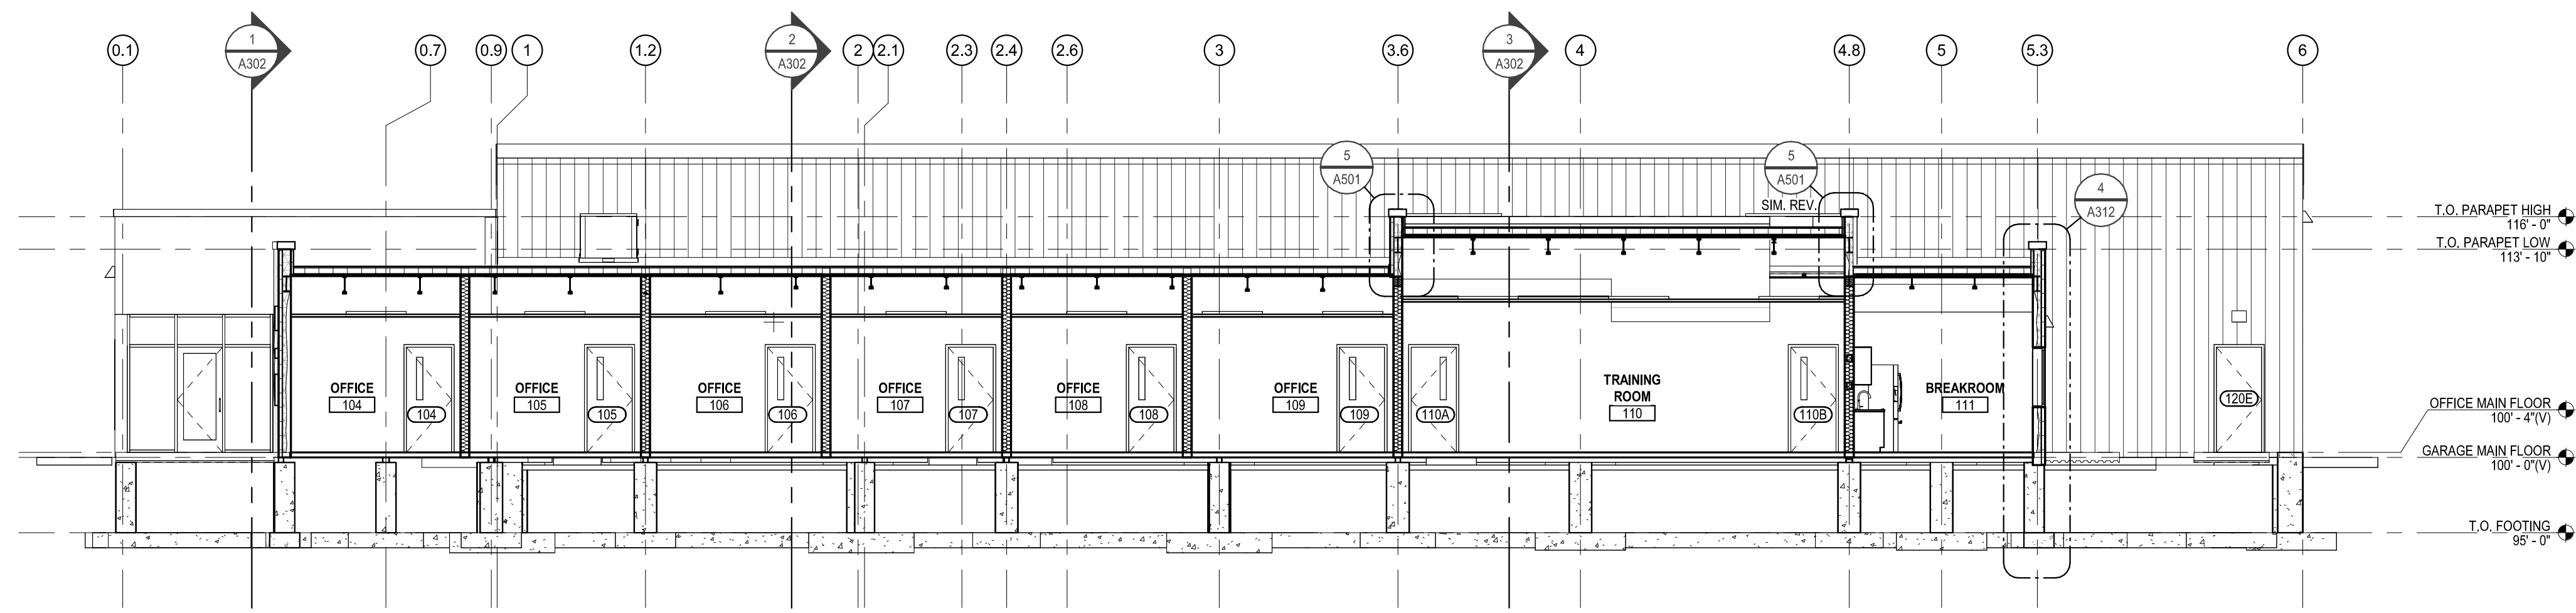
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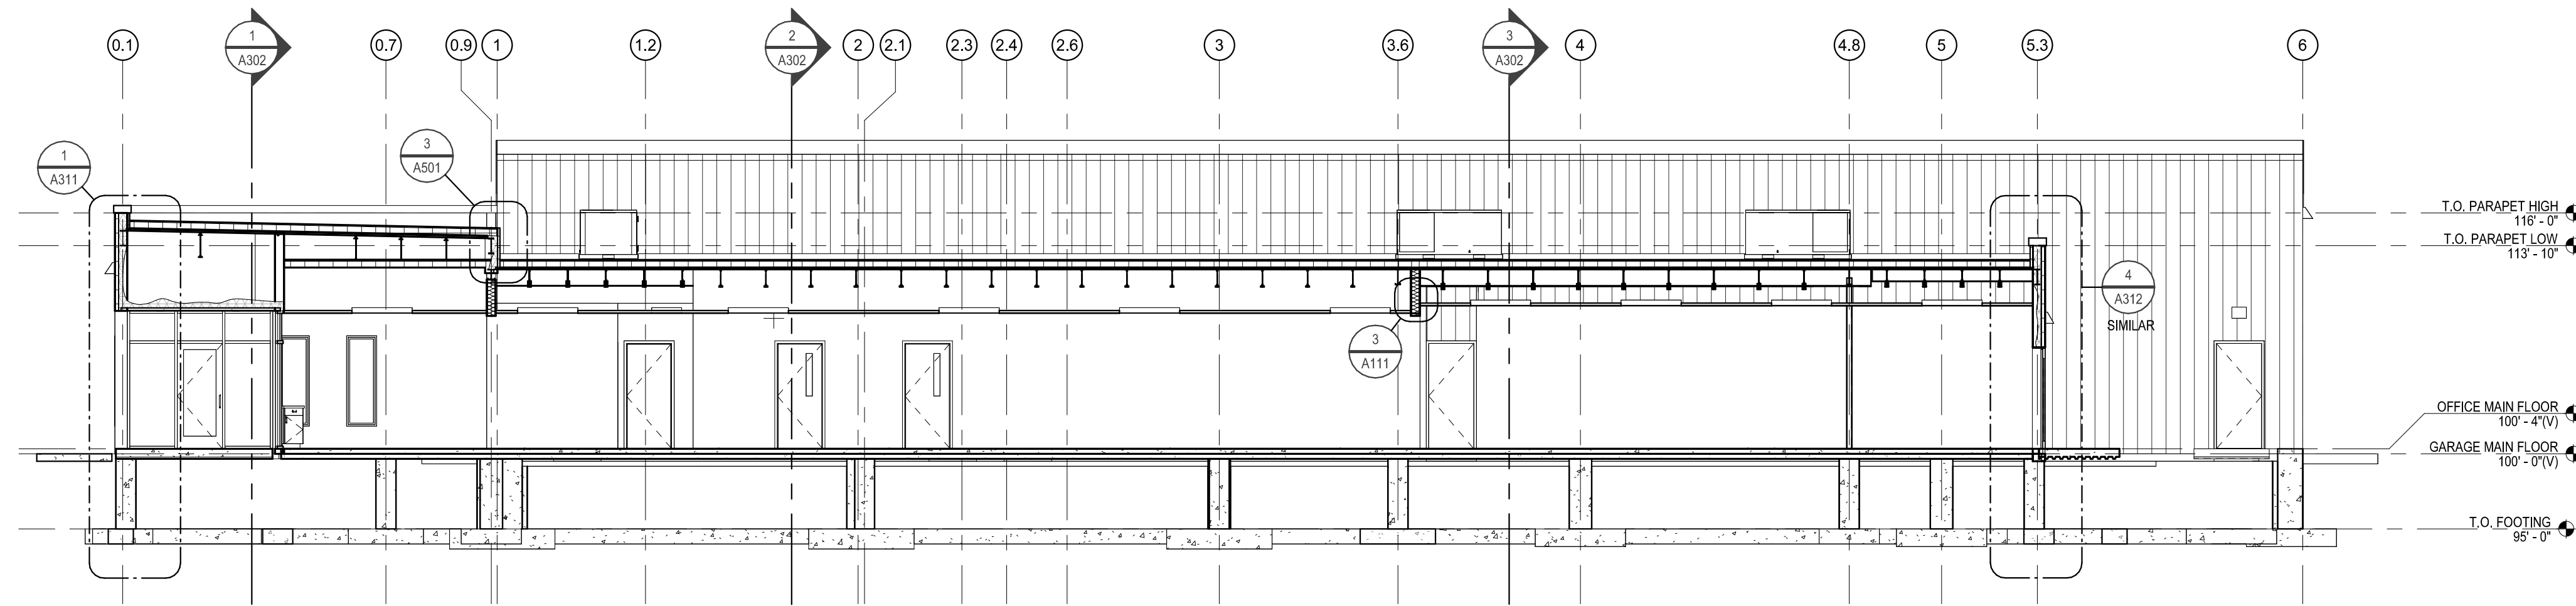
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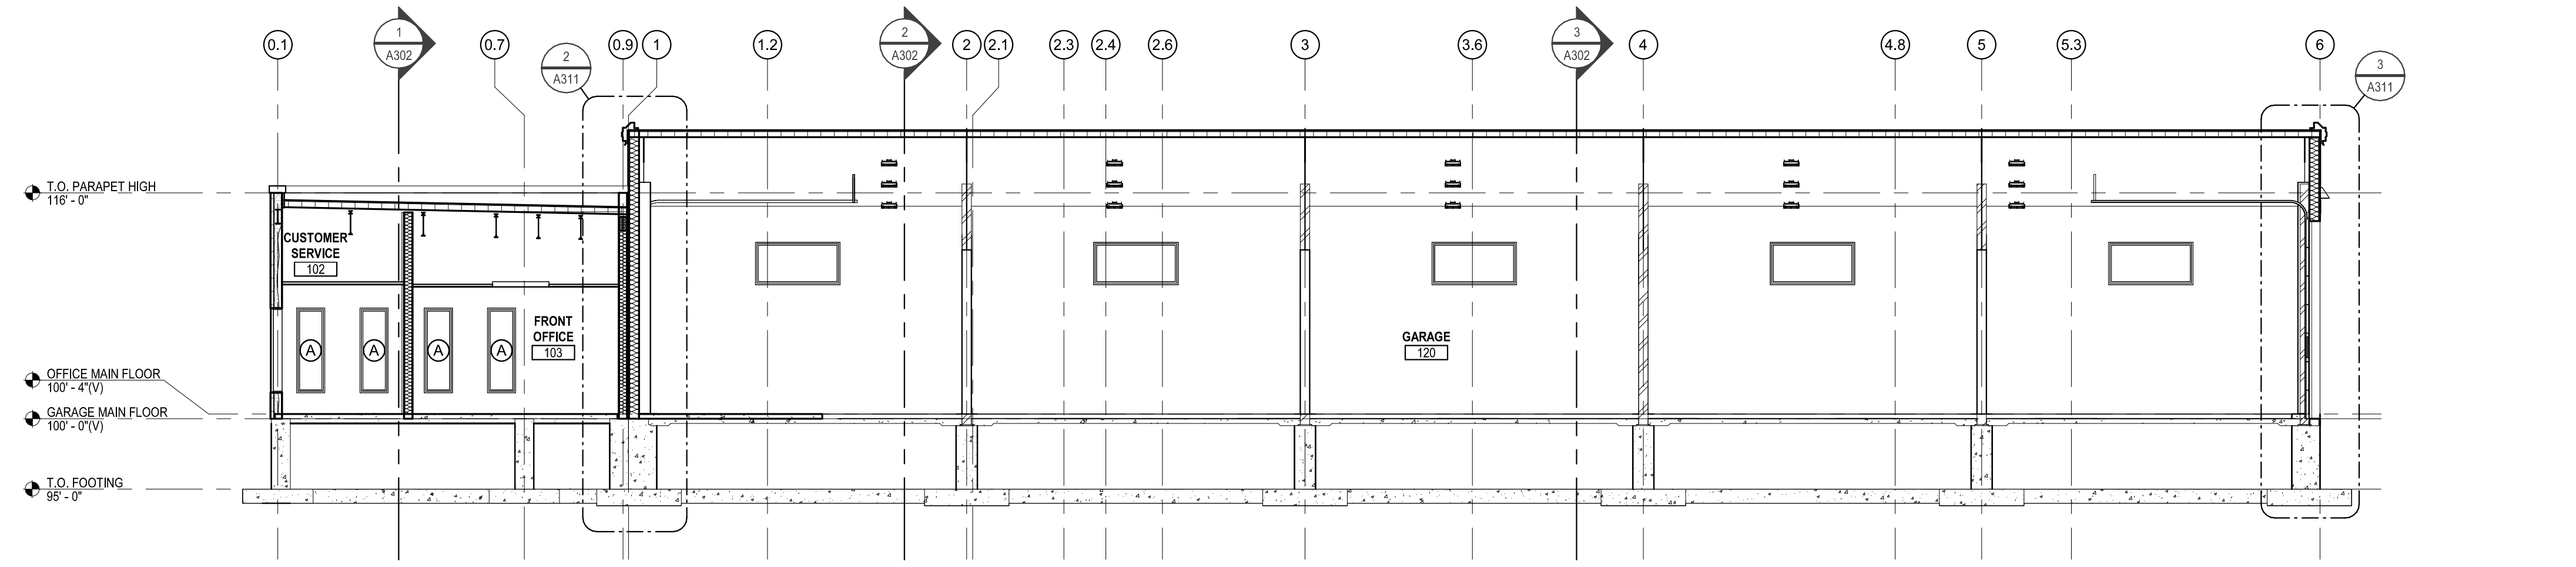
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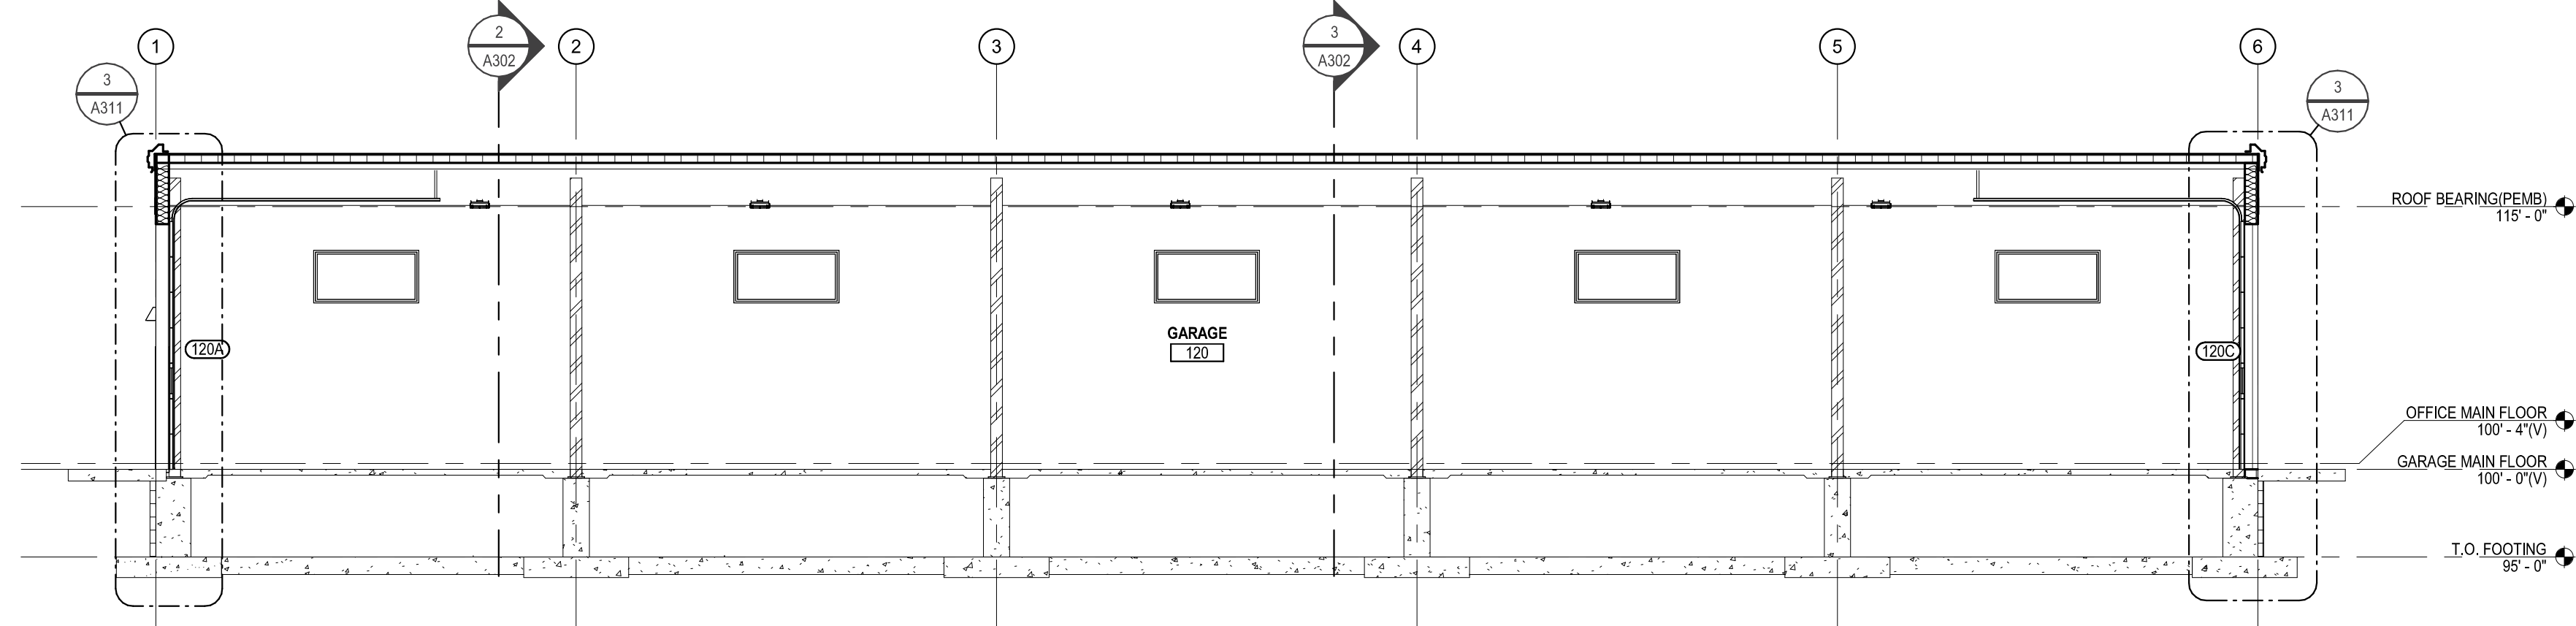
1 A301 Building Section 1
1/8" = 1'-0"



2 A301 Building Section 2
1/8" = 1'-0"



3 A301 Building Section 3
1/8" = 1'-0"



4 A301 Building Section 4
1/8" = 1'-0"



DRAWING HISTORY

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Building Sections

SHEET

A301



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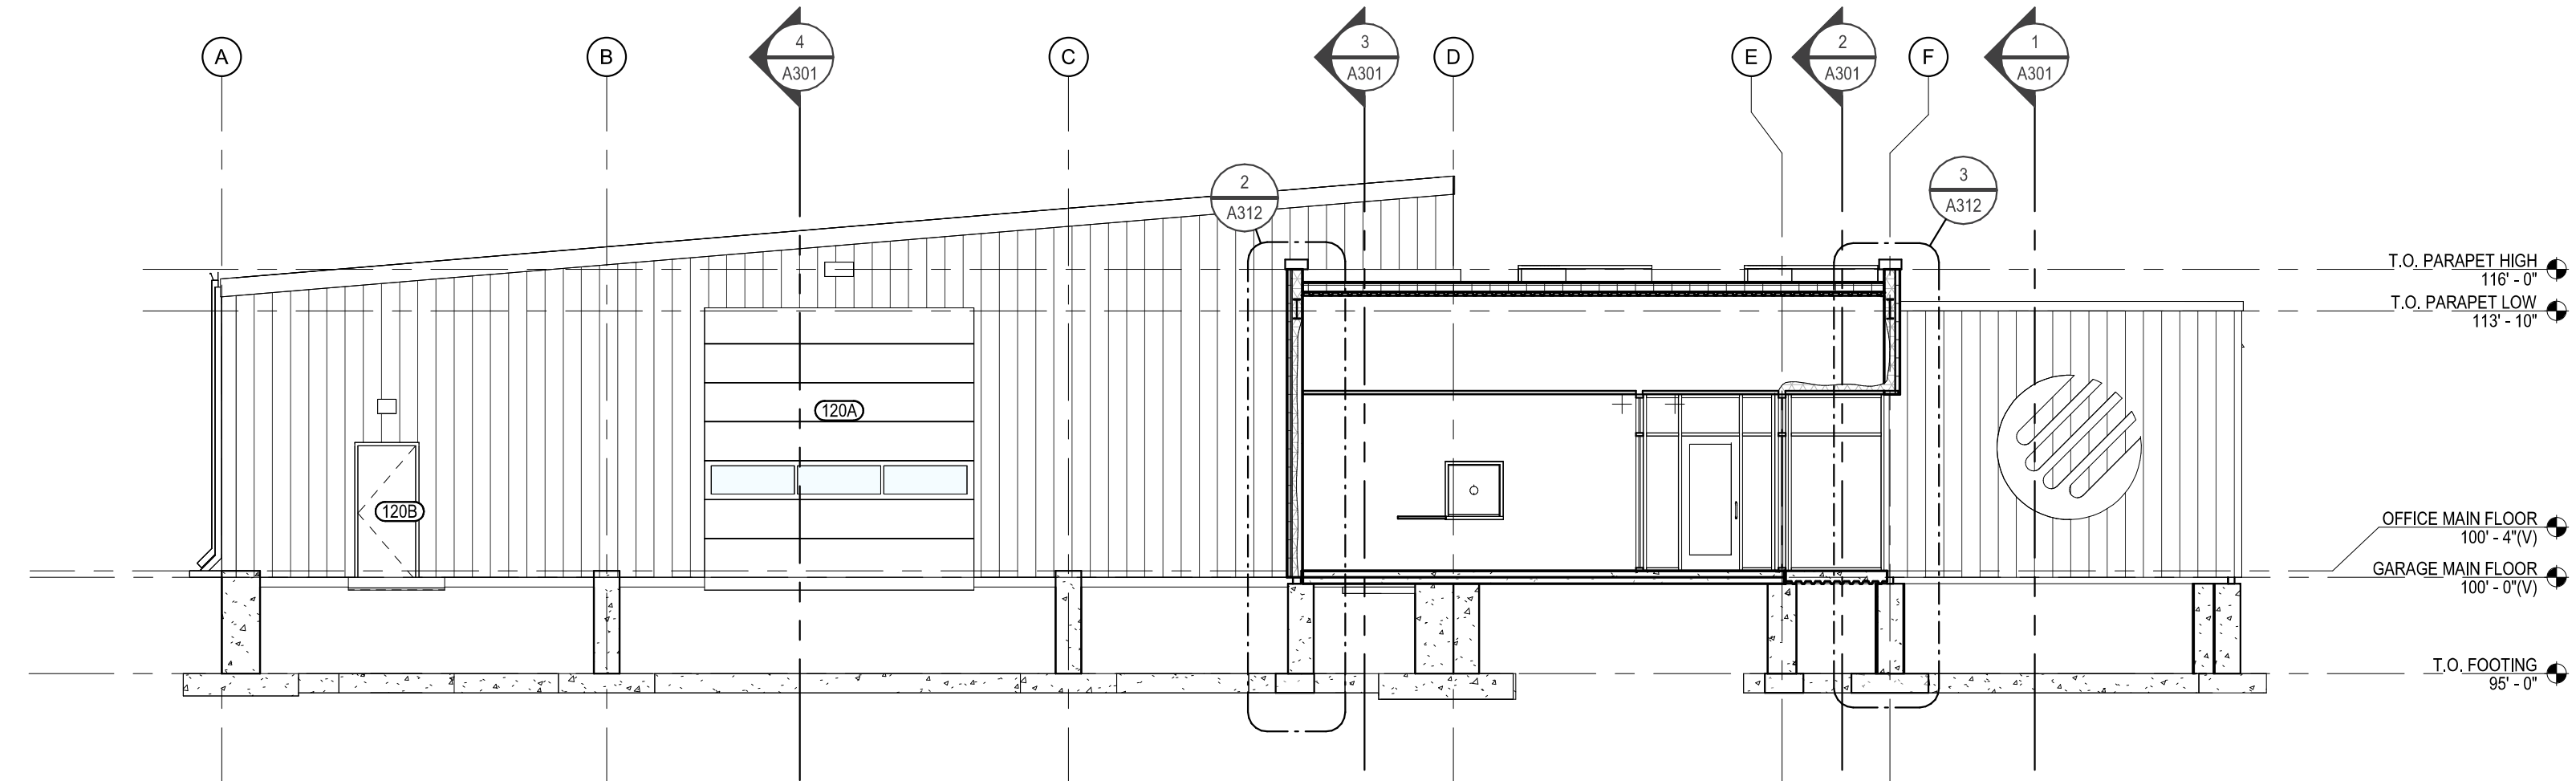
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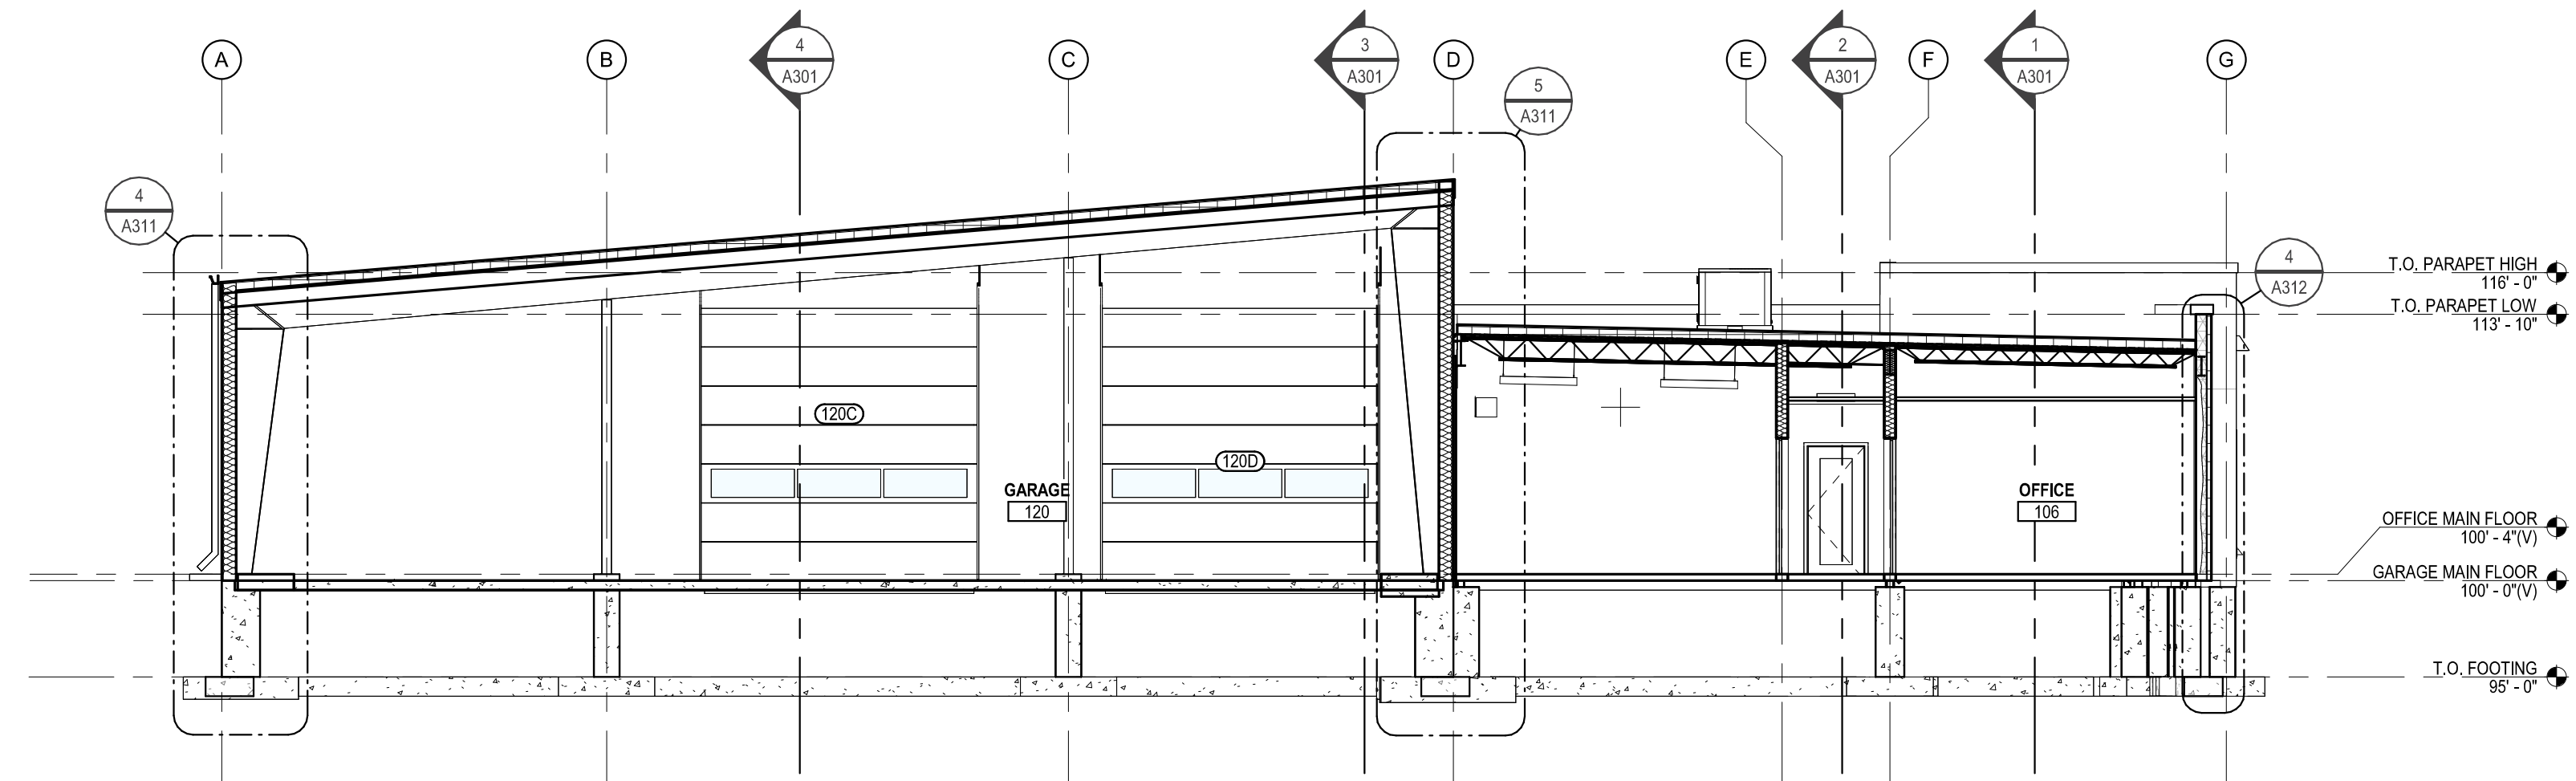
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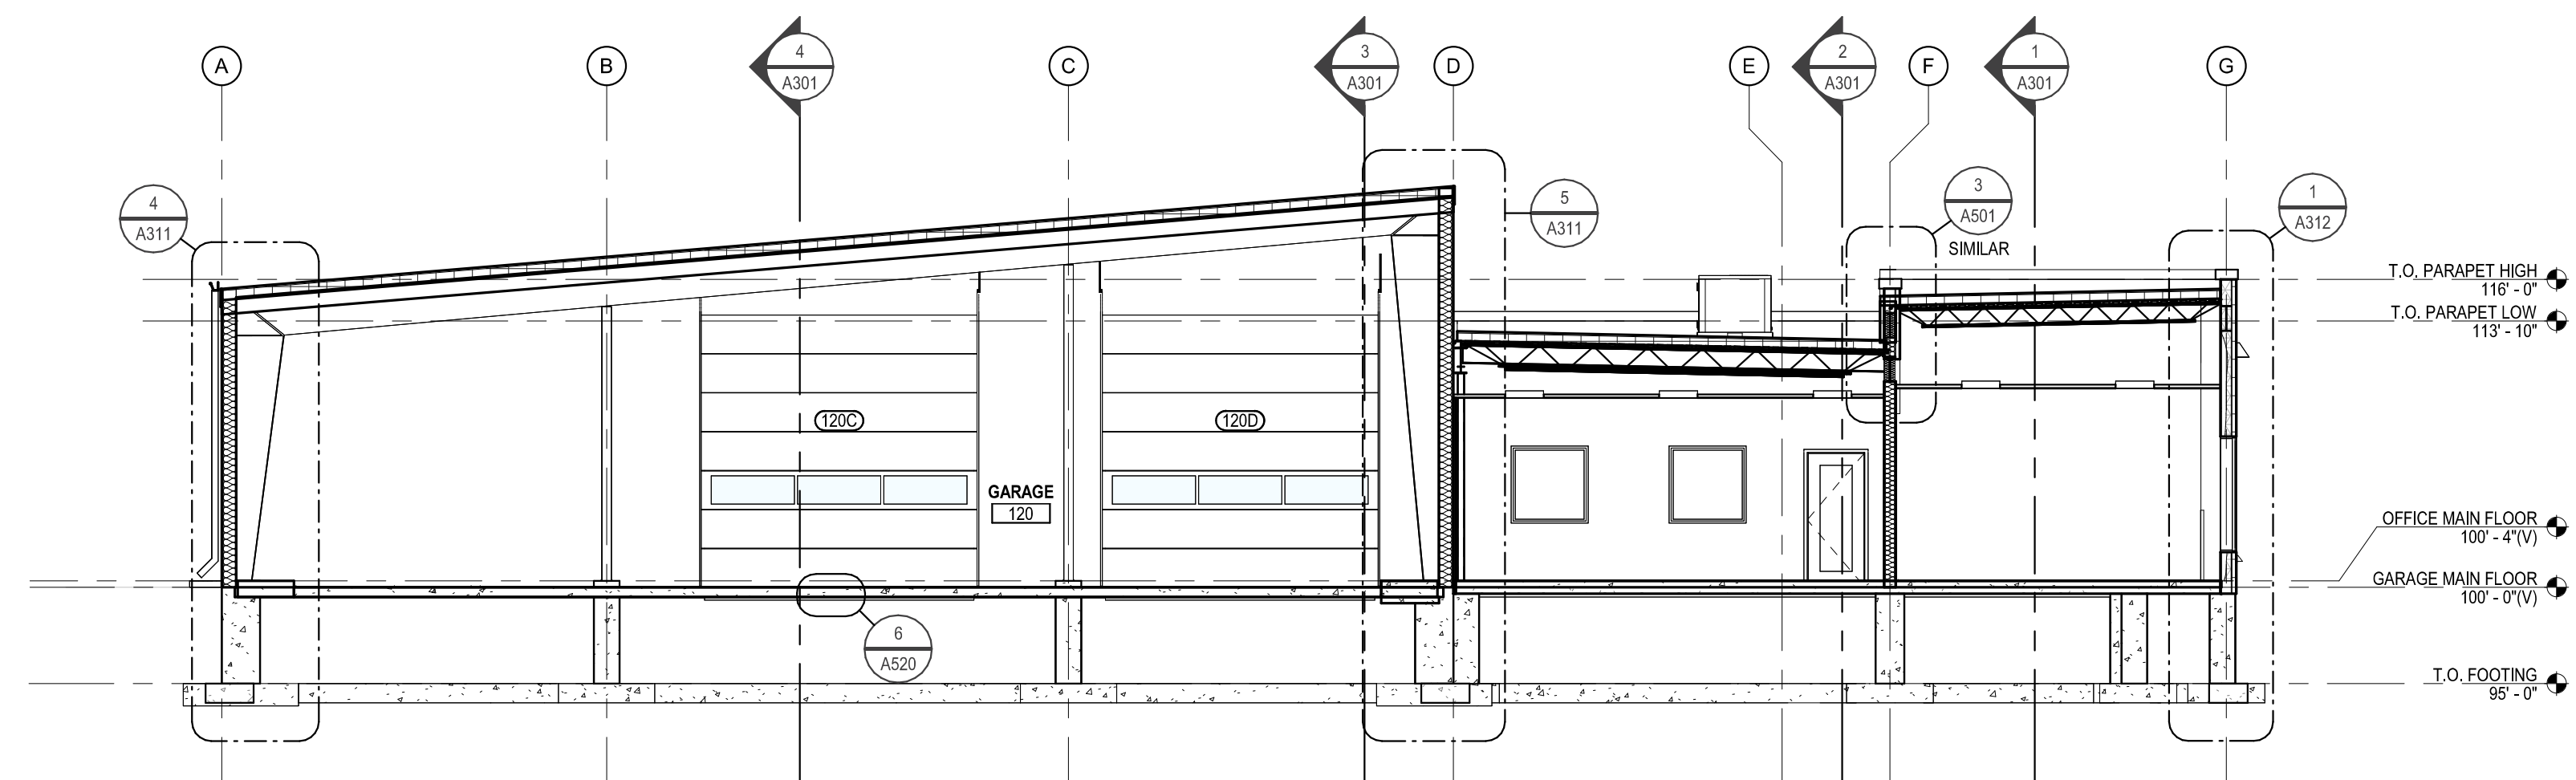
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1 A302 Building Section 5
 1/8" = 1'-0"



2 A302 Building Section 6
 1/8" = 1'-0"



3 A302 Building Section 7
 1/8" = 1'-0"



DRAWING HISTORY

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Building Sections

SHEET

A302



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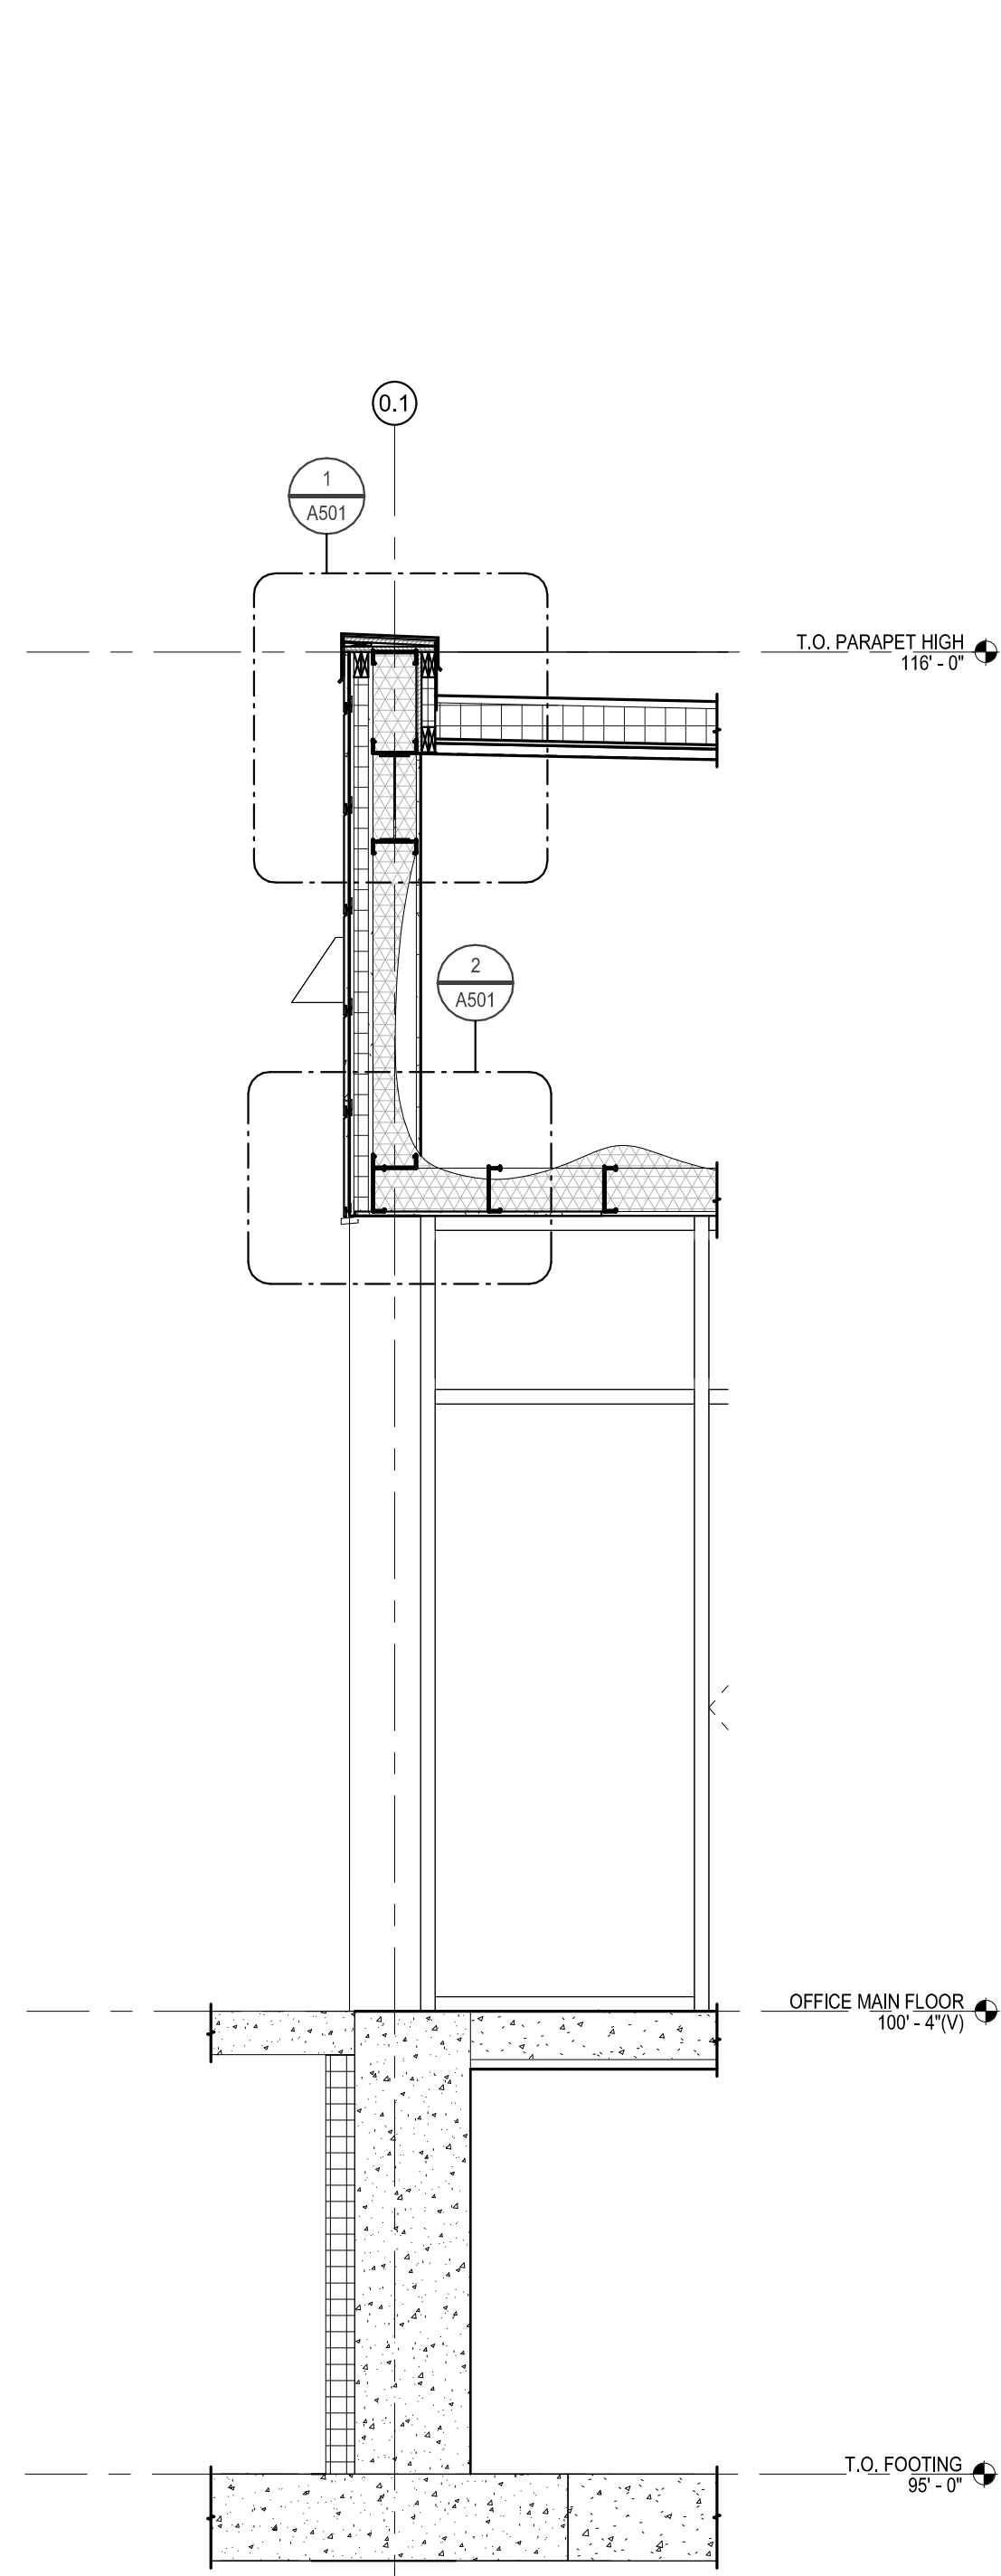
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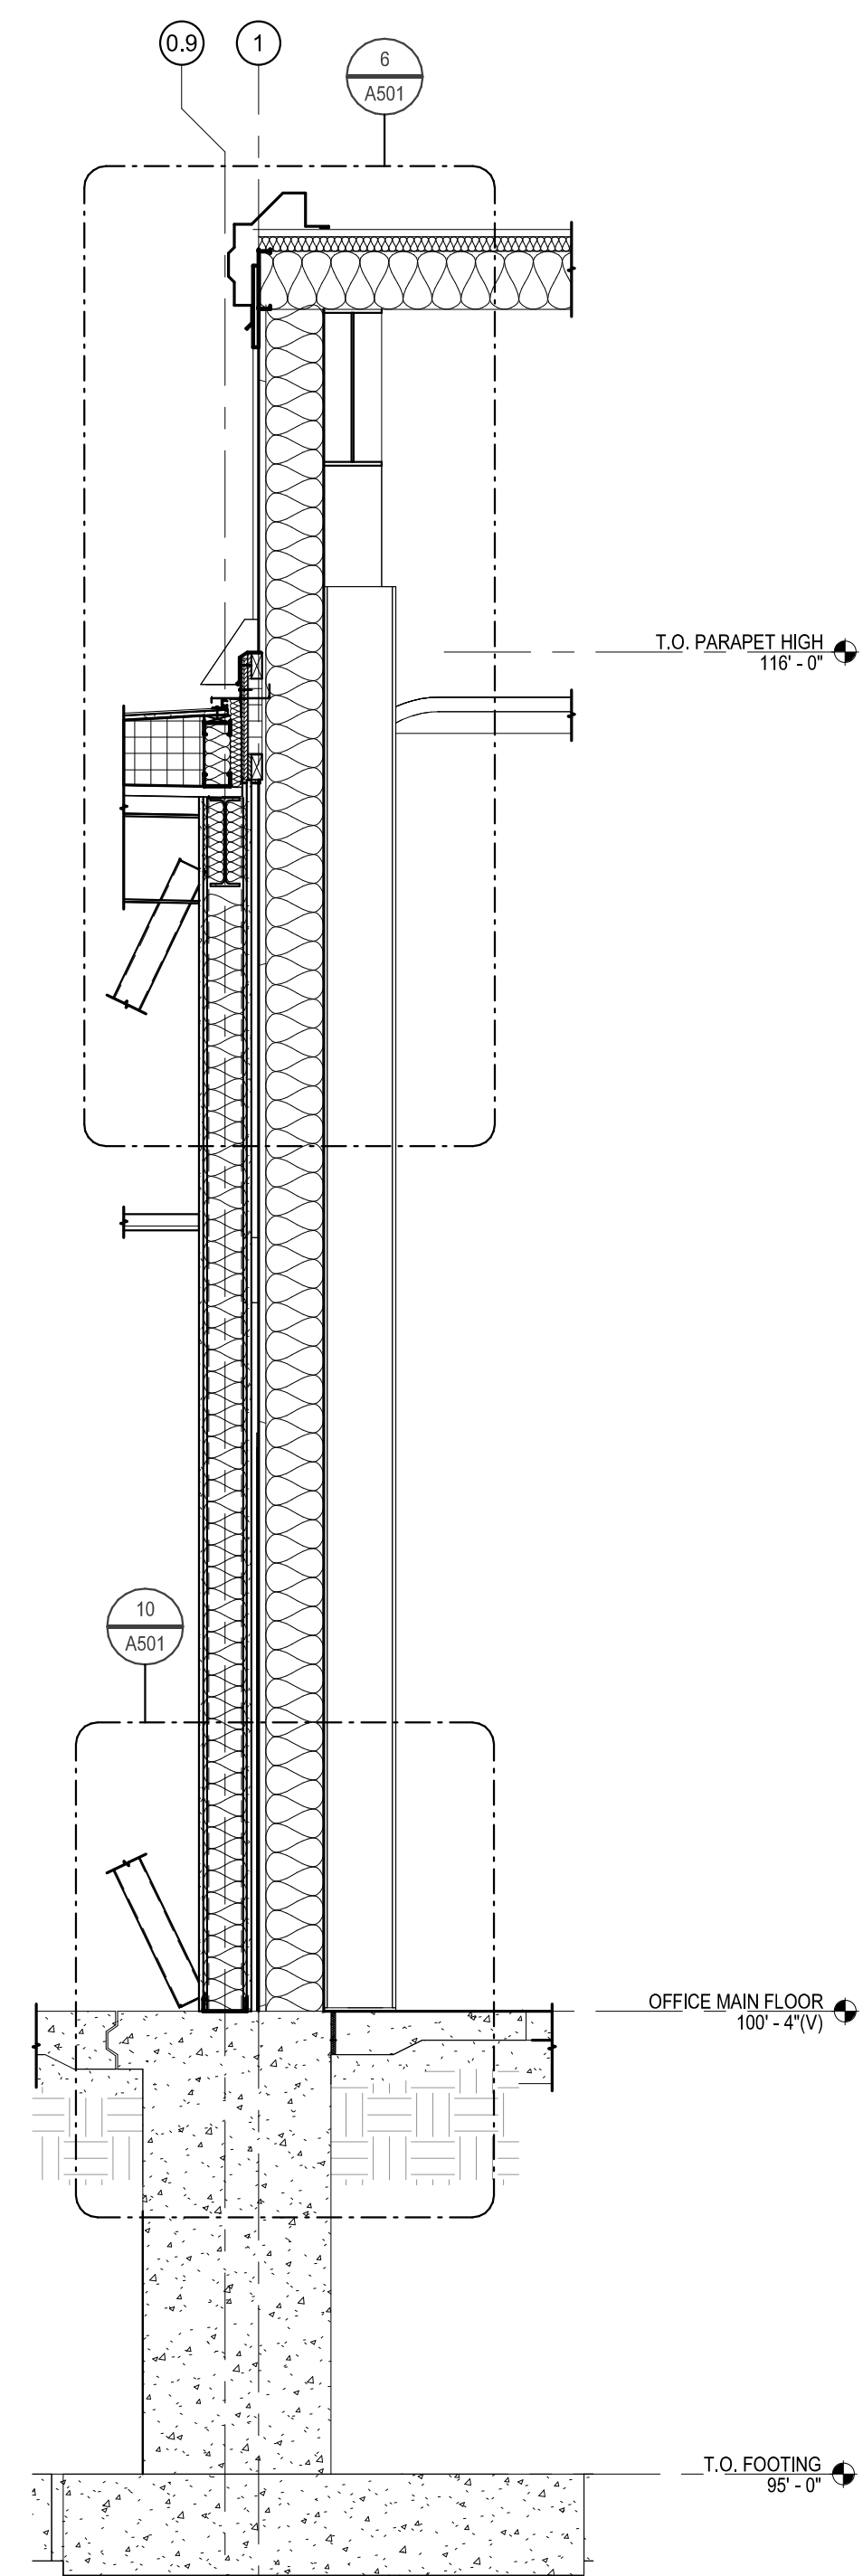
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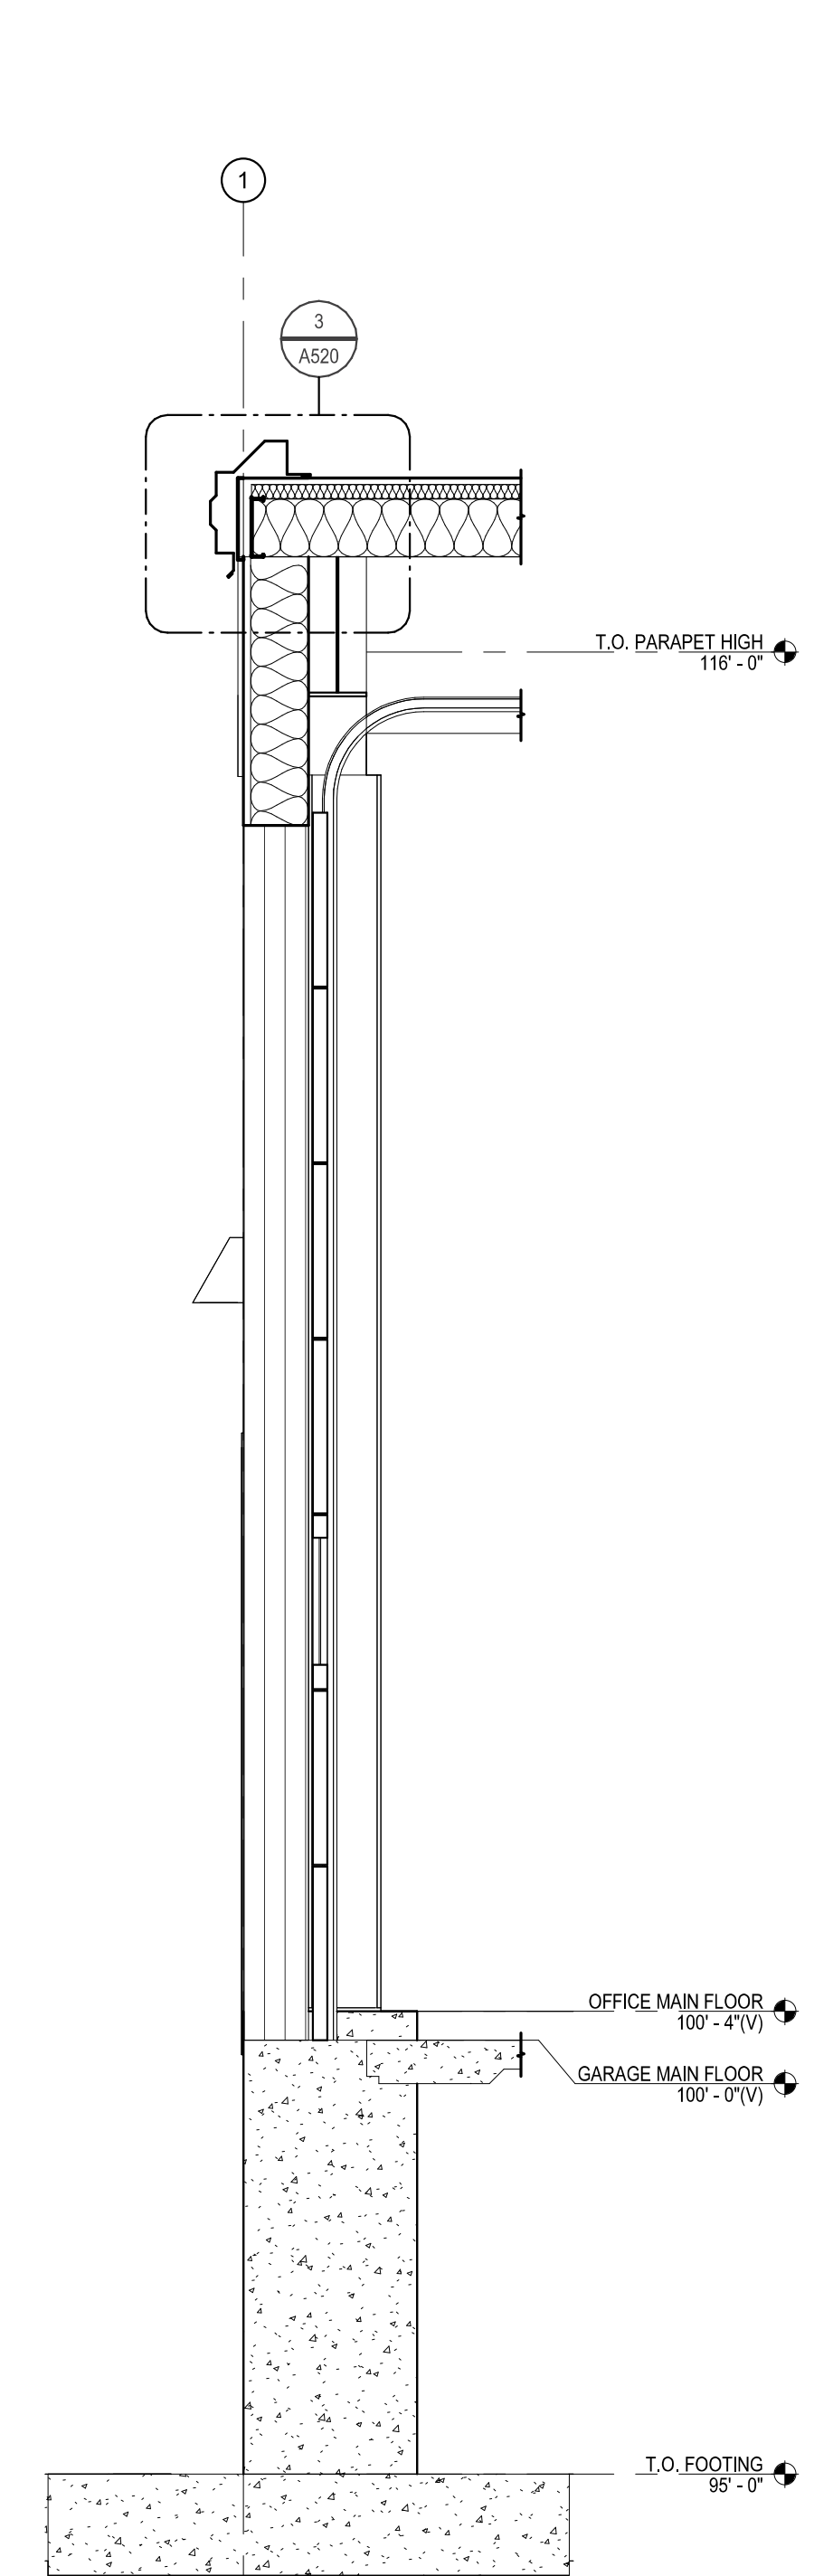
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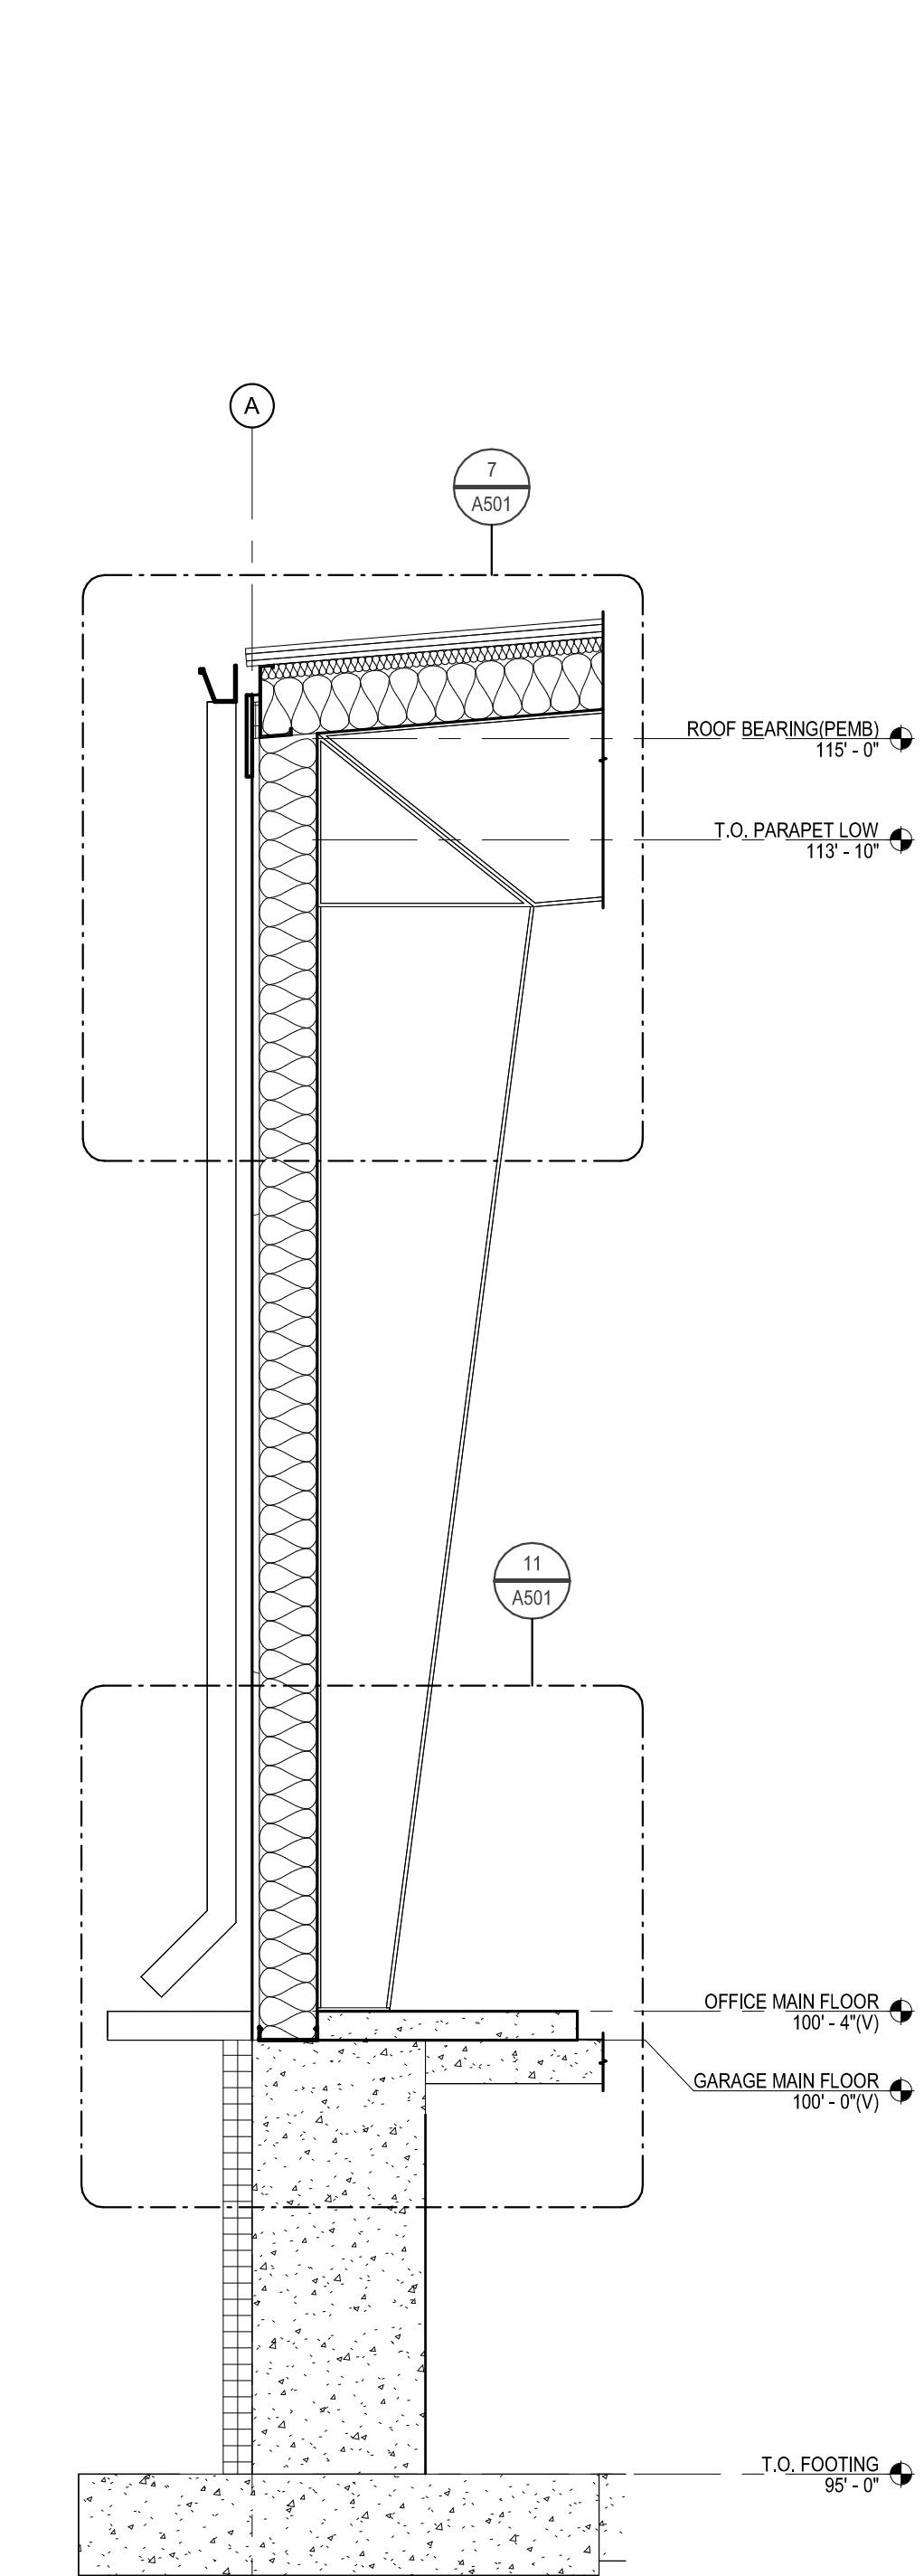
1 A311 Wall Section 1
 1/2" = 1'-0"




2 A311 Wall Section 2
 1/2" = 1'-0"



3 A311 Wall Section 3
 1/2" = 1'-0"



4 A311 Wall Section 4
 1/2" = 1'-0"

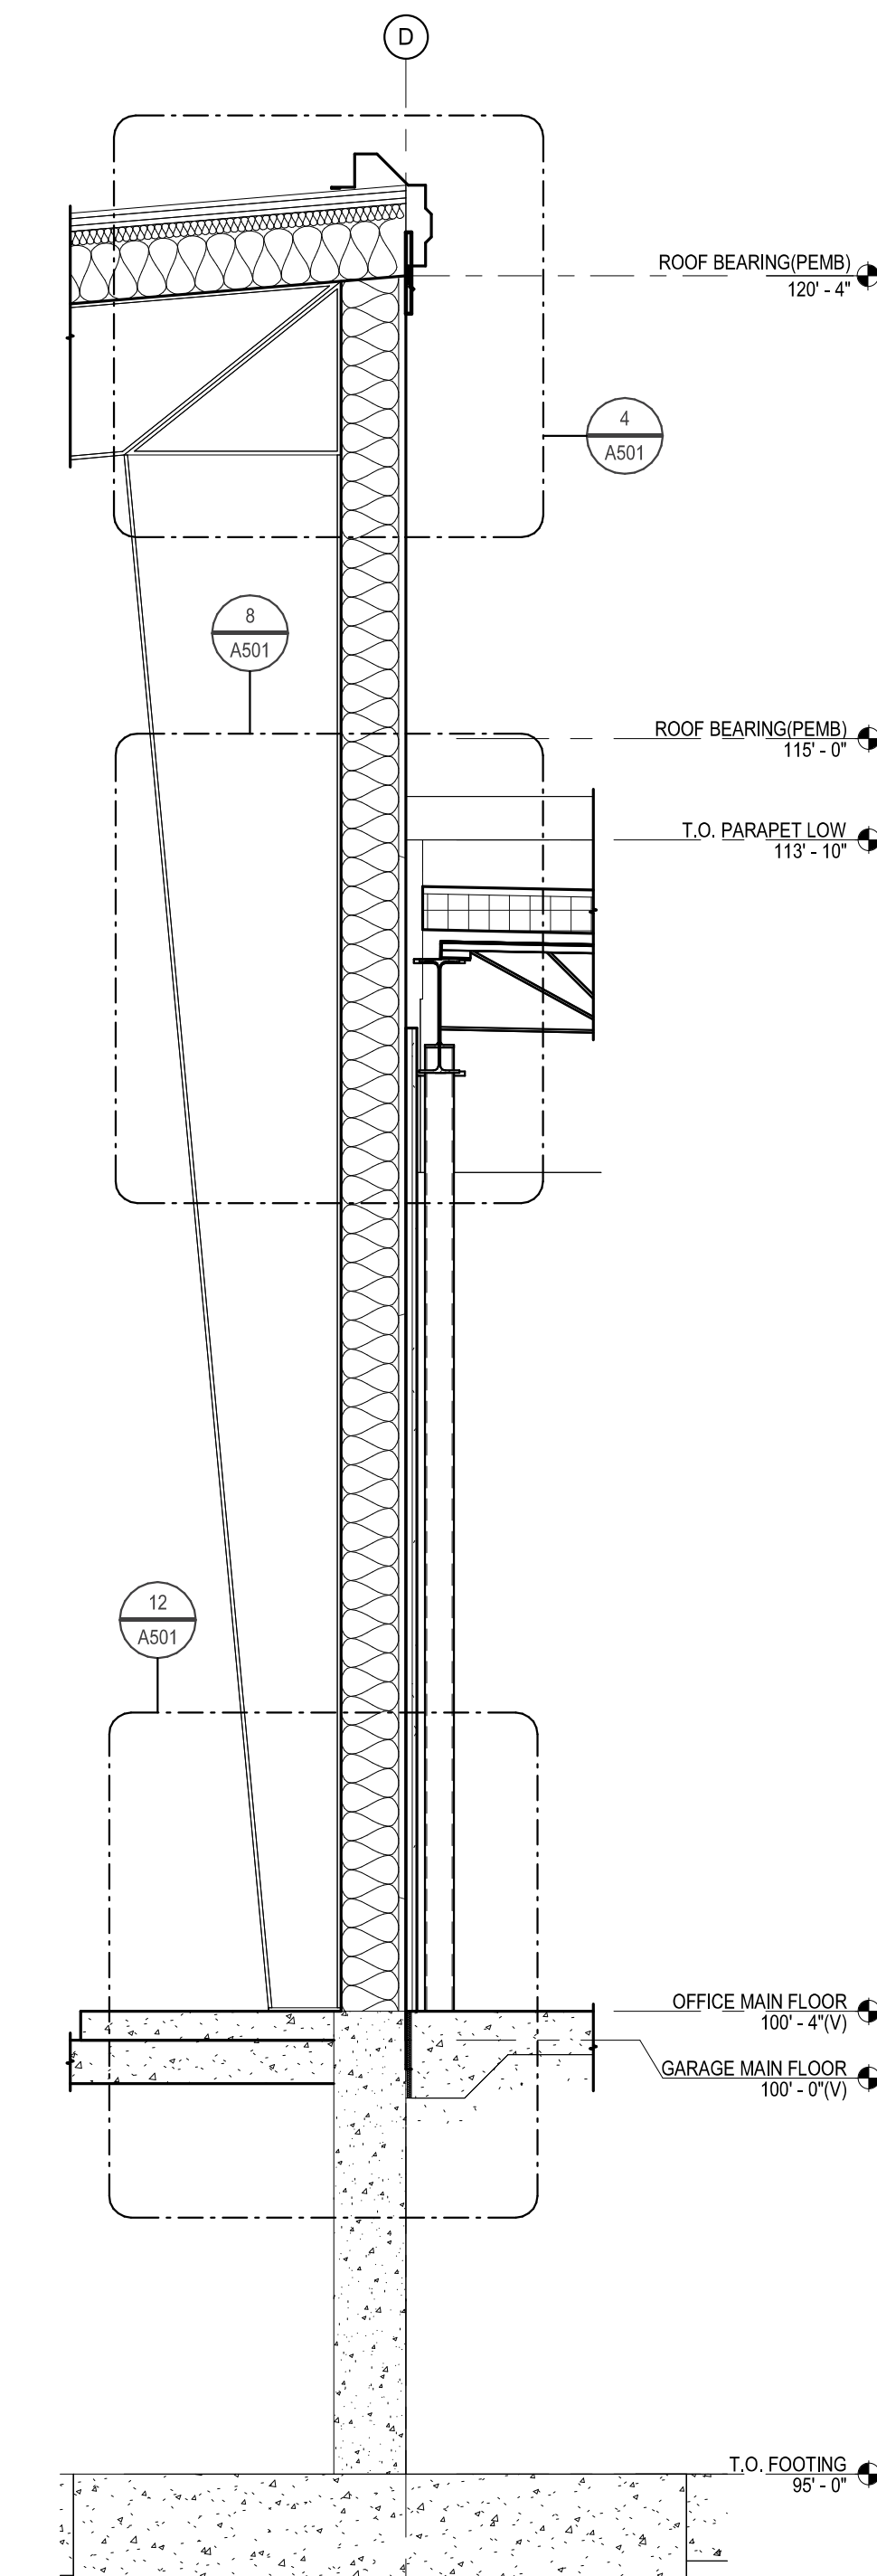

5 A311 Wall Section 5
 1/2" = 1'-0"



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Wall Sections

SHEET

A311



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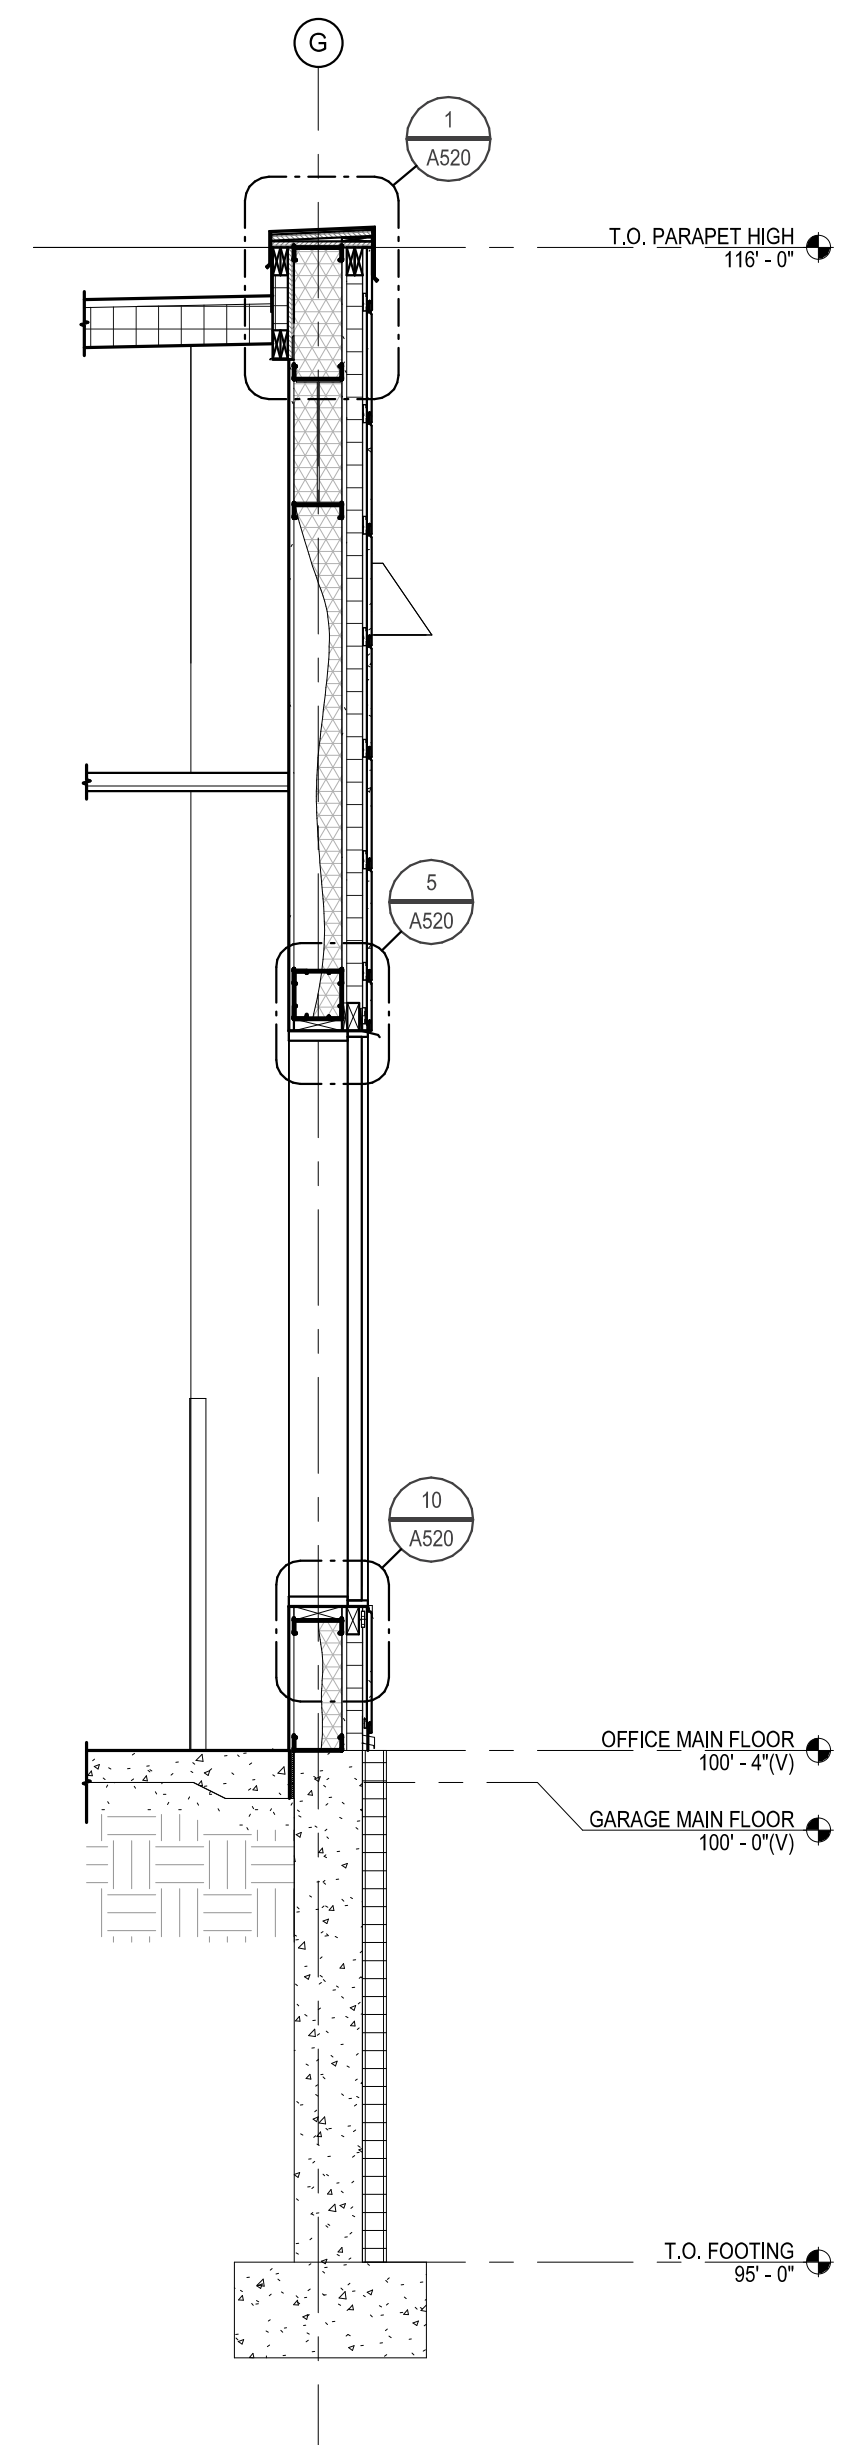
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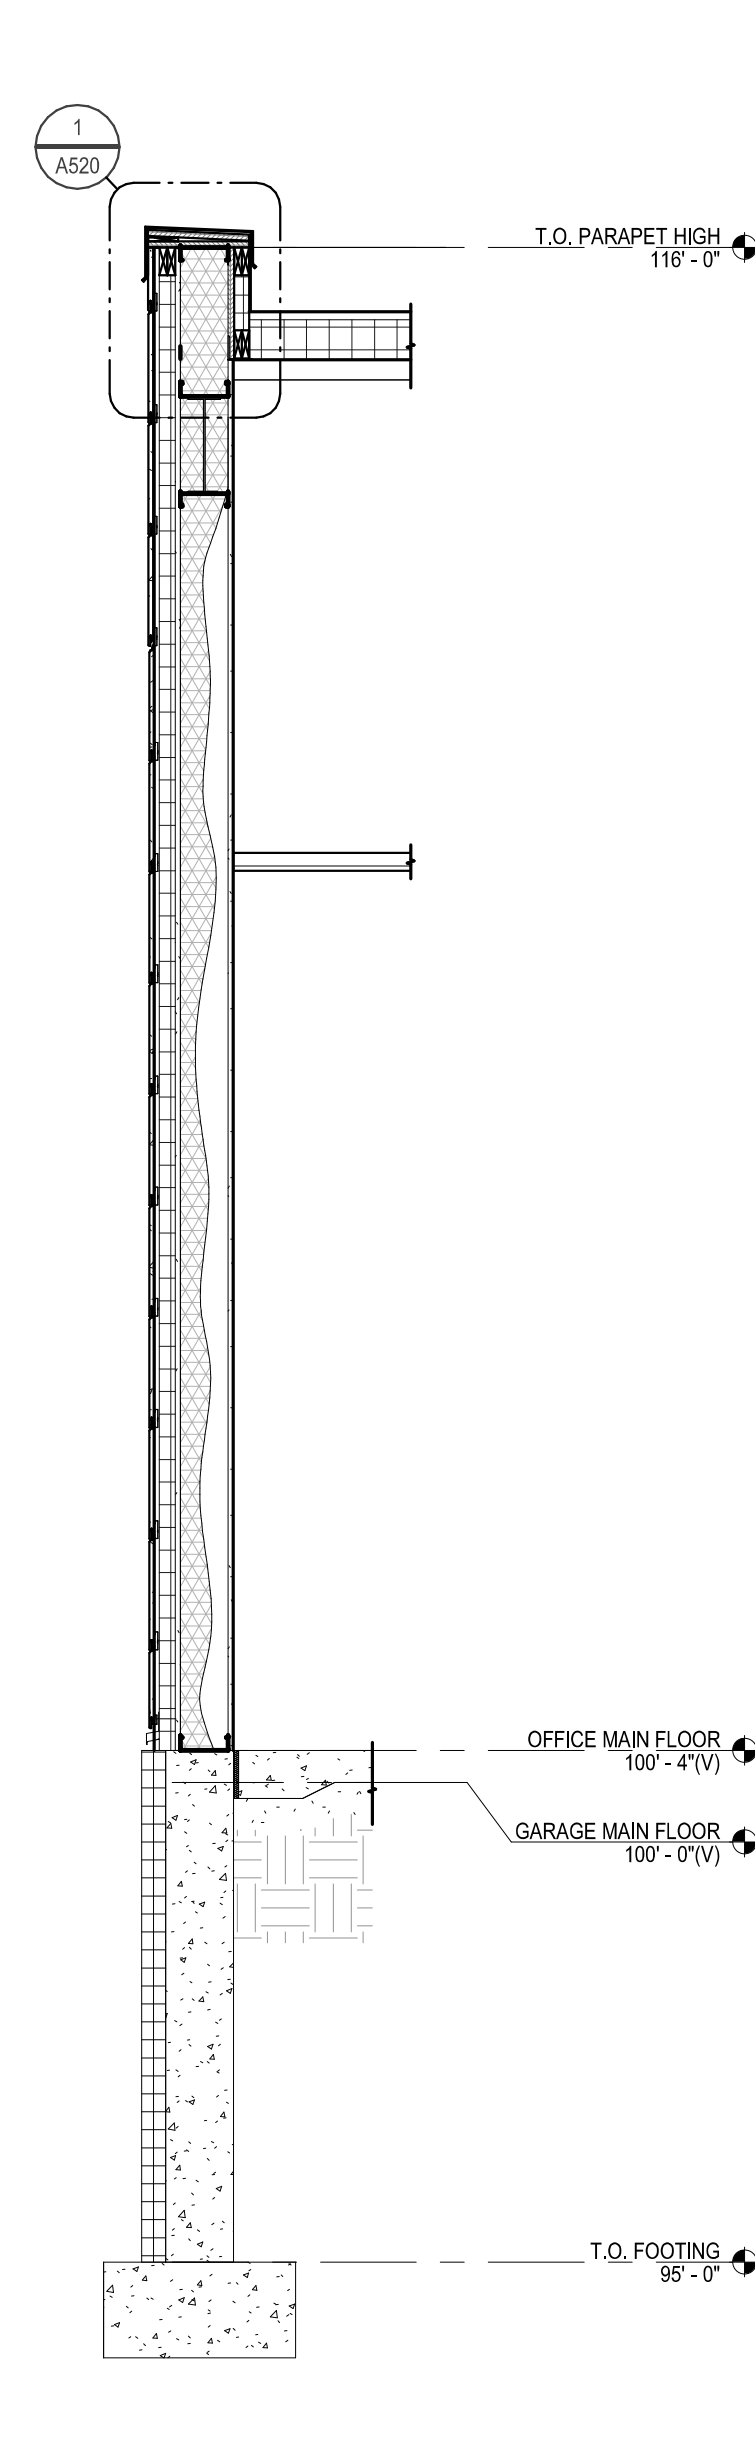
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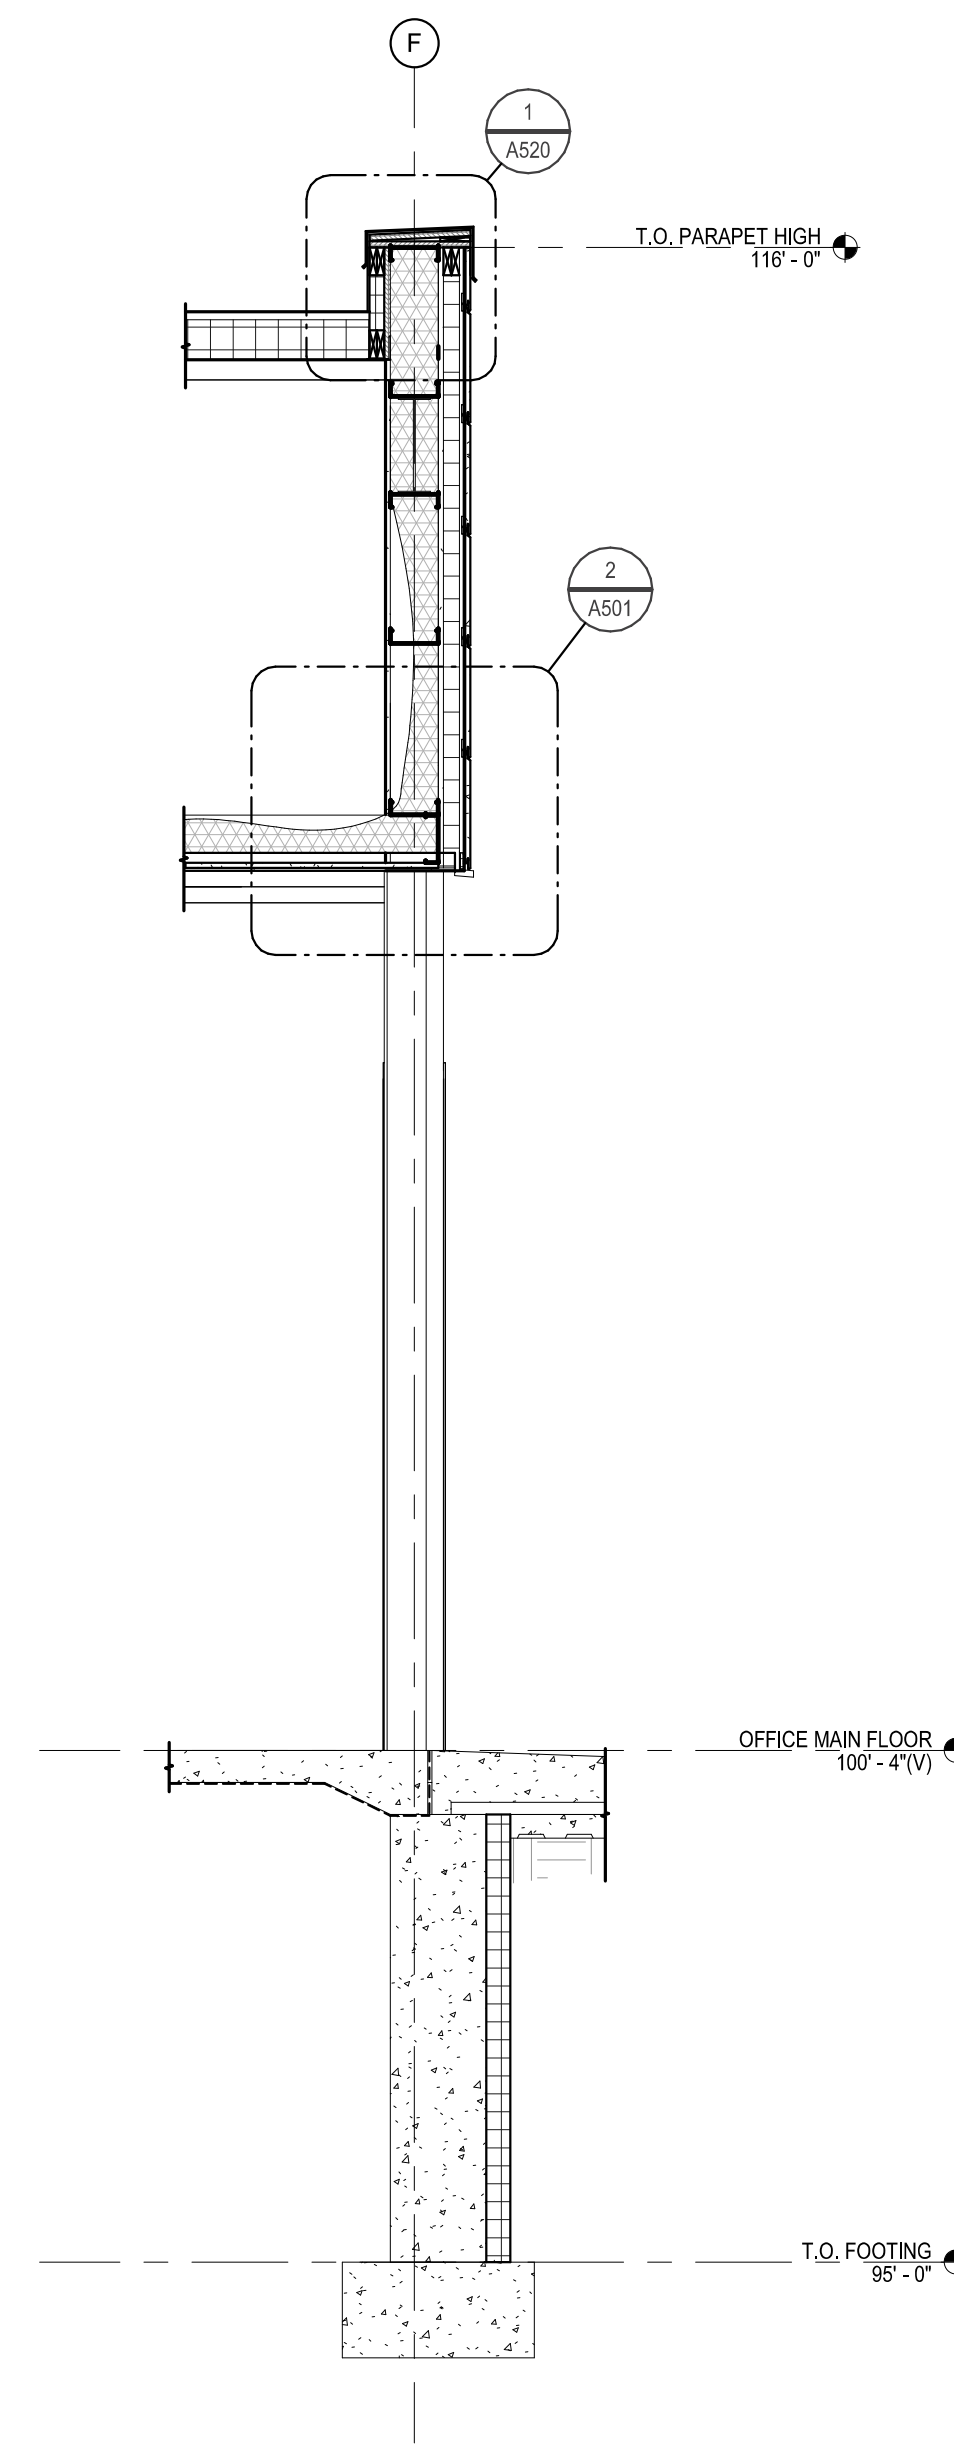
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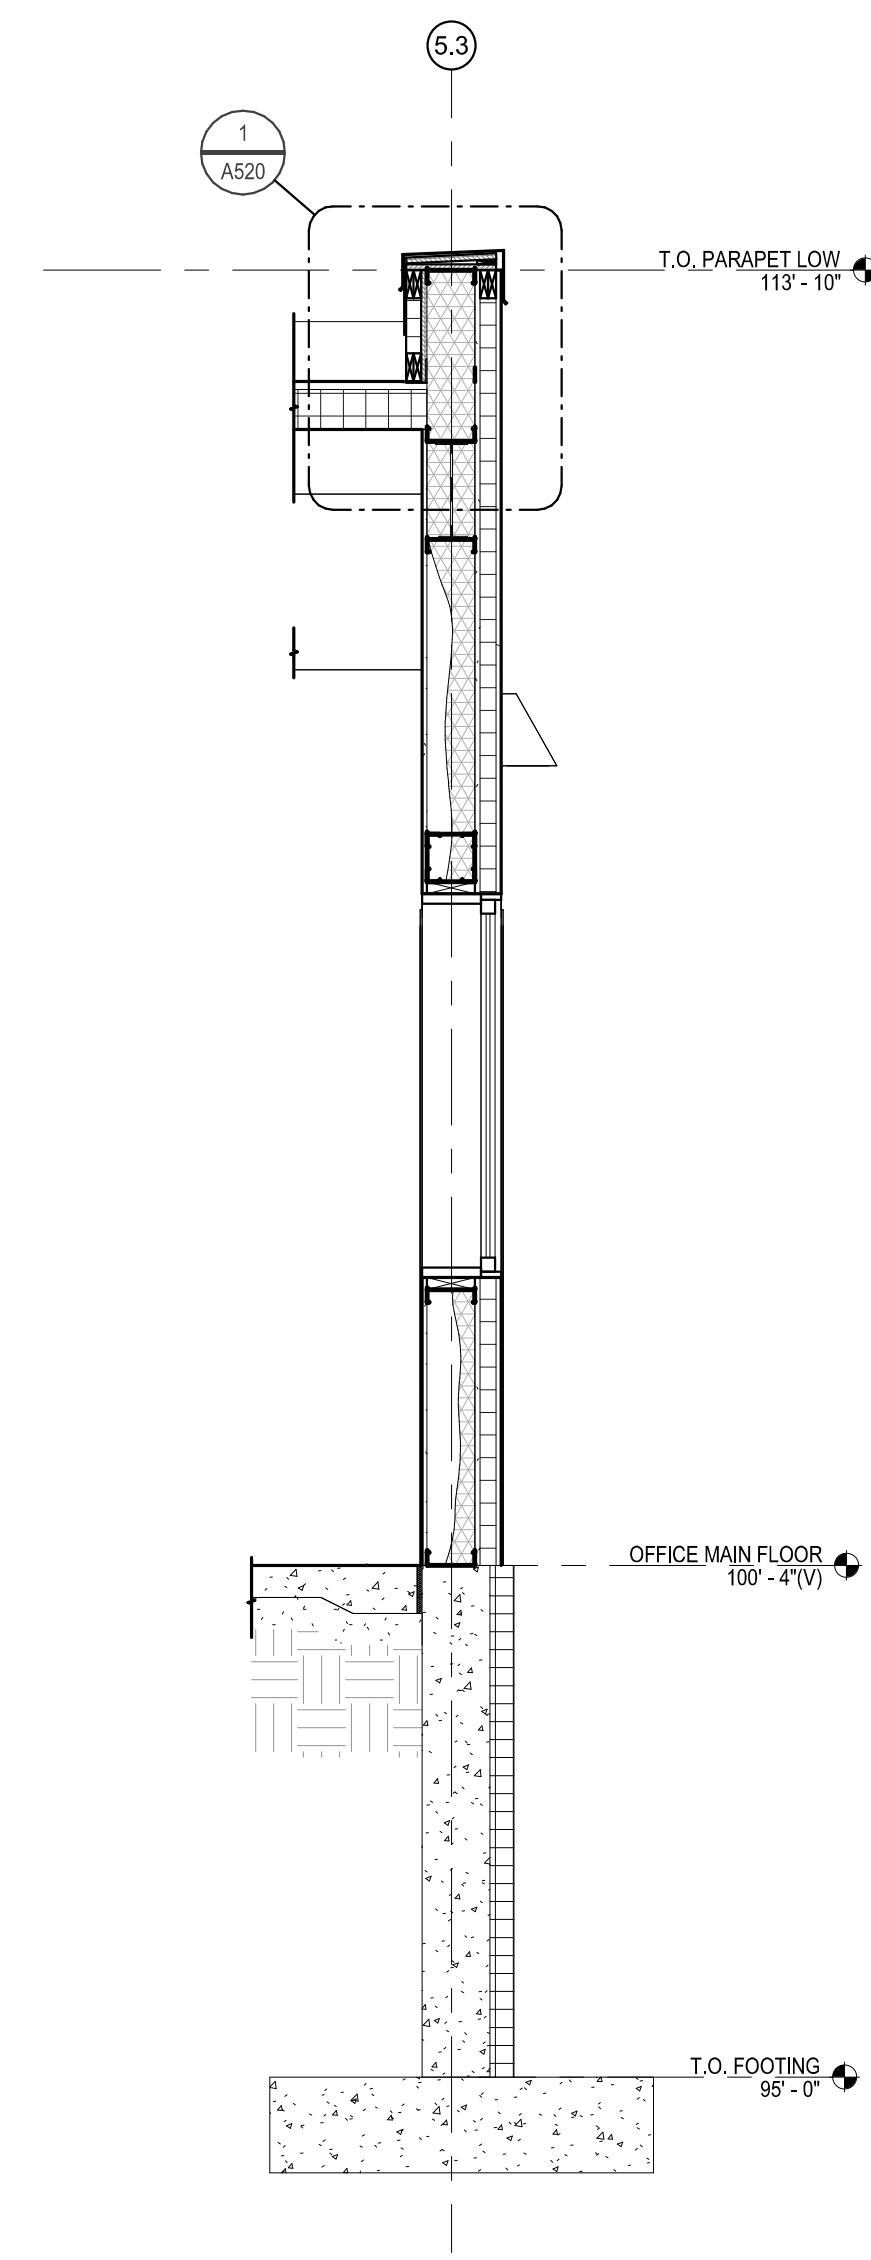
1 A312 Wall Section 6
 1/2" = 1'-0"



2 A312 Wall Section 7
 1/2" = 1'-0"



3 A312 Wall Section 8
 1/2" = 1'-0"



4 A312 Wall Section 9
 1/2" = 1'-0"



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Wall Sections

SHEET


A312

GENERAL NOTES - INTERIOR ELEVATIONS


- REFER TO FINISH FLOOR PLAN FOR WALL, BASE AND FLOOR FINISHES.
- REFER TO REFLECTED CEILING PLAN FOR CEILING HEIGHT & FINISHES.
- REFER TO G003 FOR STANDARD MOUNTING HEIGHTS.
- HALFTONE FURNITURE, EQUIPMENT AND ACCESSORIES FOR REFERENCE ONLY - BY OWNER.
- ALL TVS AND WALL BRACKETS BY OWNER; PROVIDE POWER, DATA AND BLOCKING AS REQUIRED.
- HP-1 TO BE USED ON ALL CABINETS UNO.
- FINISHED CABINET END IDENTIFIED BY: ◀

KEYNOTES - INTERIOR ELEVATIONS


- MTLP-1 AT TOP OF WALL TILE AND OUTSIDE CORNERS.
- MTLP-2 AT BASE OF WALL TILE, COVE TRANSITION TO FLOOR TILE.
- DOUBLE PULL OUT TRASH/RECYCLING.
- SSF-1 COUNTER W/ 6" H APRON; INSTALL CONCEALED WALL BRACKETS AS REQUIRED.
- 24x36 MIR.
- INSTALL CONCEALED WALL BRACKETS AS REQUIRED.

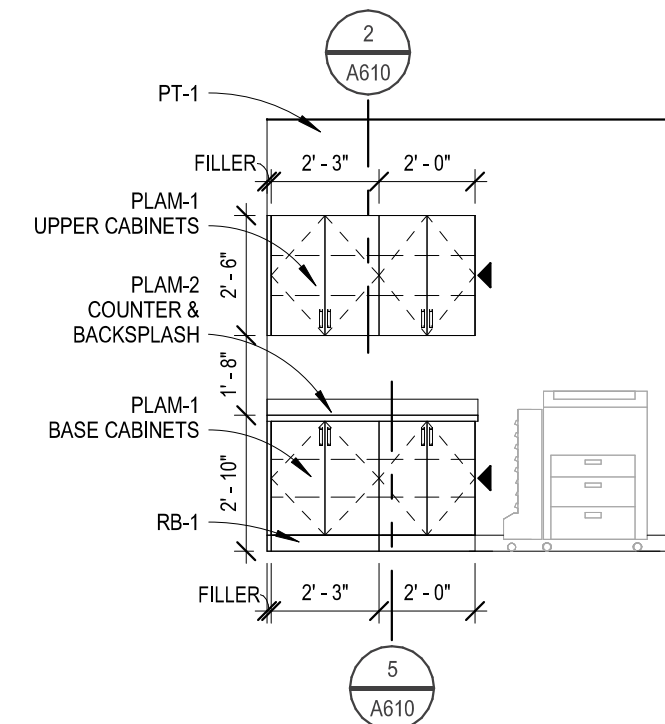


1 A401 Print 116
1/4" = 1'-0"

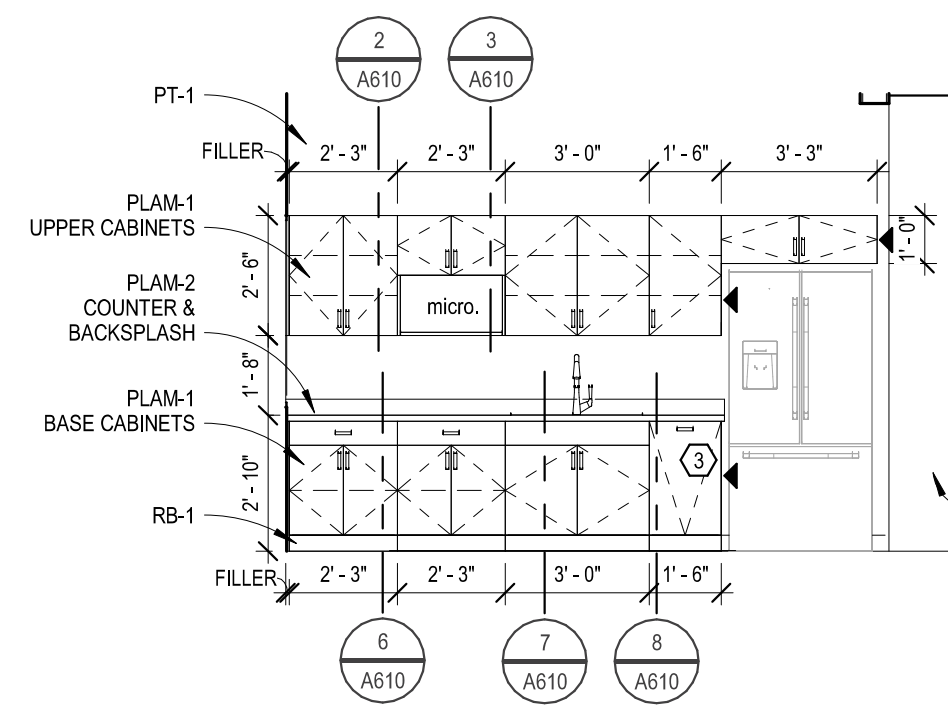


2 A401 Breakroom 111
1/4" = 1'-0"

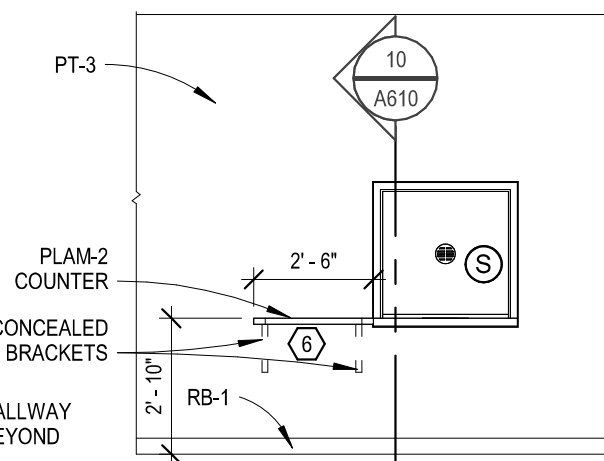


3 A401 Customer Service Window
1/4" = 1'-0"

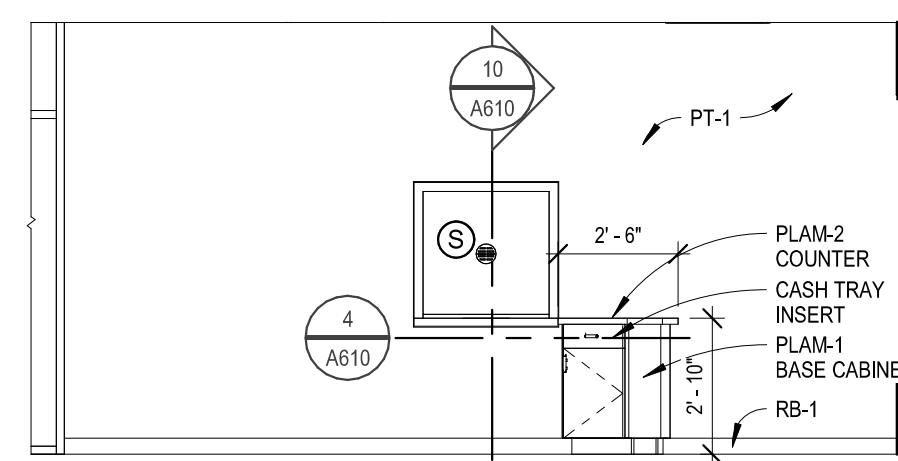


4 A401 Open Office
1/4" = 1'-0"

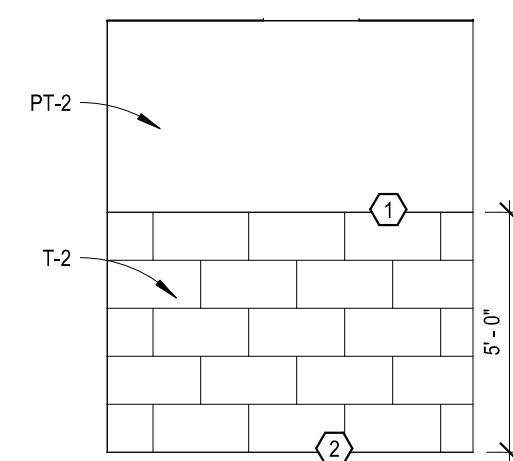


5 A401 Room 117-North
1/4" = 1'-0"

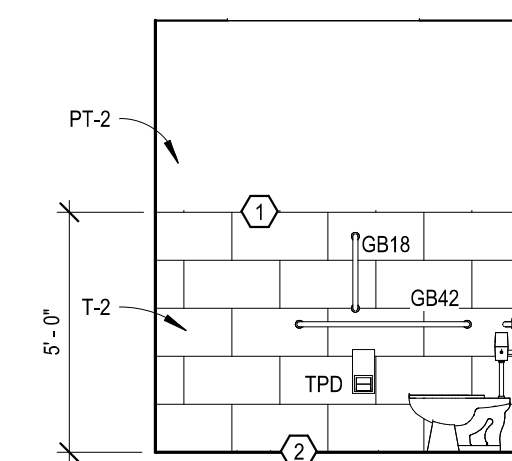


6 A401 Room 117-East
1/4" = 1'-0"

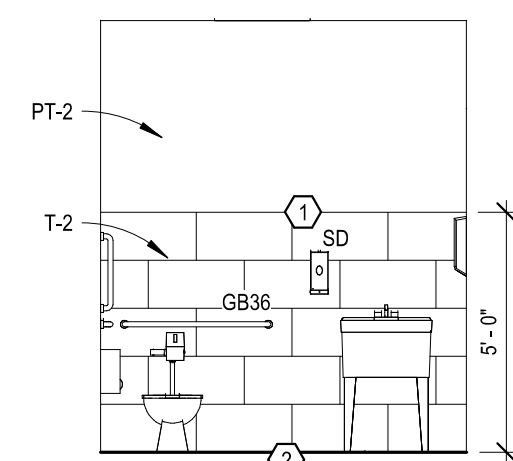


7 A401 Room 117-South
1/4" = 1'-0"

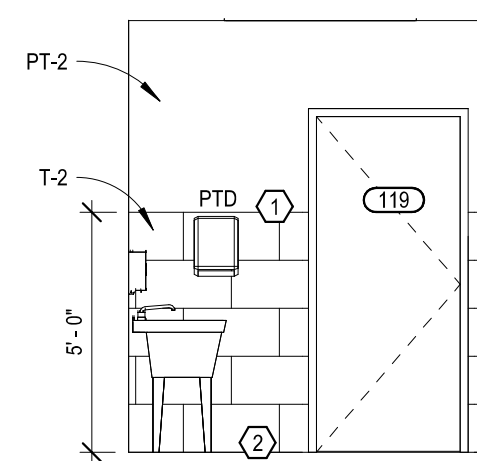


8 A401 Room 119-West
1/4" = 1'-0"

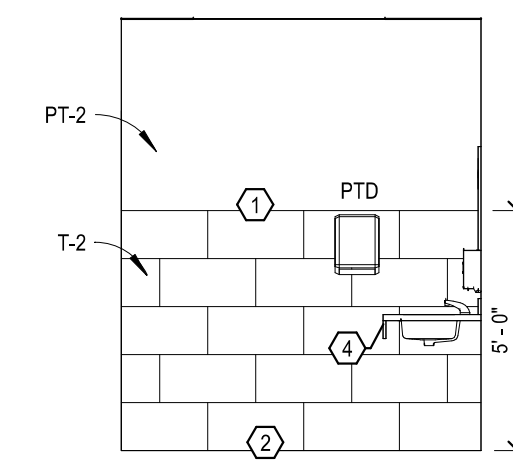


9 A401 Room 118-East
1/4" = 1'-0"

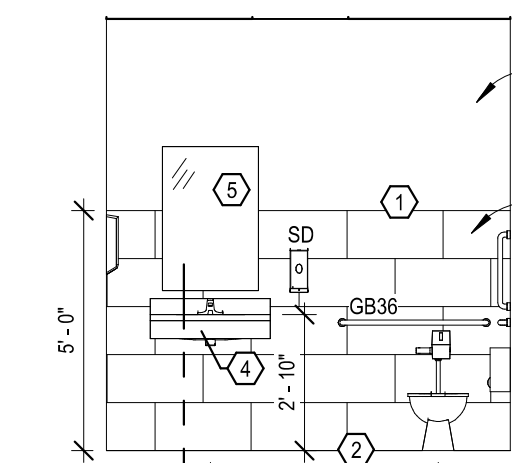


10 A401 Room 118-South
1/4" = 1'-0"

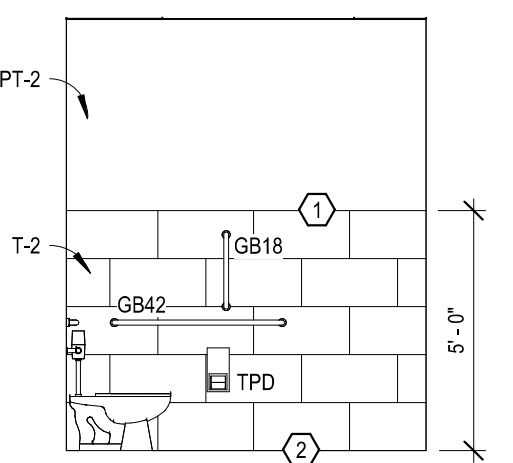


11 A401 Room 118-West
1/4" = 1'-0"

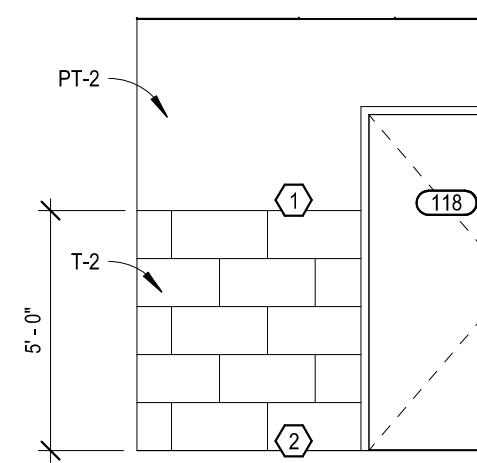


12 A401 Room 118-North
1/4" = 1'-0"

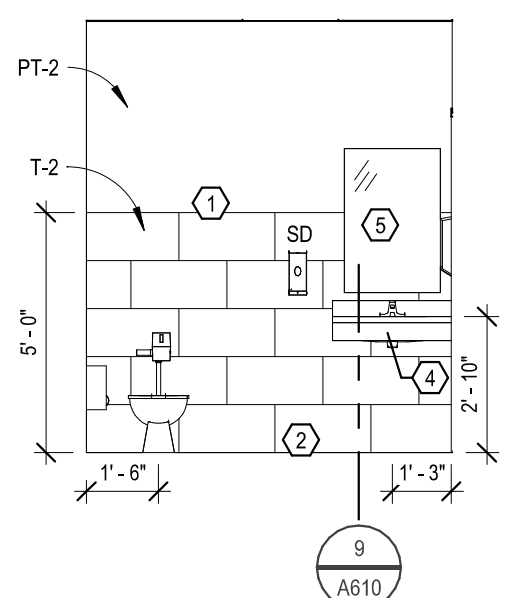


13 A401 Room 116-North
1/4" = 1'-0"

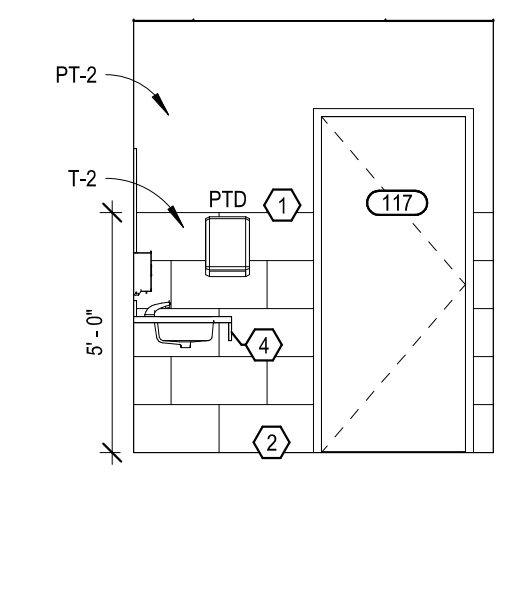


14 A401 Room 116-West
1/4" = 1'-0"

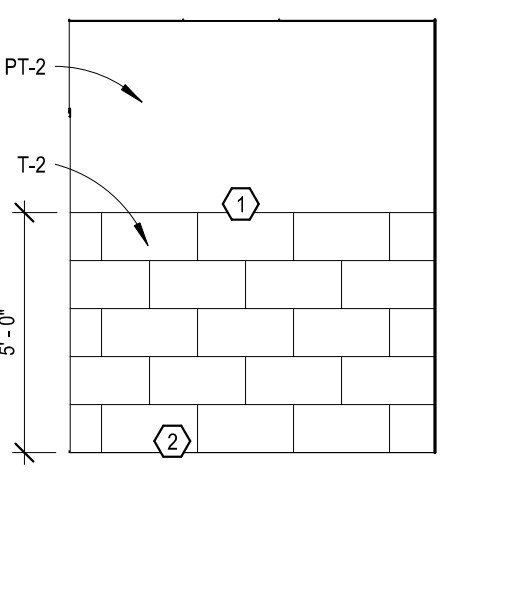

15 A401 Room 116-South
1/4" = 1'-0"

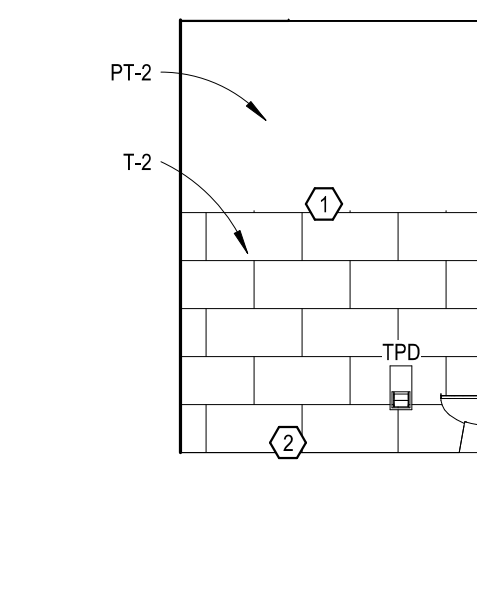

16 A401 Room 116-East
1/4" = 1'-0"

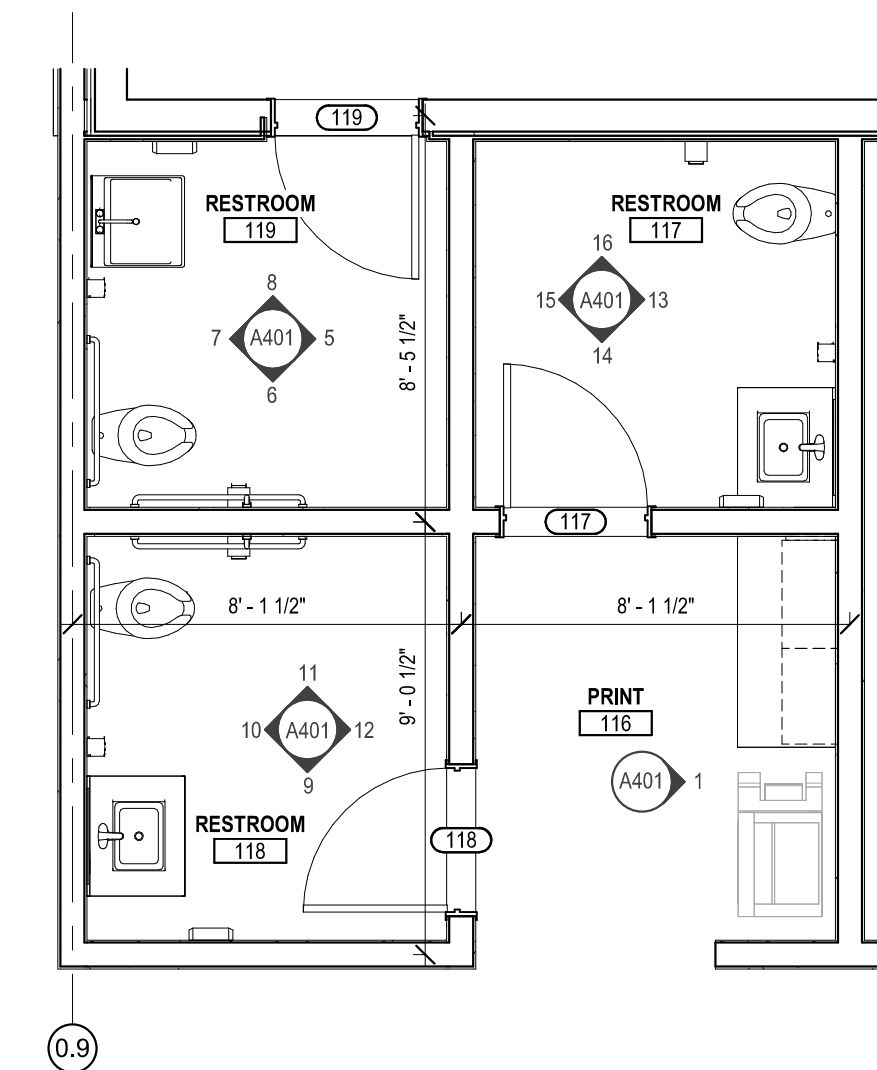

17 A401 Enlarged Floor Plan
1/4" = 1'-0"



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STRUCTURAL

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Enlarged Plans & Interior Elevations

SHEET

A401



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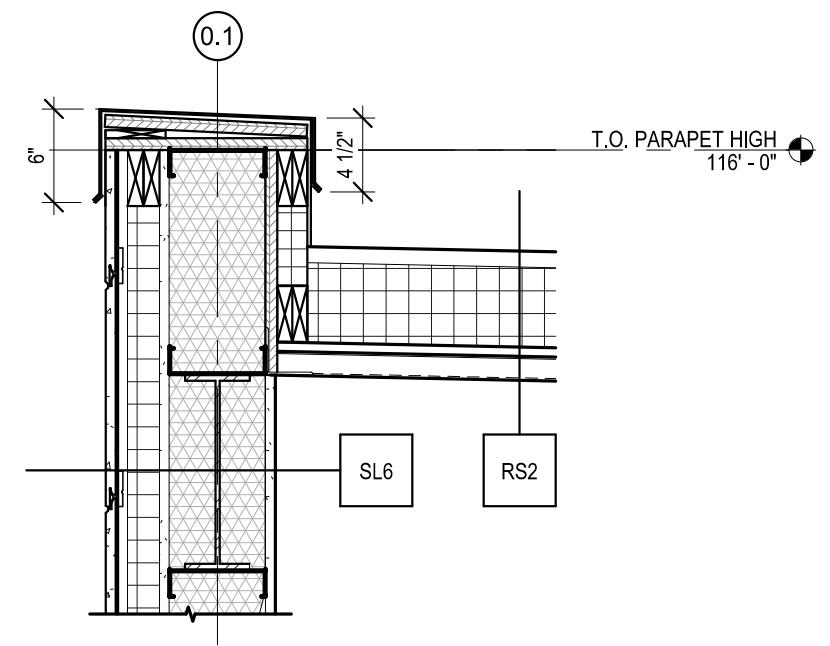
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1	CONSTRUCTION DOCUMENTS	01/15/2025

DRAWN BY: Author JN: 24-054


Section Details

SHEET


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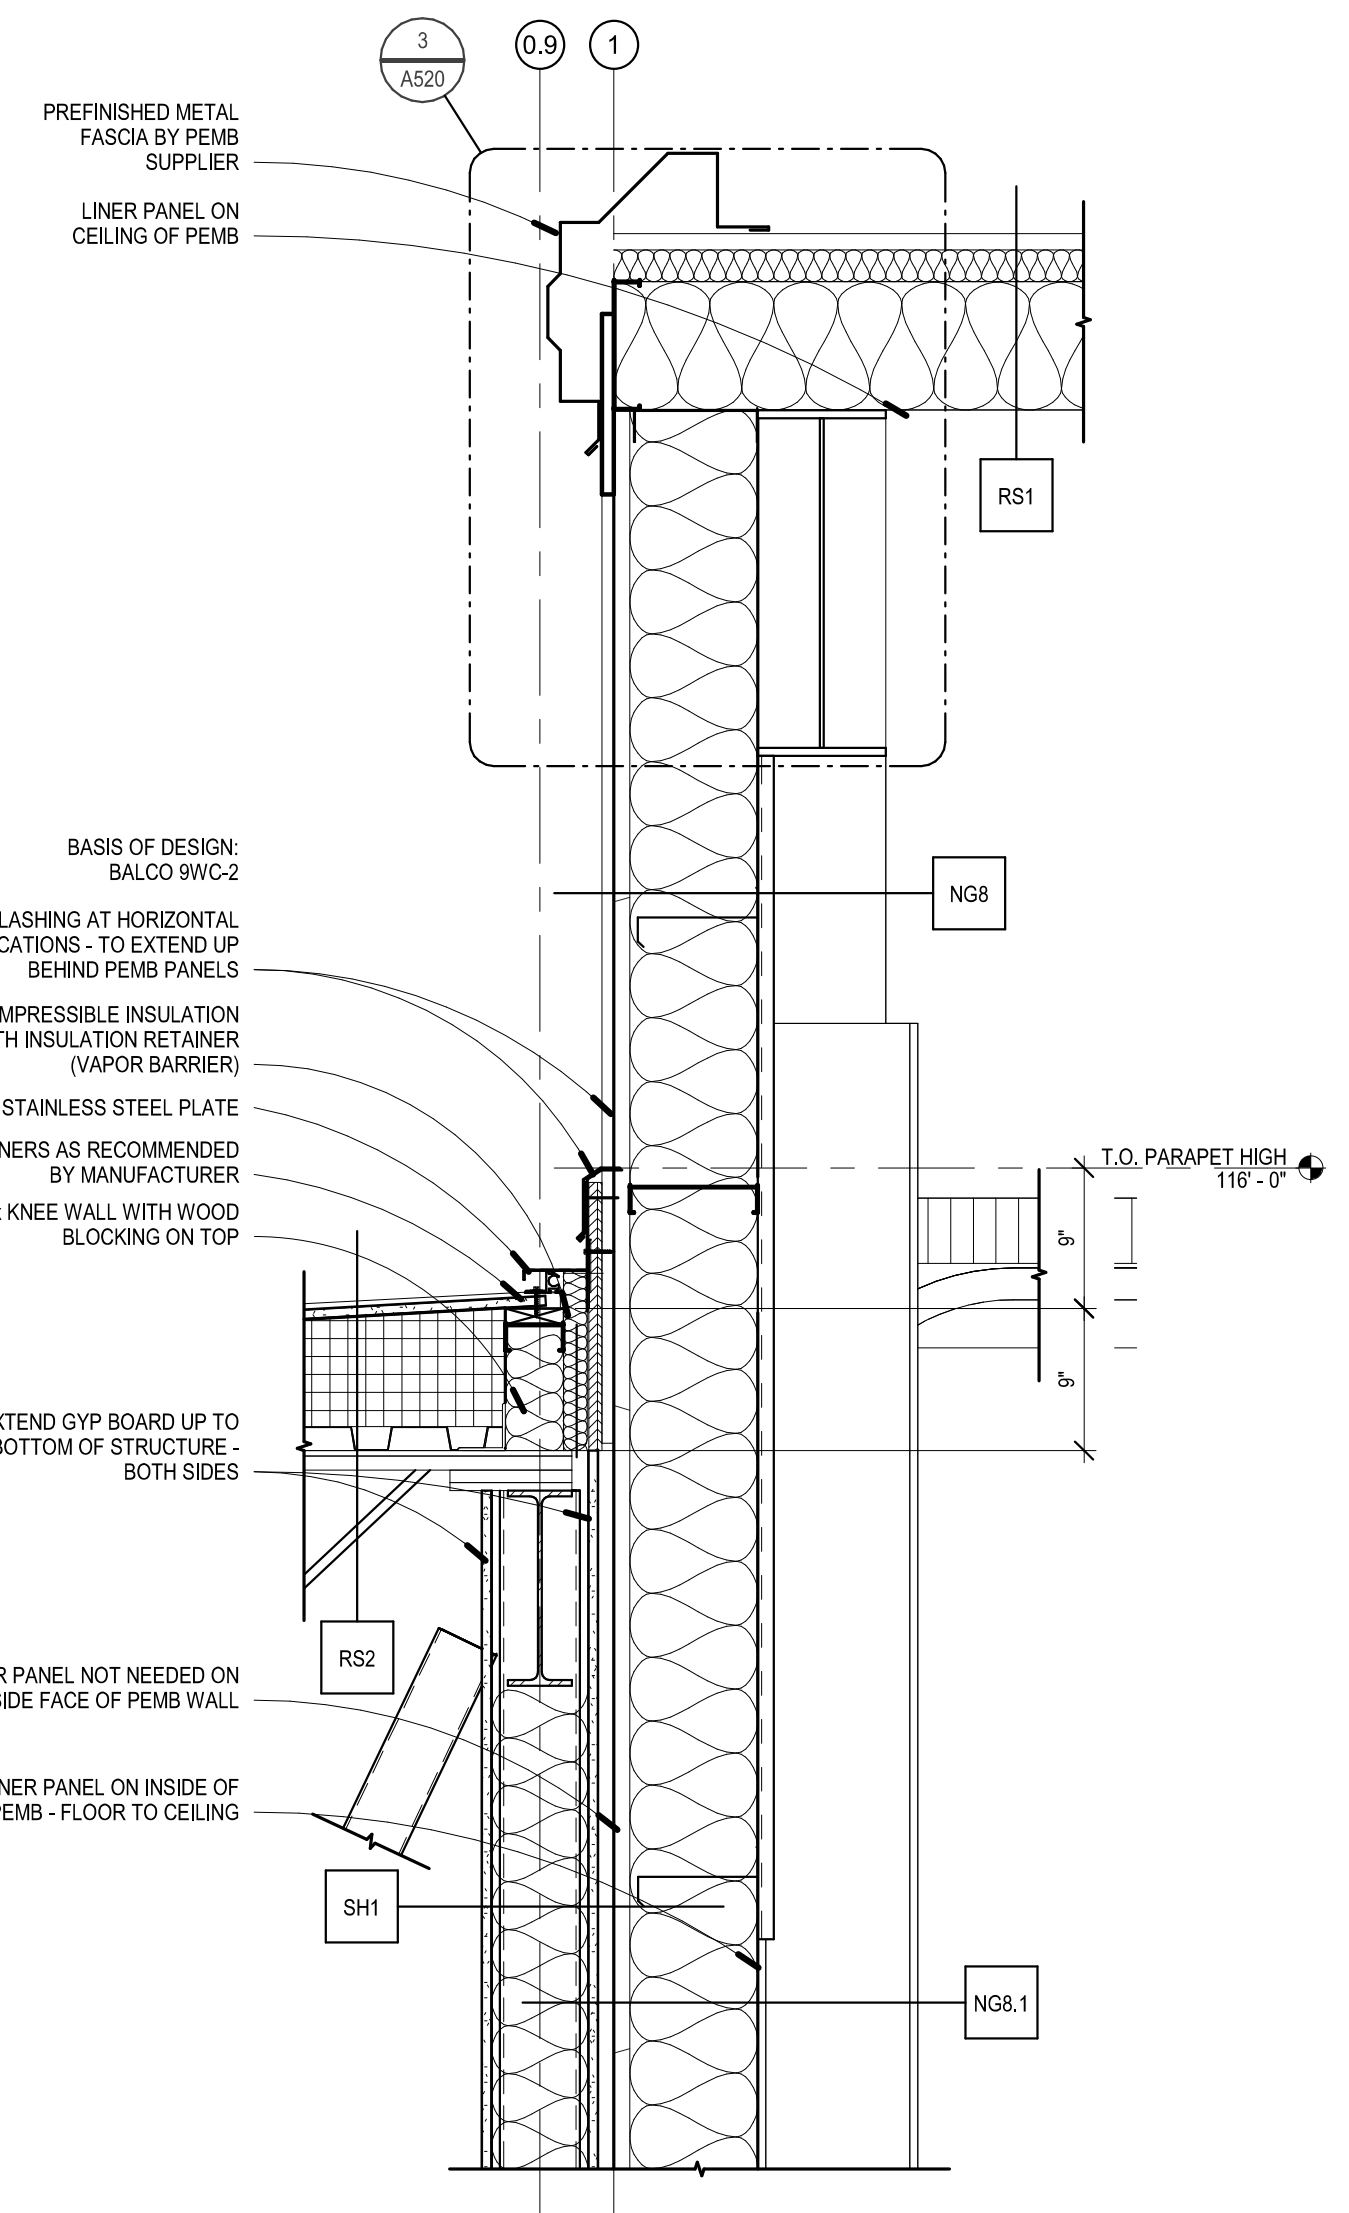
1 A501 Wall Parapet Detail
1" = 1'-0"




2 A501 Wall Soffit Detail
1" = 1'-0"

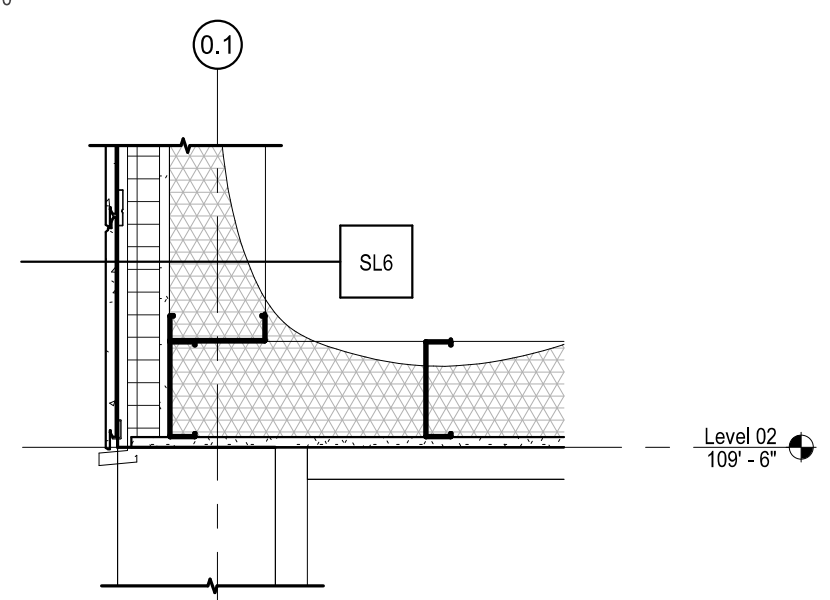


5 A501 Wall Parapet Detail
1" = 1'-0"

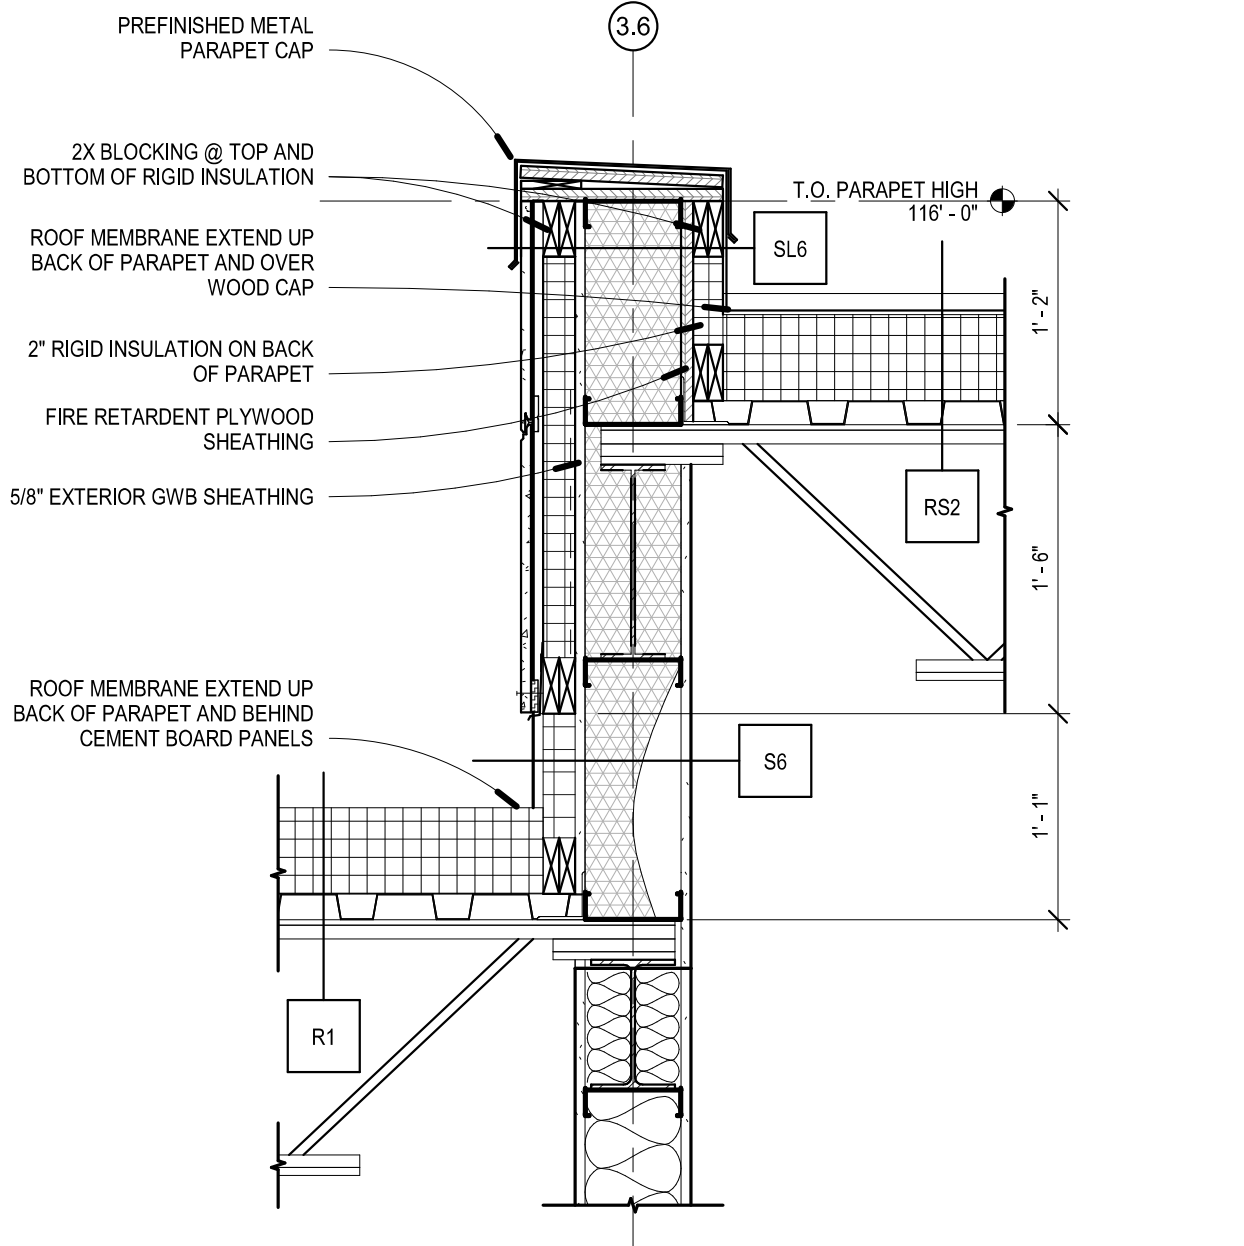


6 A501 Wall Parapet Detail
1" = 1'-0"

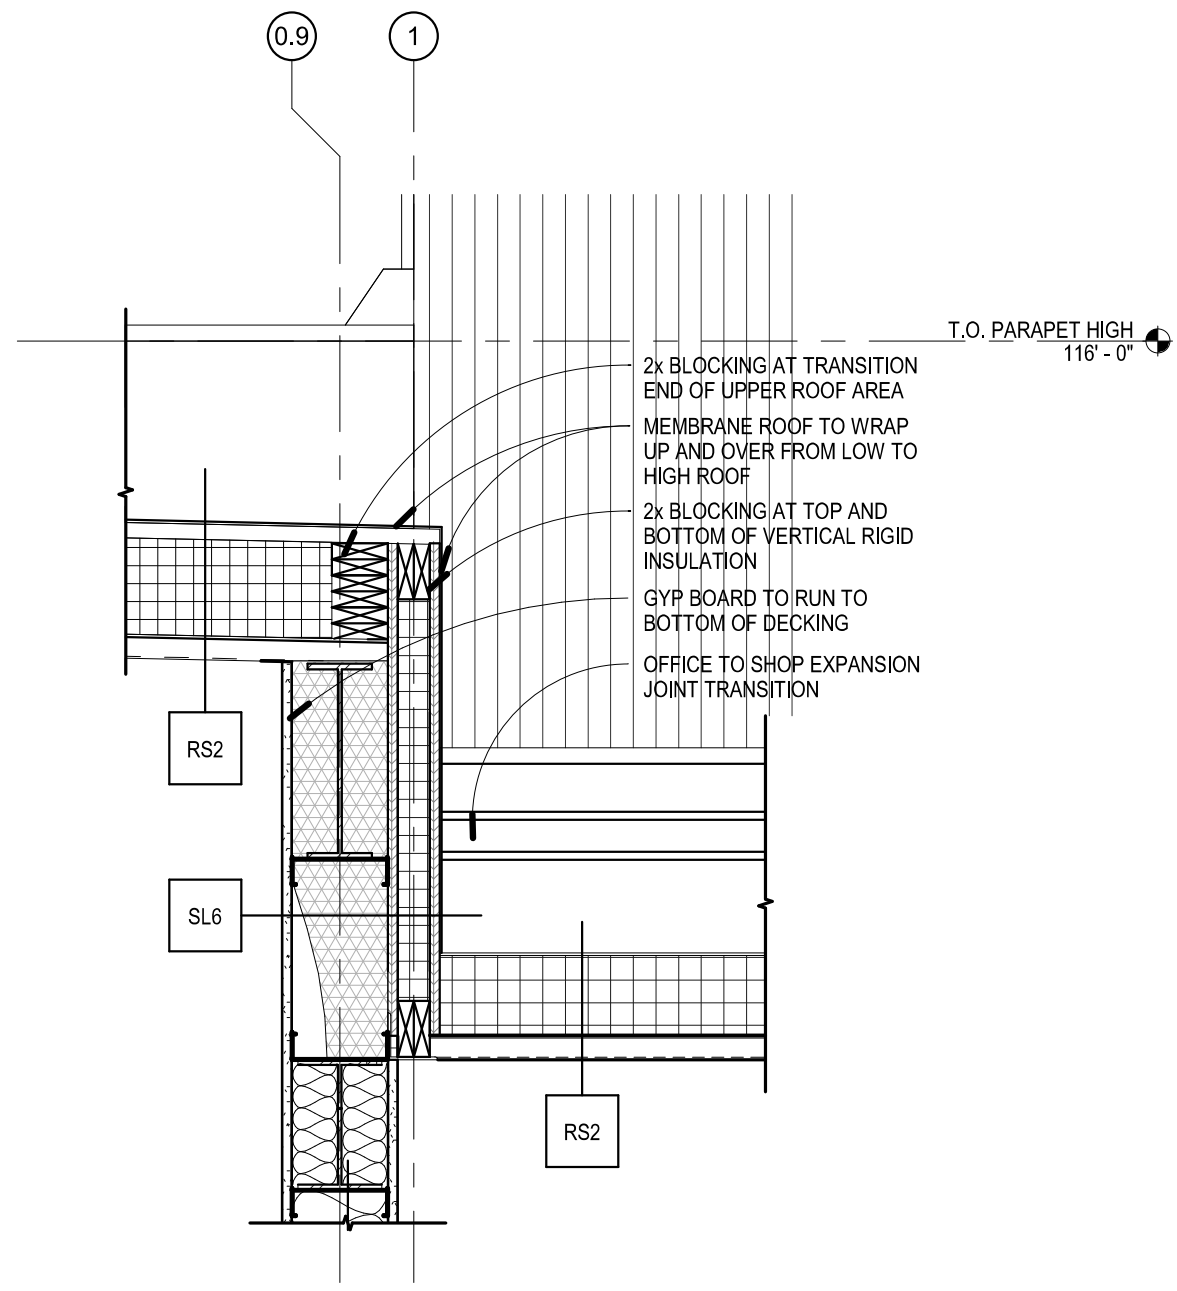


3 A501 Roof High Low Transition
1" = 1'-0"

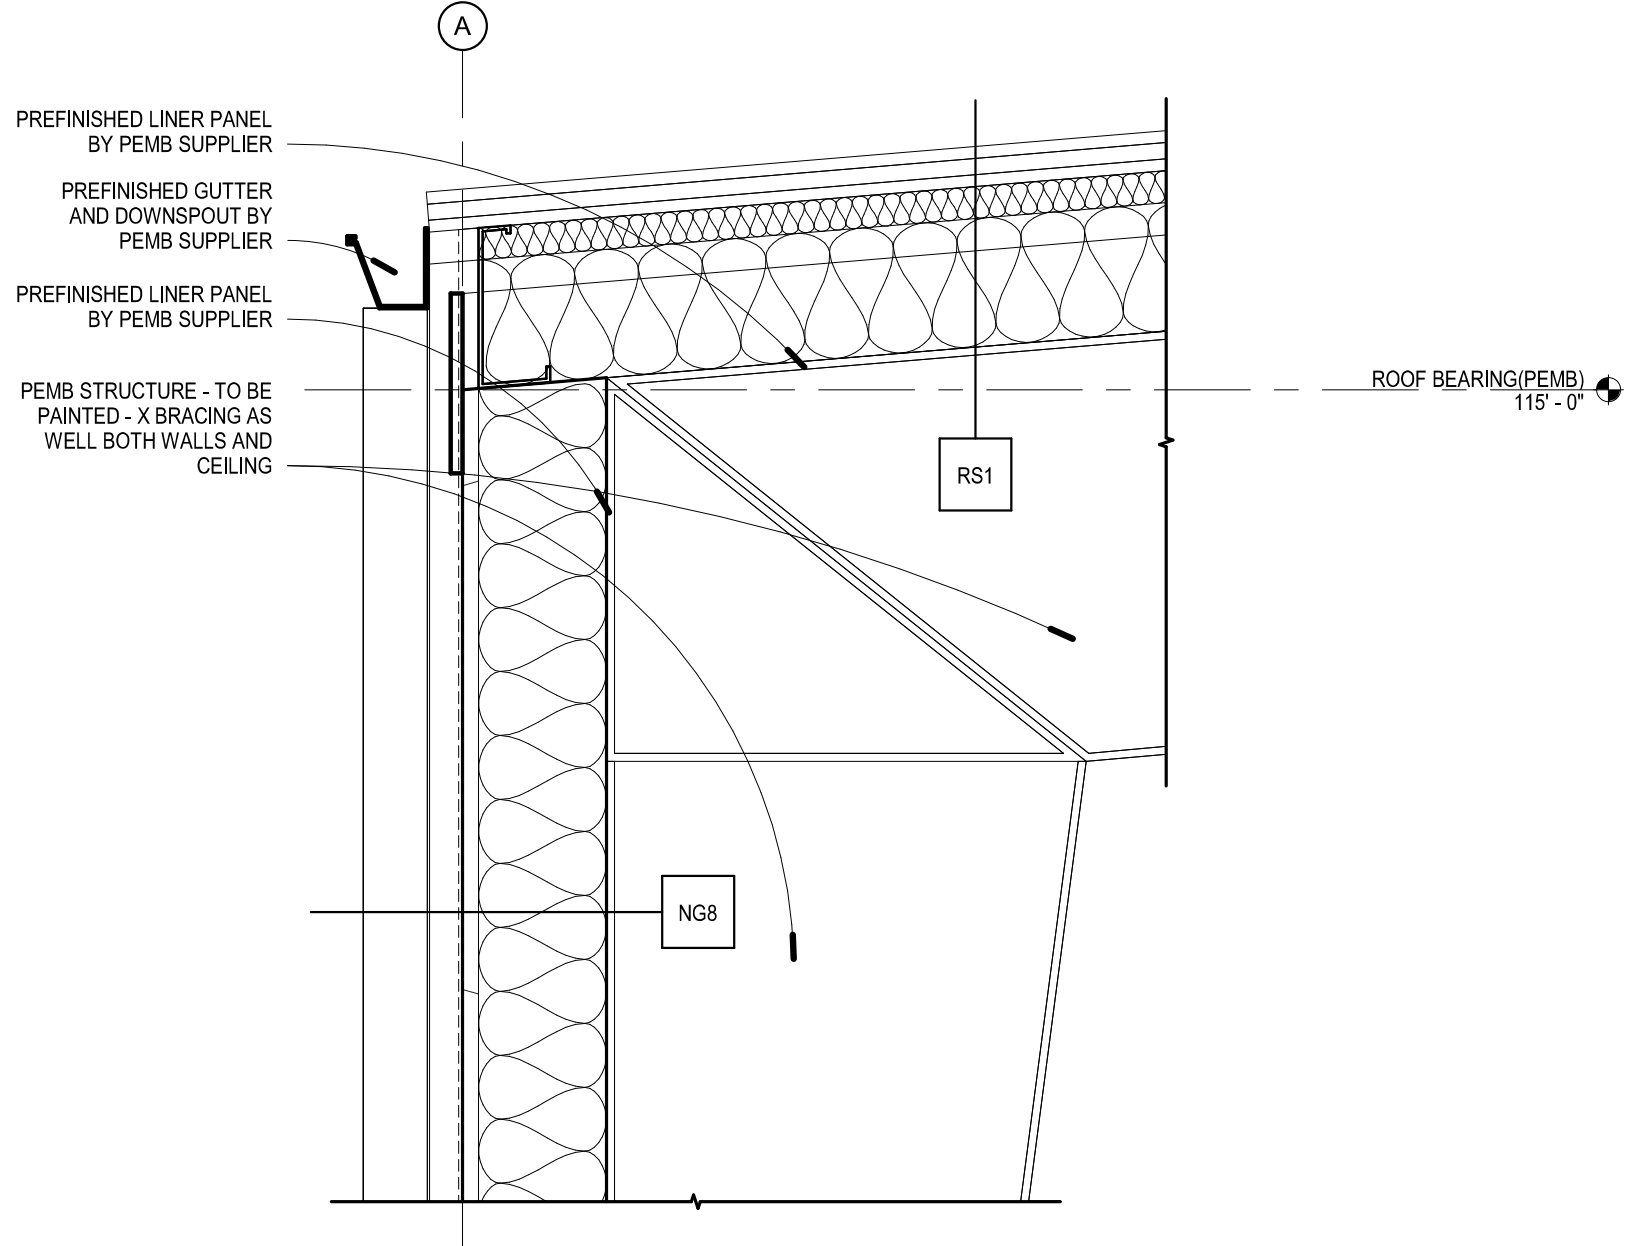


7 A501 PEMB Roof Detail
1" = 1'-0"

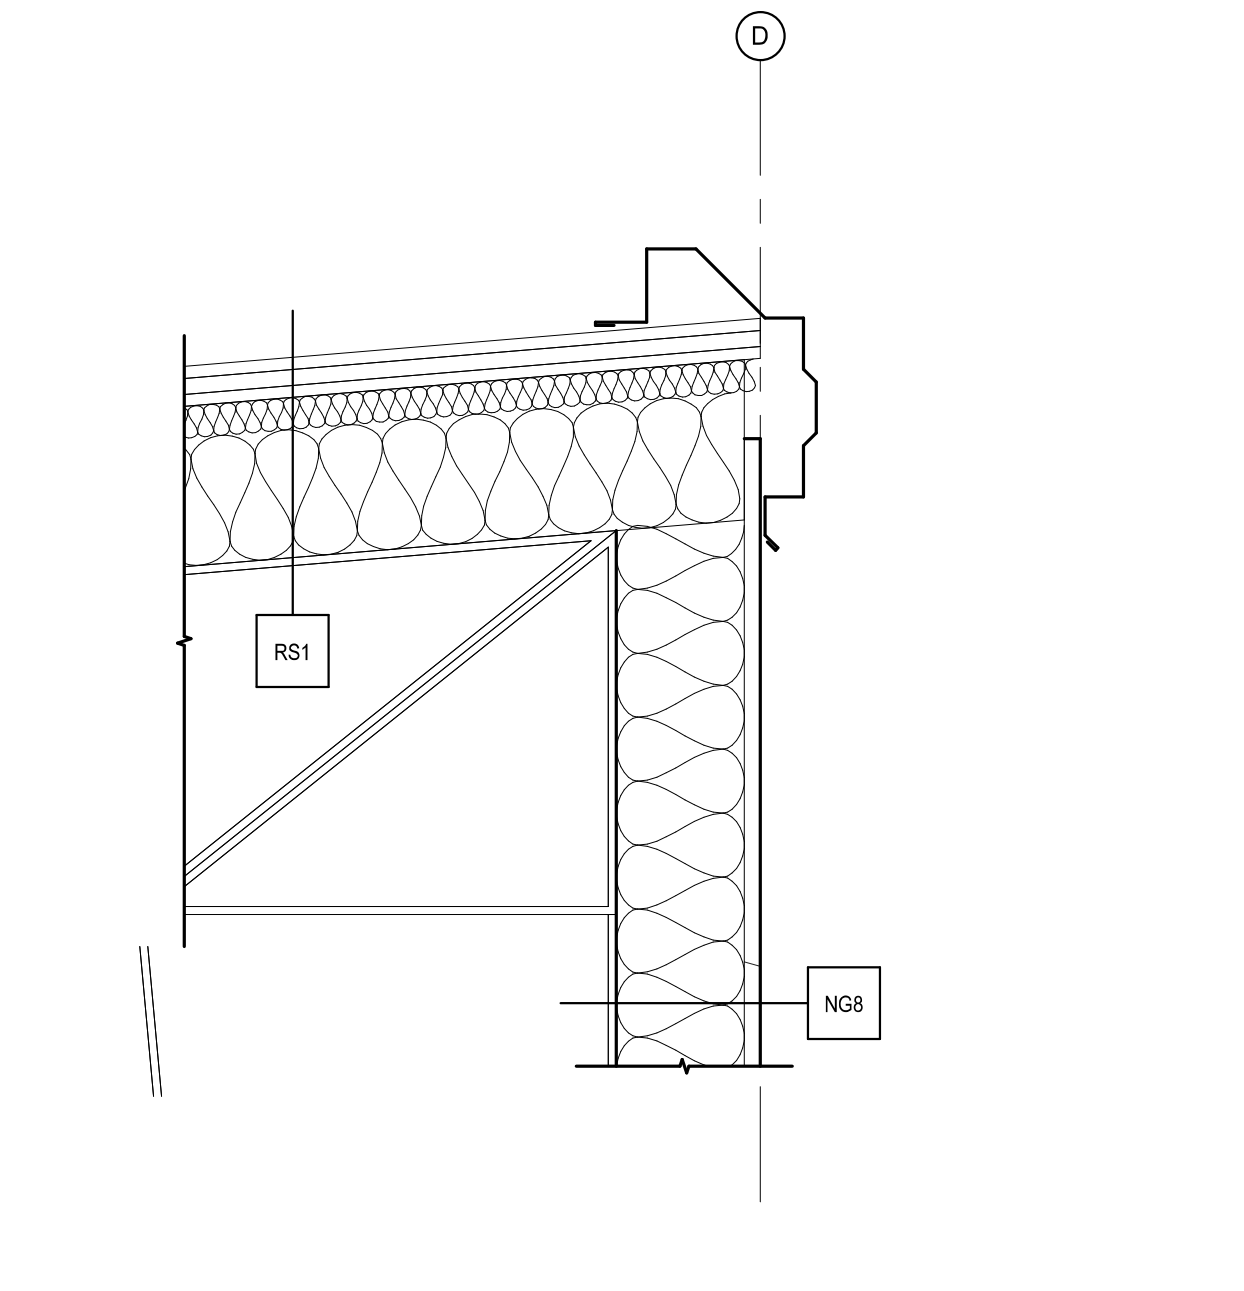


4 A501 PEMB Roof Detail
1" = 1'-0"

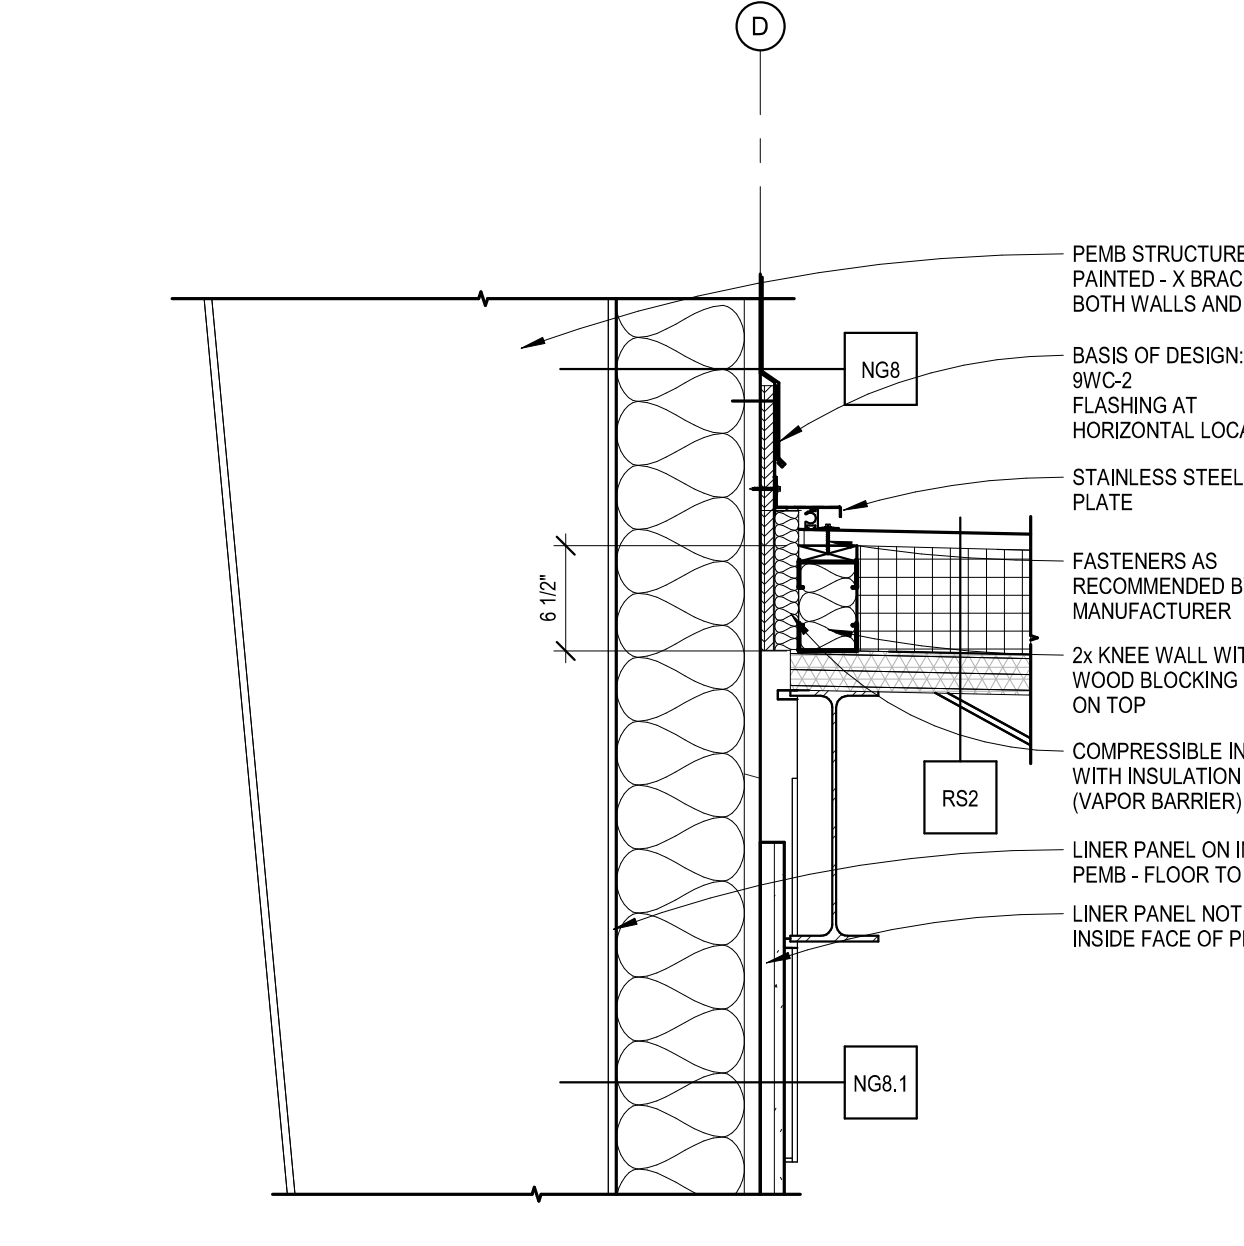


8 A501 Roof PEMB Transition Detail
1" = 1'-0"

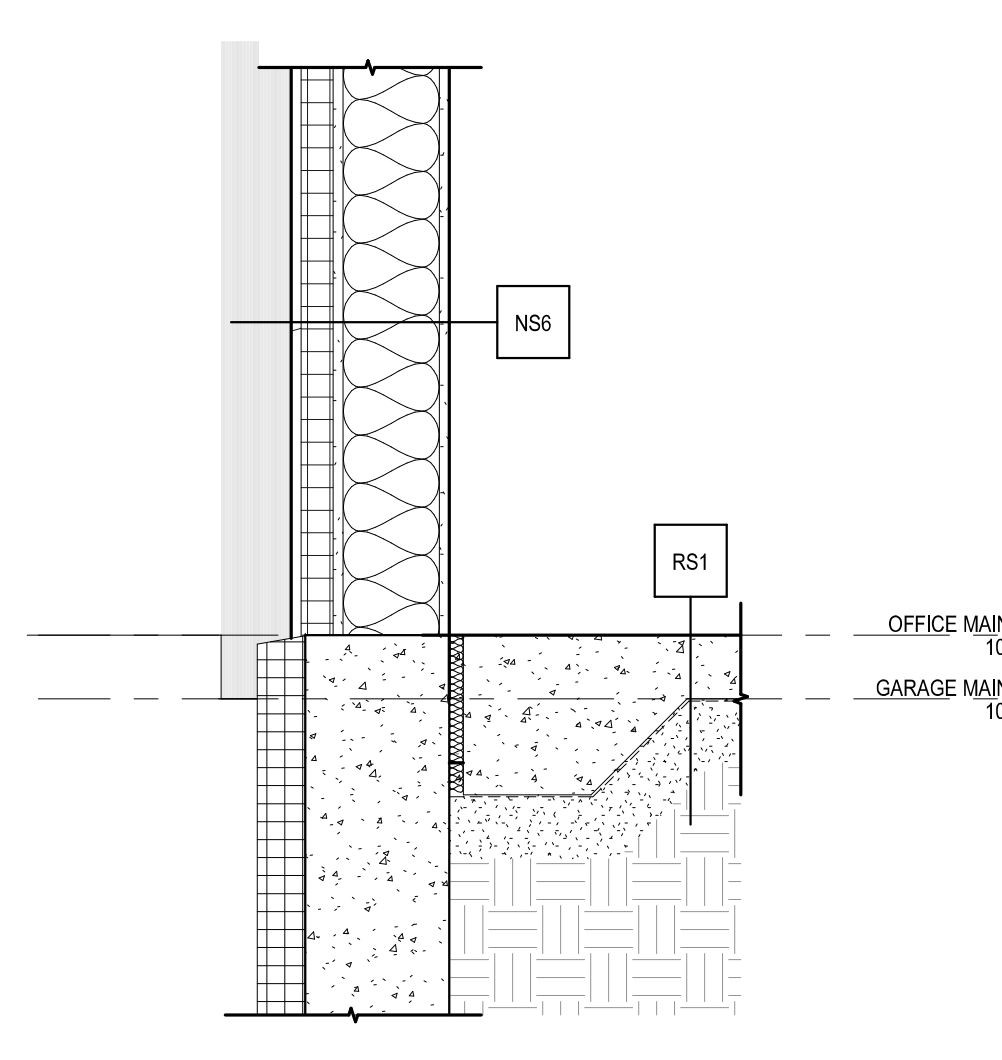


9 A501 Wall Base Detail
1" = 1'-0"

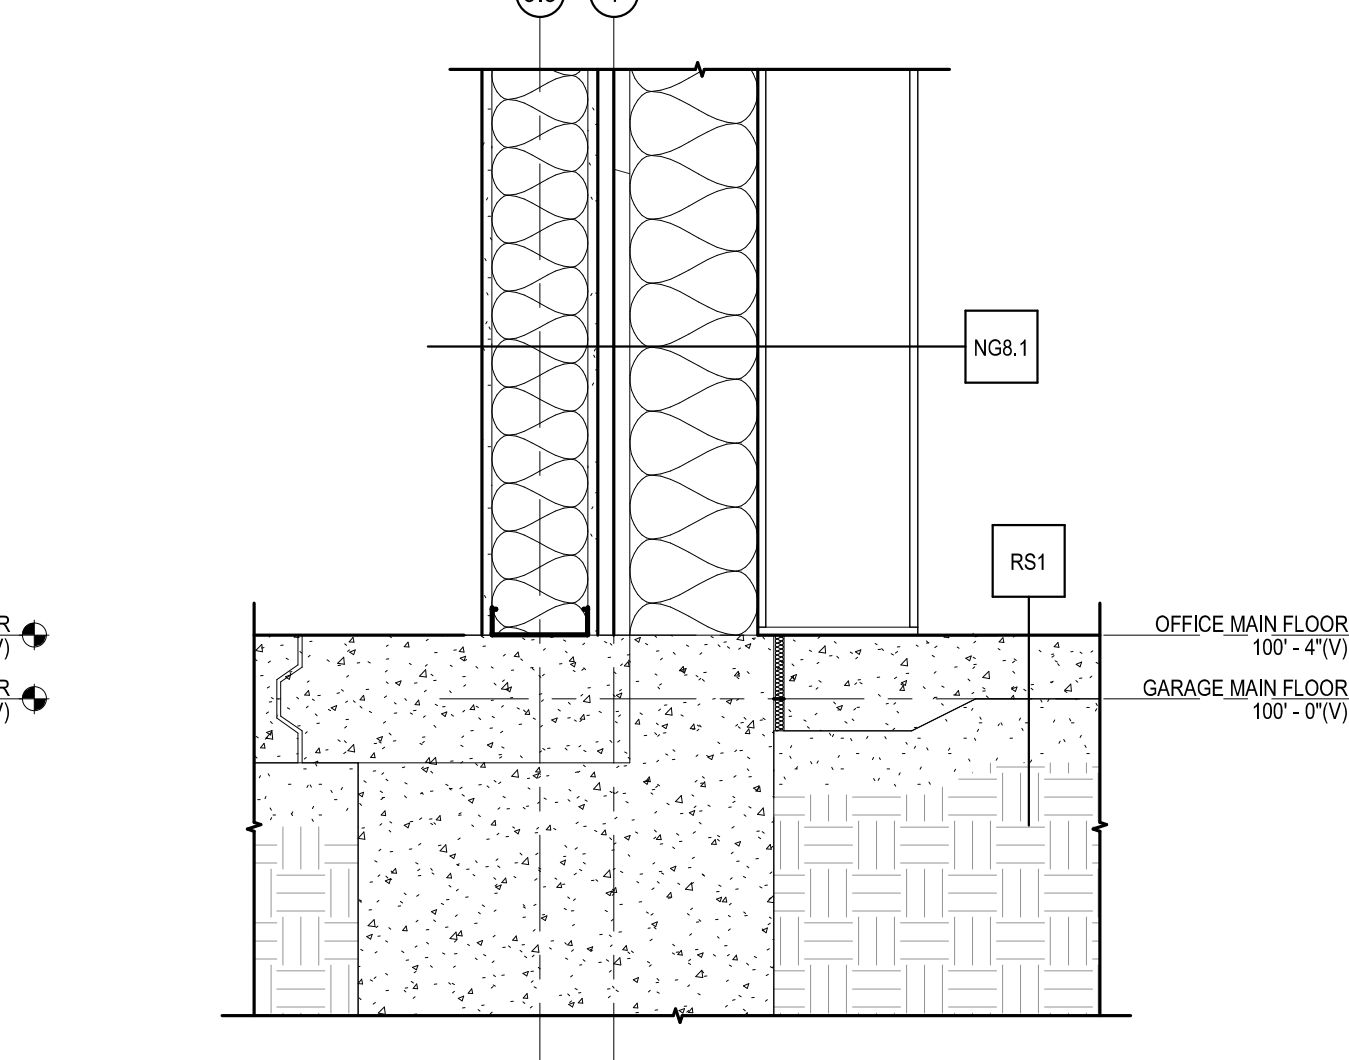

10 A501 Wall Base PEMB to Office Transition Detail
1" = 1'-0"

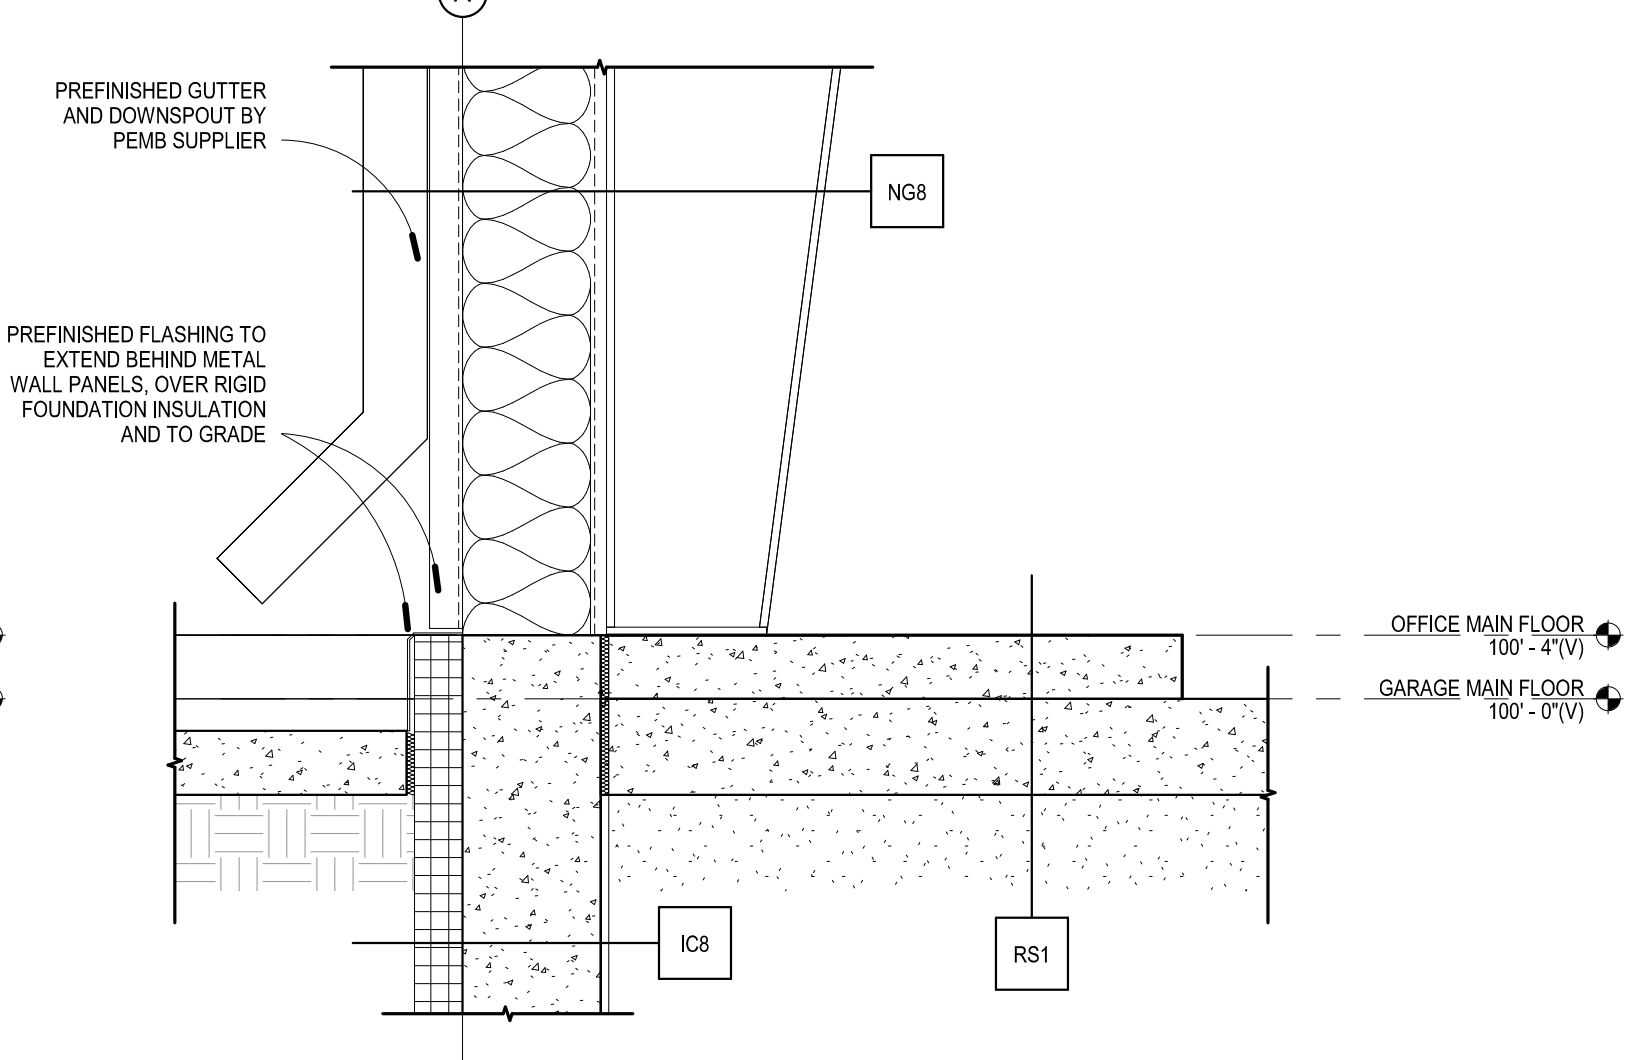

11 A501 PEMB Base Detail
1" = 1'-0"

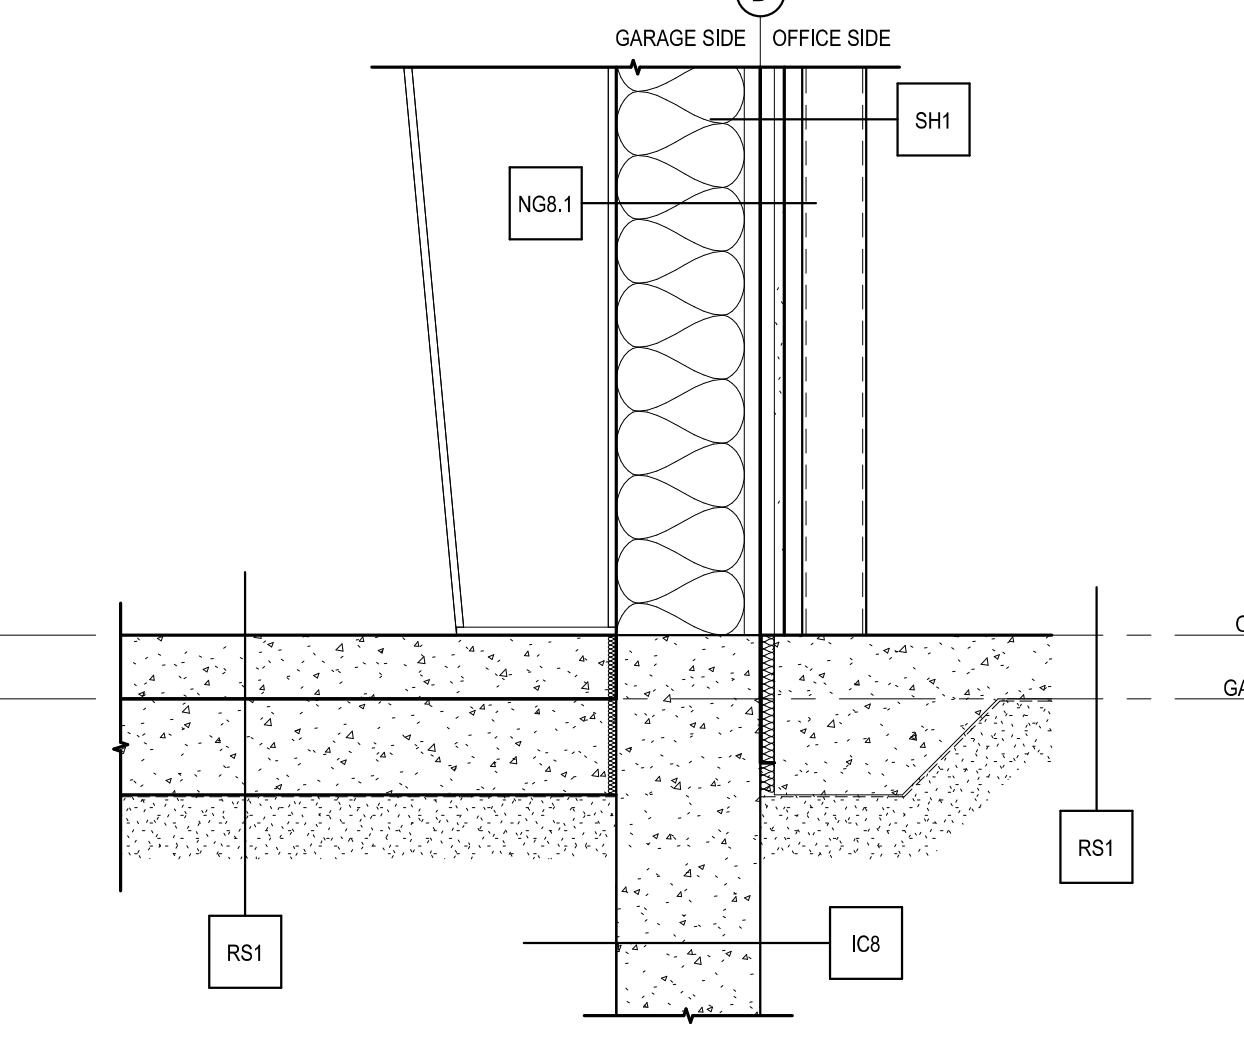

12 A501 PEMB Base Transition Detail
1" = 1'-0"

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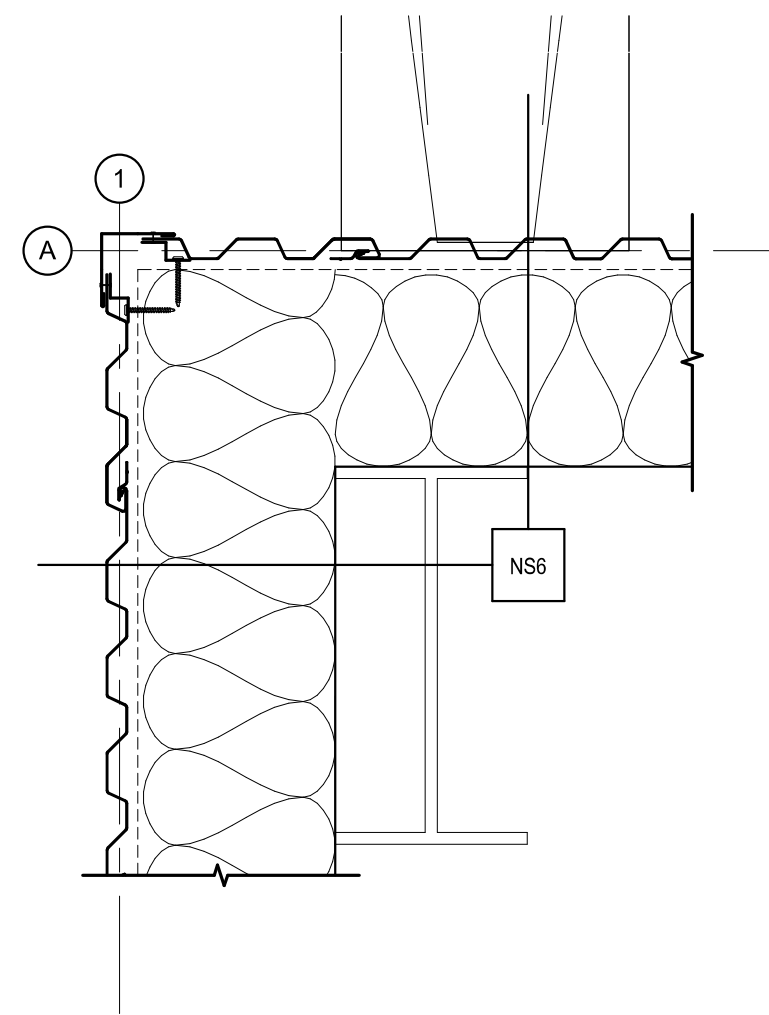
DRAWN BY: Author

JN: 24-054


Plan Details

SHEET


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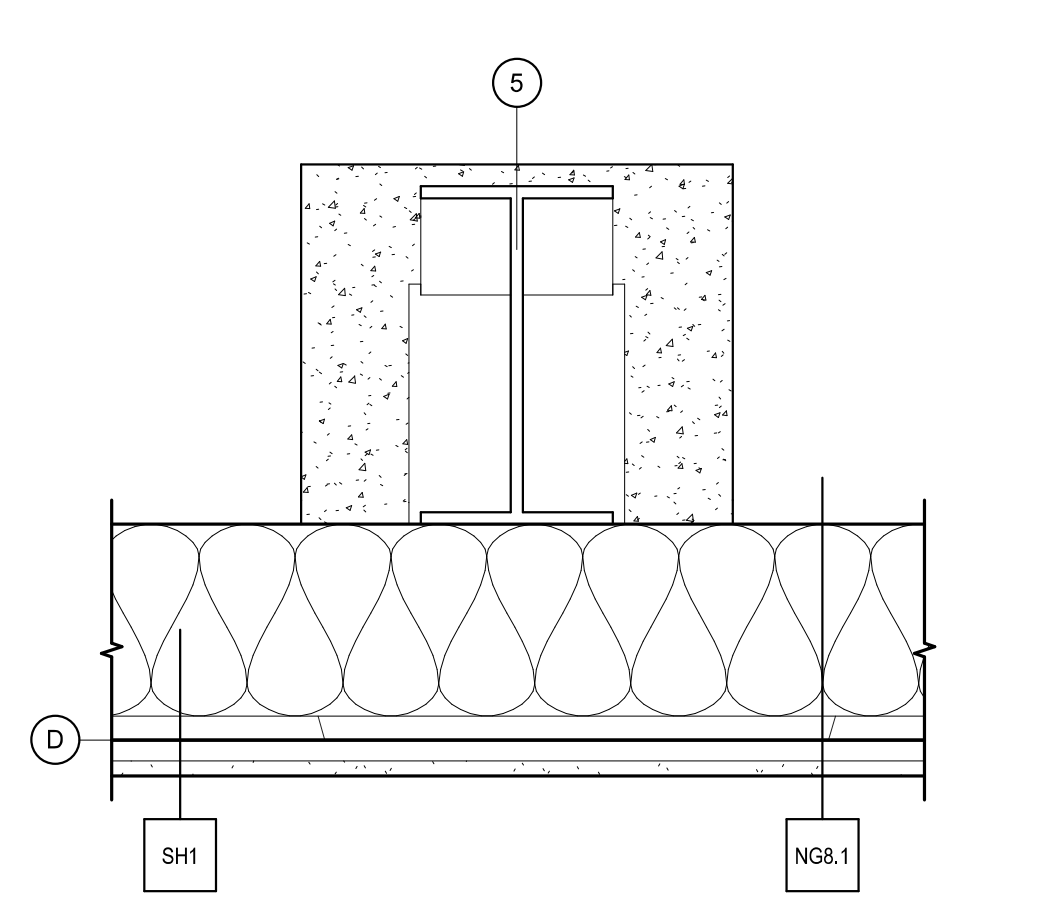
1 A511 Plan Detail
1 1/2" = 1'-0"




2 A511 Plan Detail
1 1/2" = 1'-0"

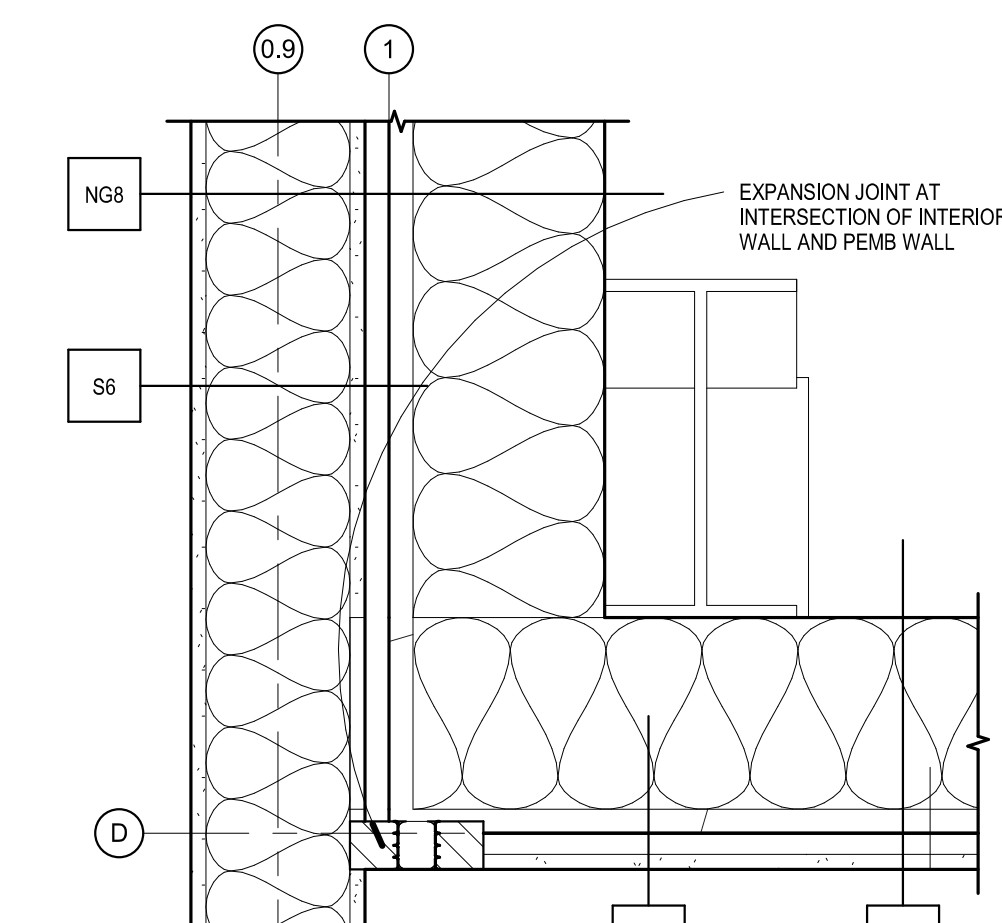


3 A511 Plan Detail
1 1/2" = 1'-0"

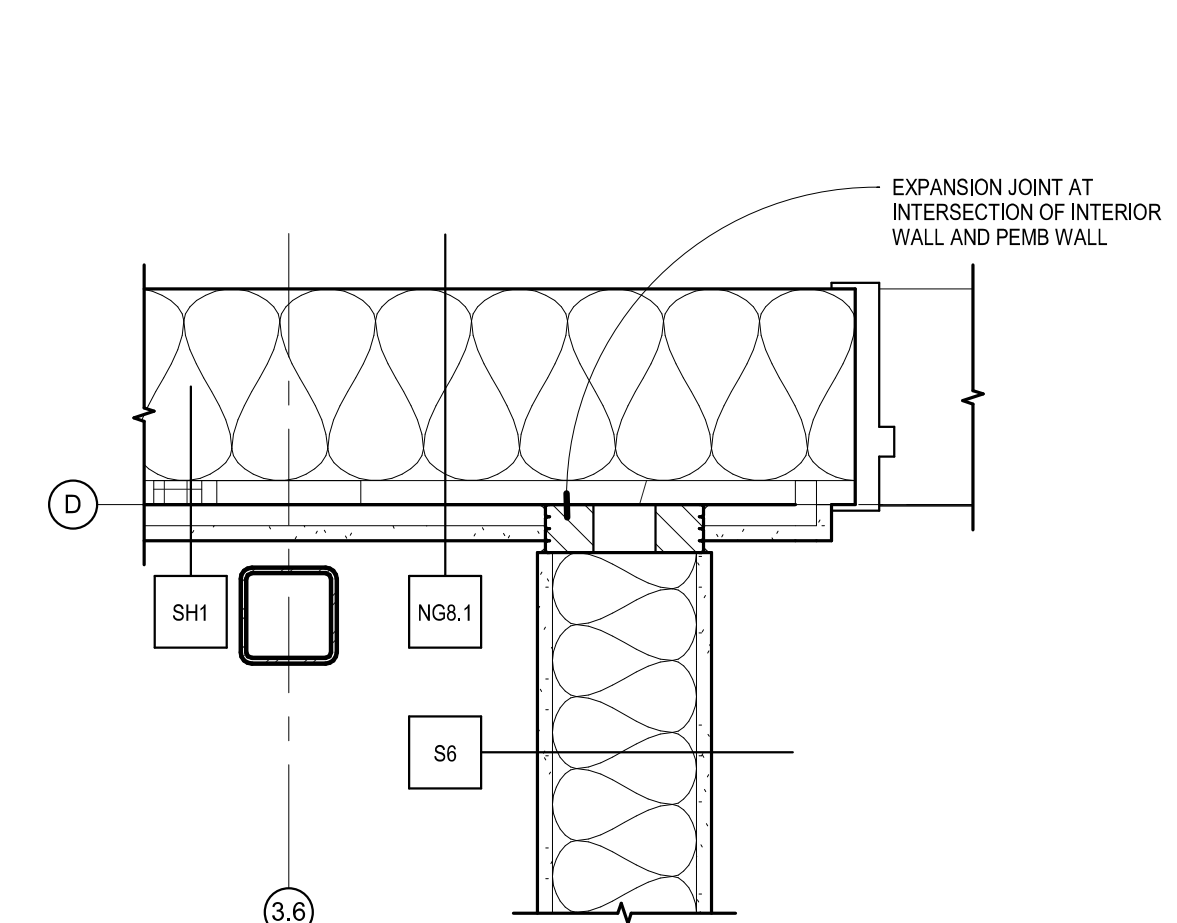


4 A511 Plan Detail
1 1/2" = 1'-0"

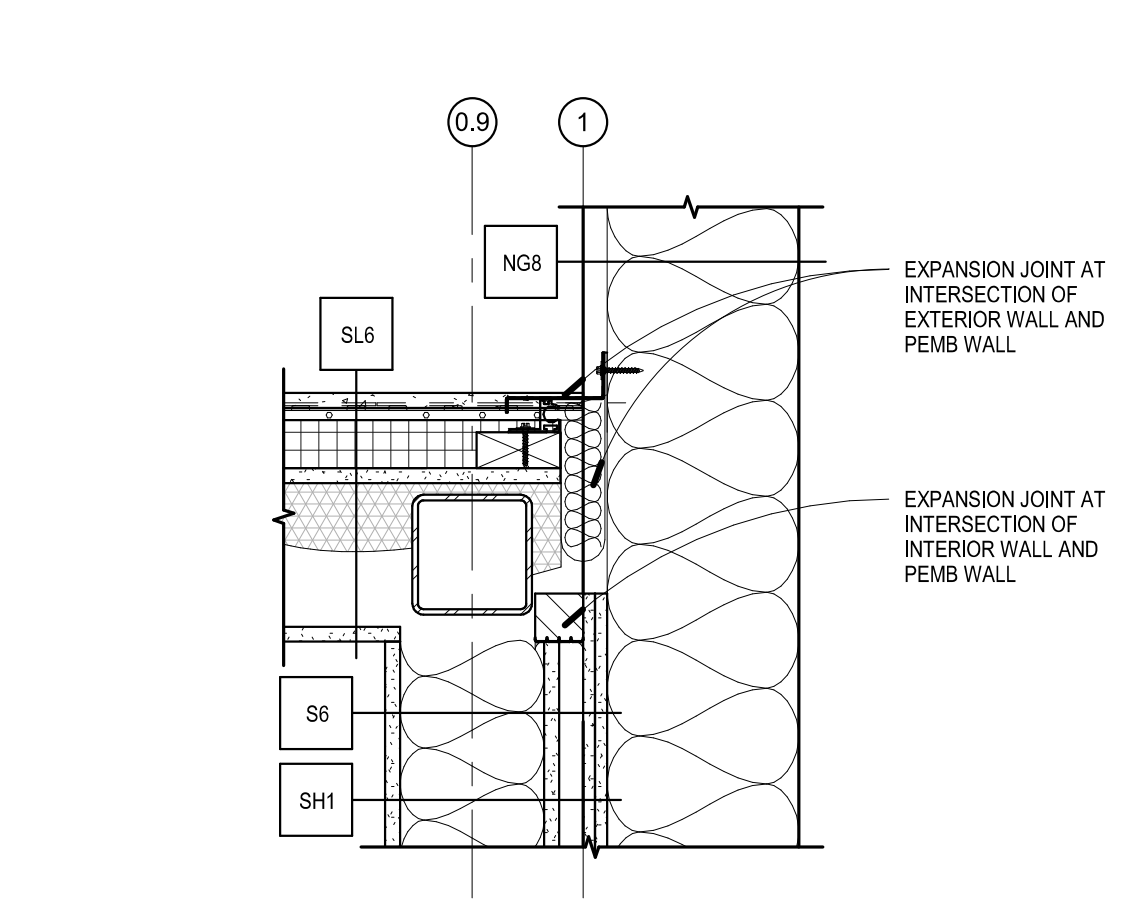


5 A511 Plan Detail
1 1/2" = 1'-0"

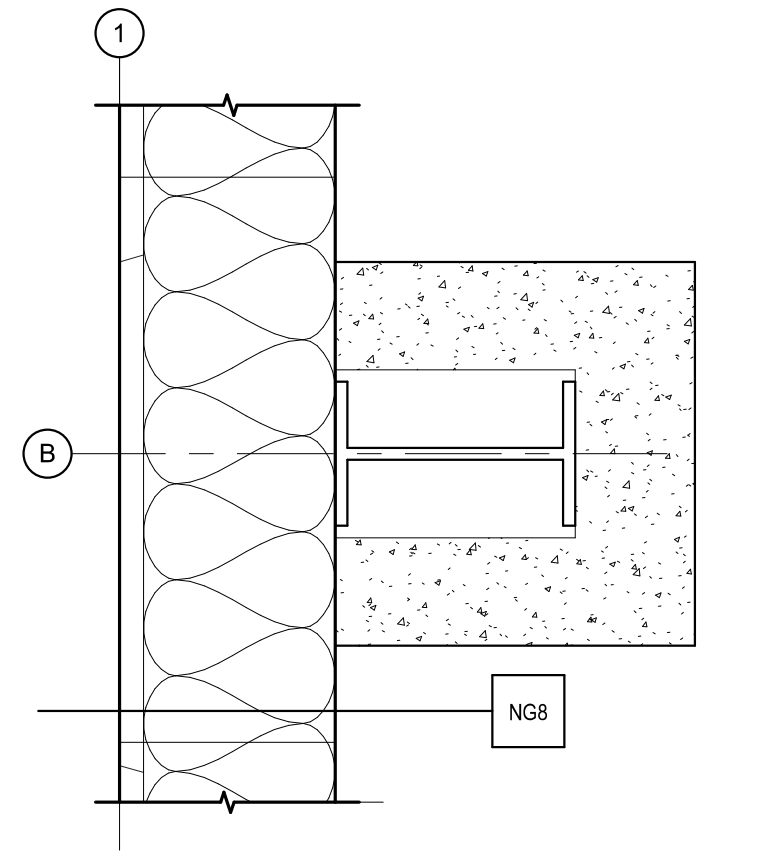


6 A511 Plan Detail
1 1/2" = 1'-0"

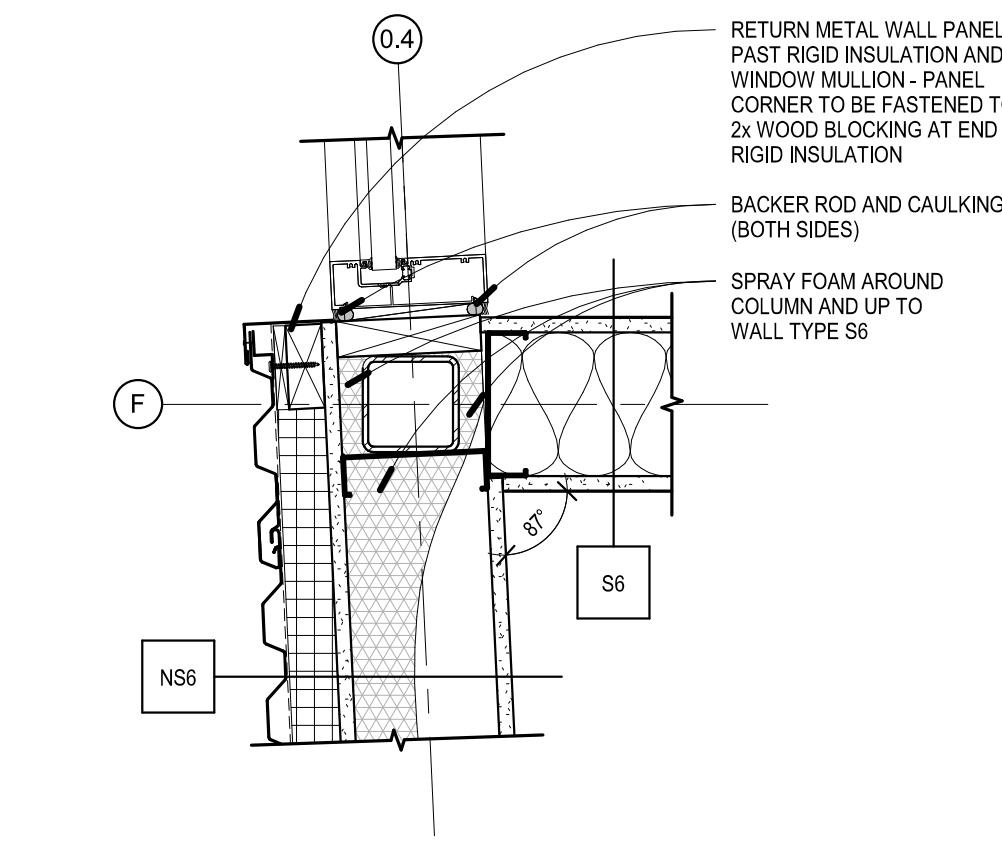


7 A511 Plan Detail
1 1/2" = 1'-0"

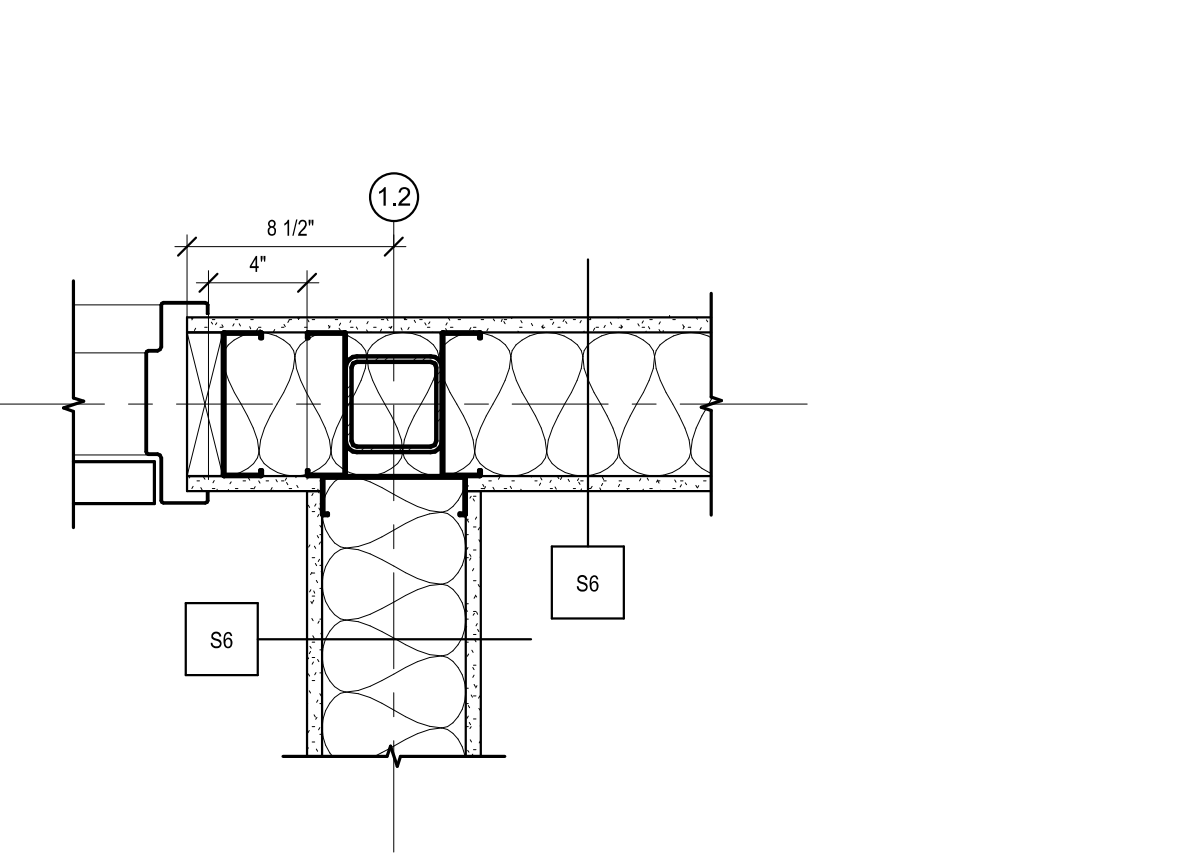


8 A511 Plan Detail
1 1/2" = 1'-0"

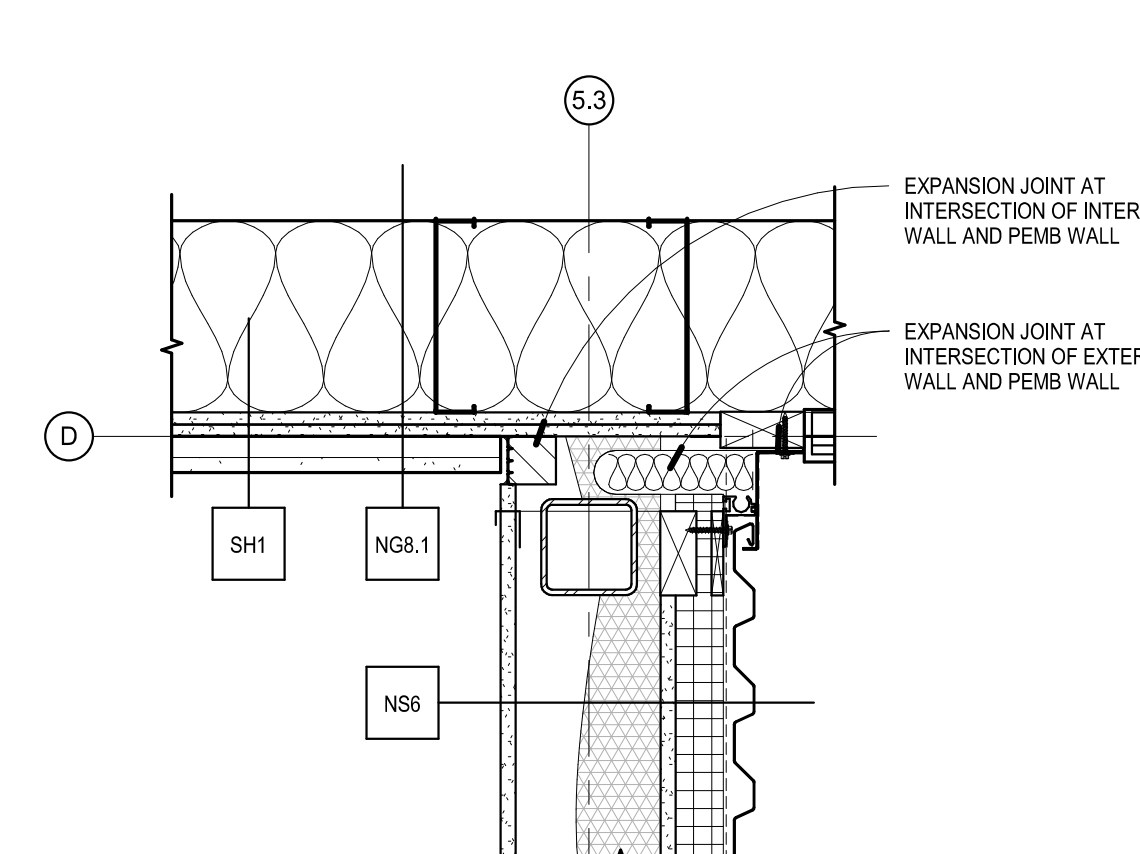


9 A511 Plan Detail
1 1/2" = 1'-0"

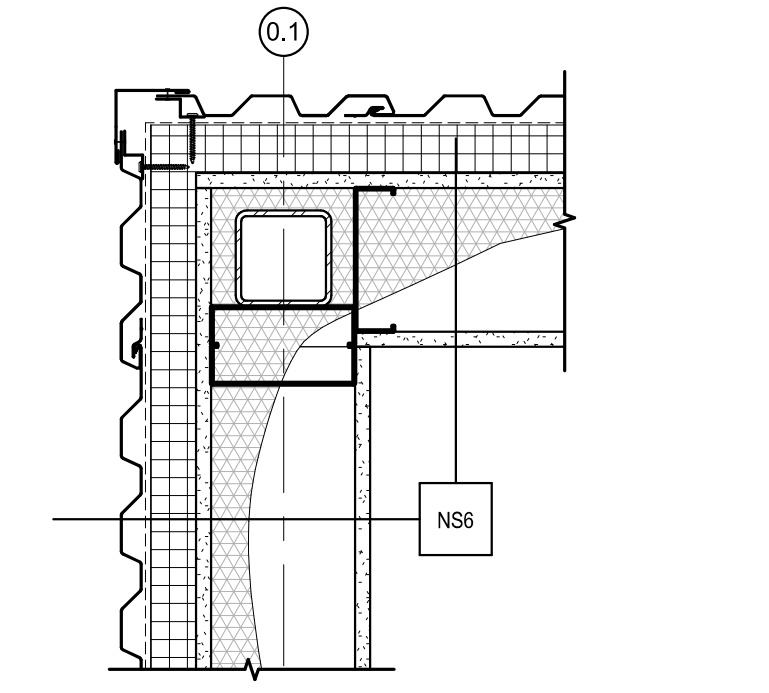


10 A511 Plan Detail
1 1/2" = 1'-0"

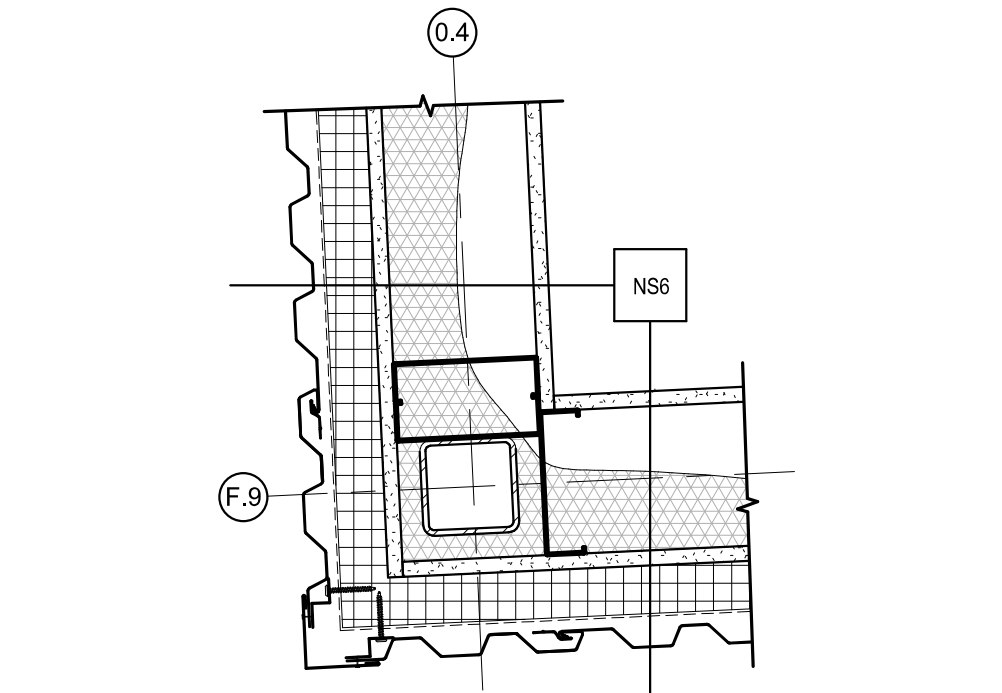


11 A511 Plan Detail
1 1/2" = 1'-0"

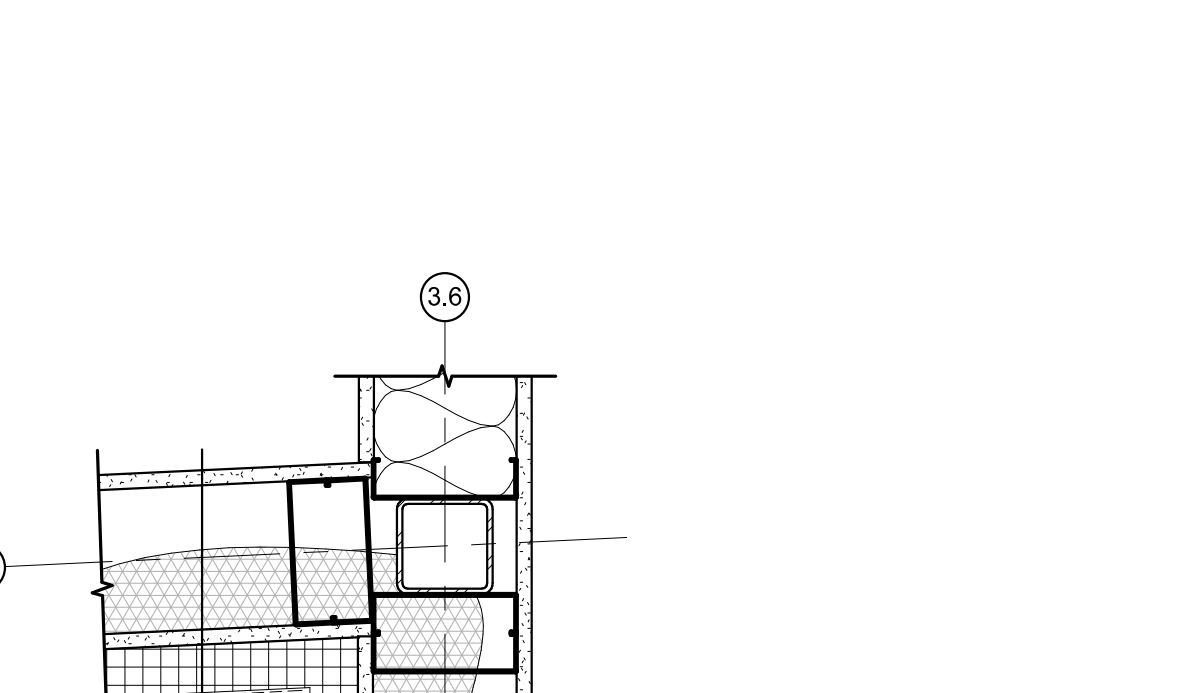


12 A511 Plan Detail
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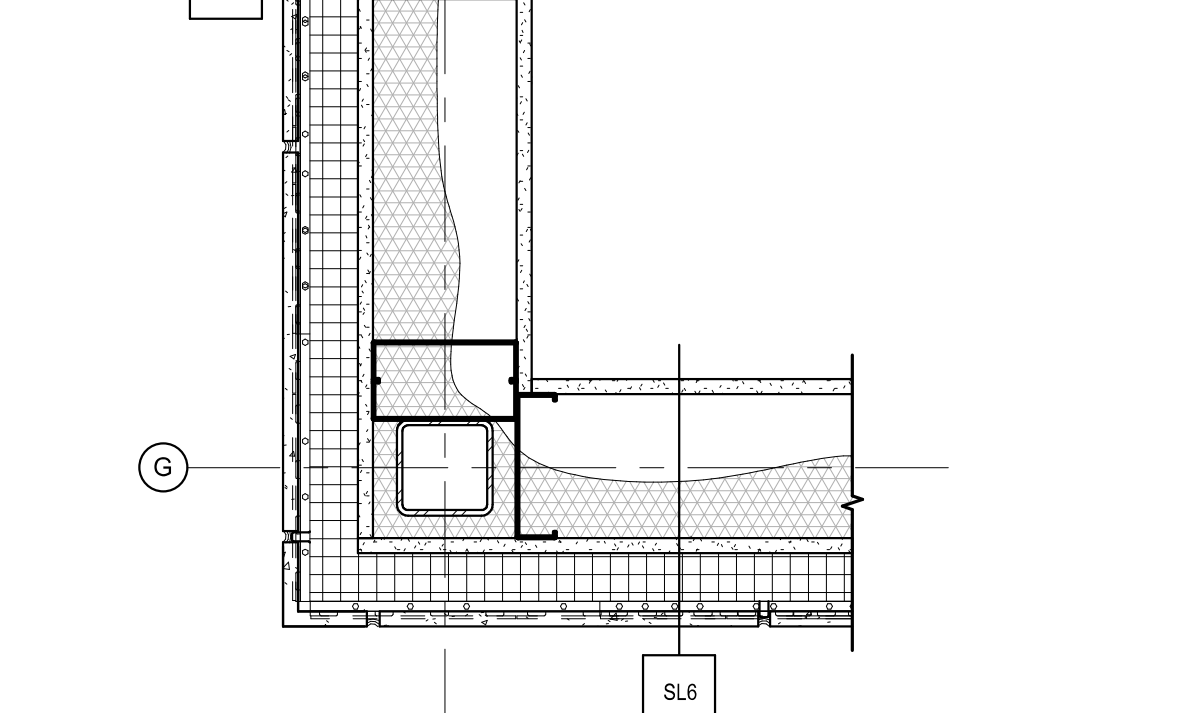
13 A511 Plan Detail
1 1/2" = 1'-0"

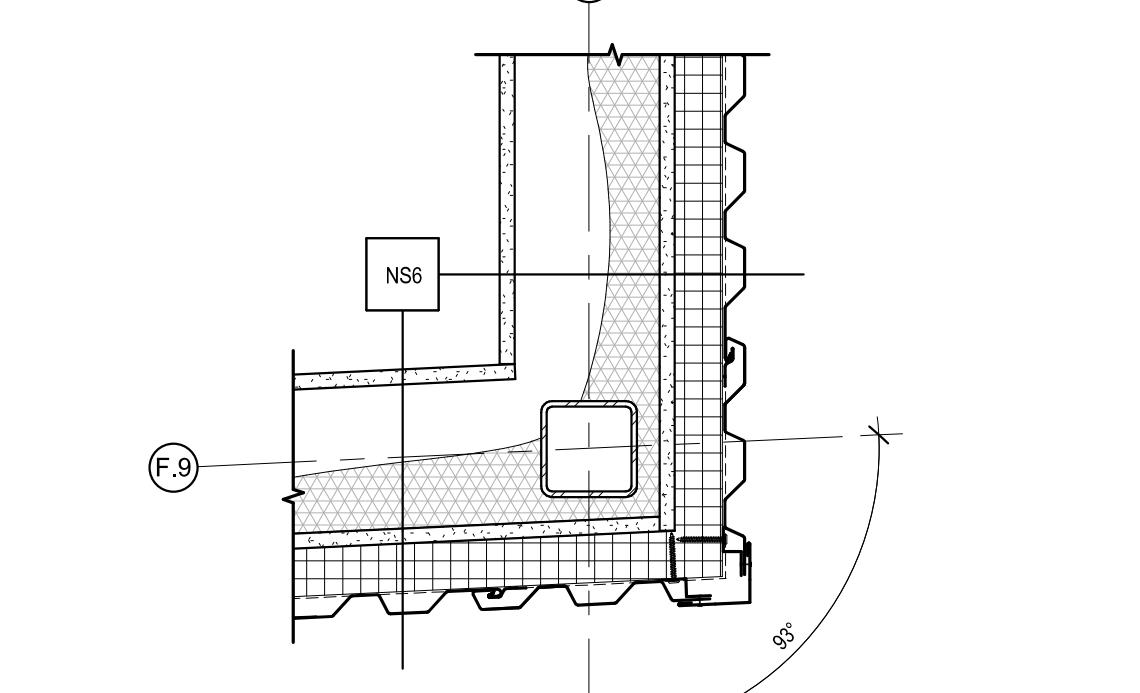


13 A511 Plan Detail
1 1/2" = 1'-0"

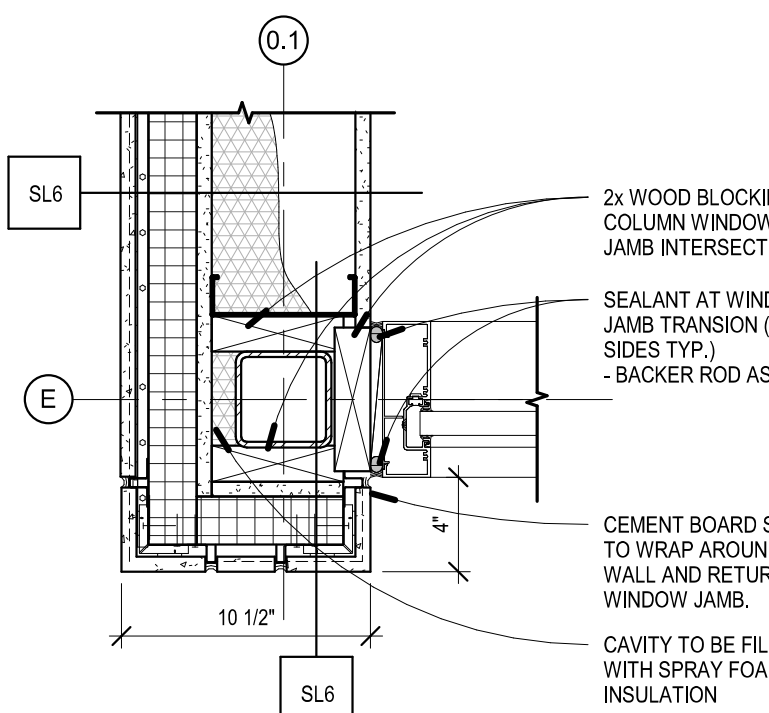

14 A511 Plan Detail
1 1/2" = 1'-0"

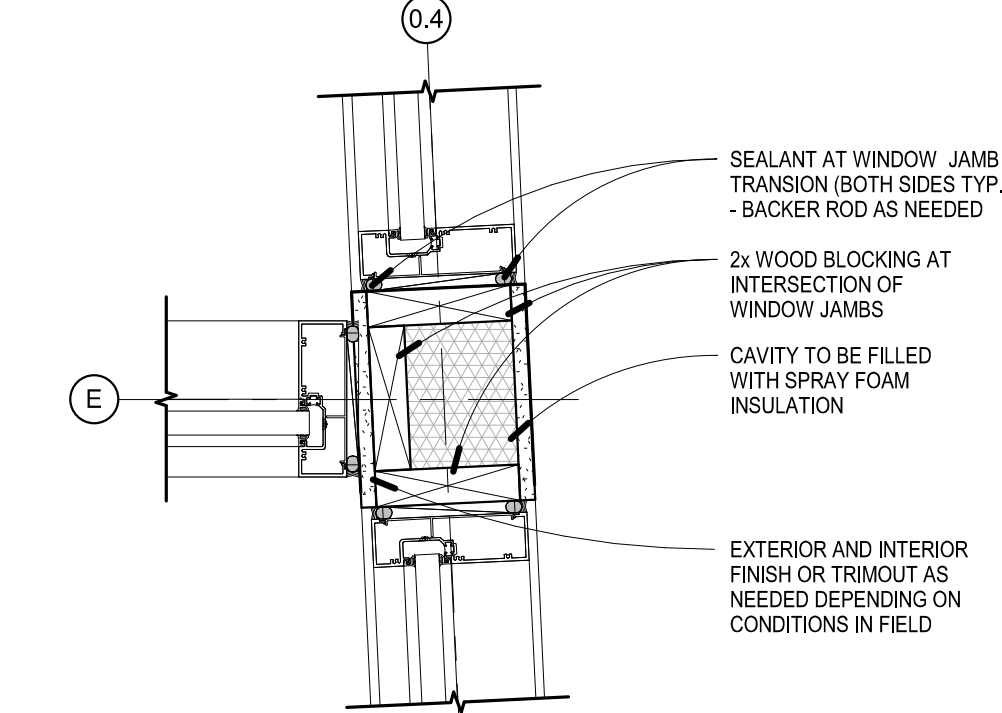

15 A511 Plan Detail
1 1/2" = 1'-0"

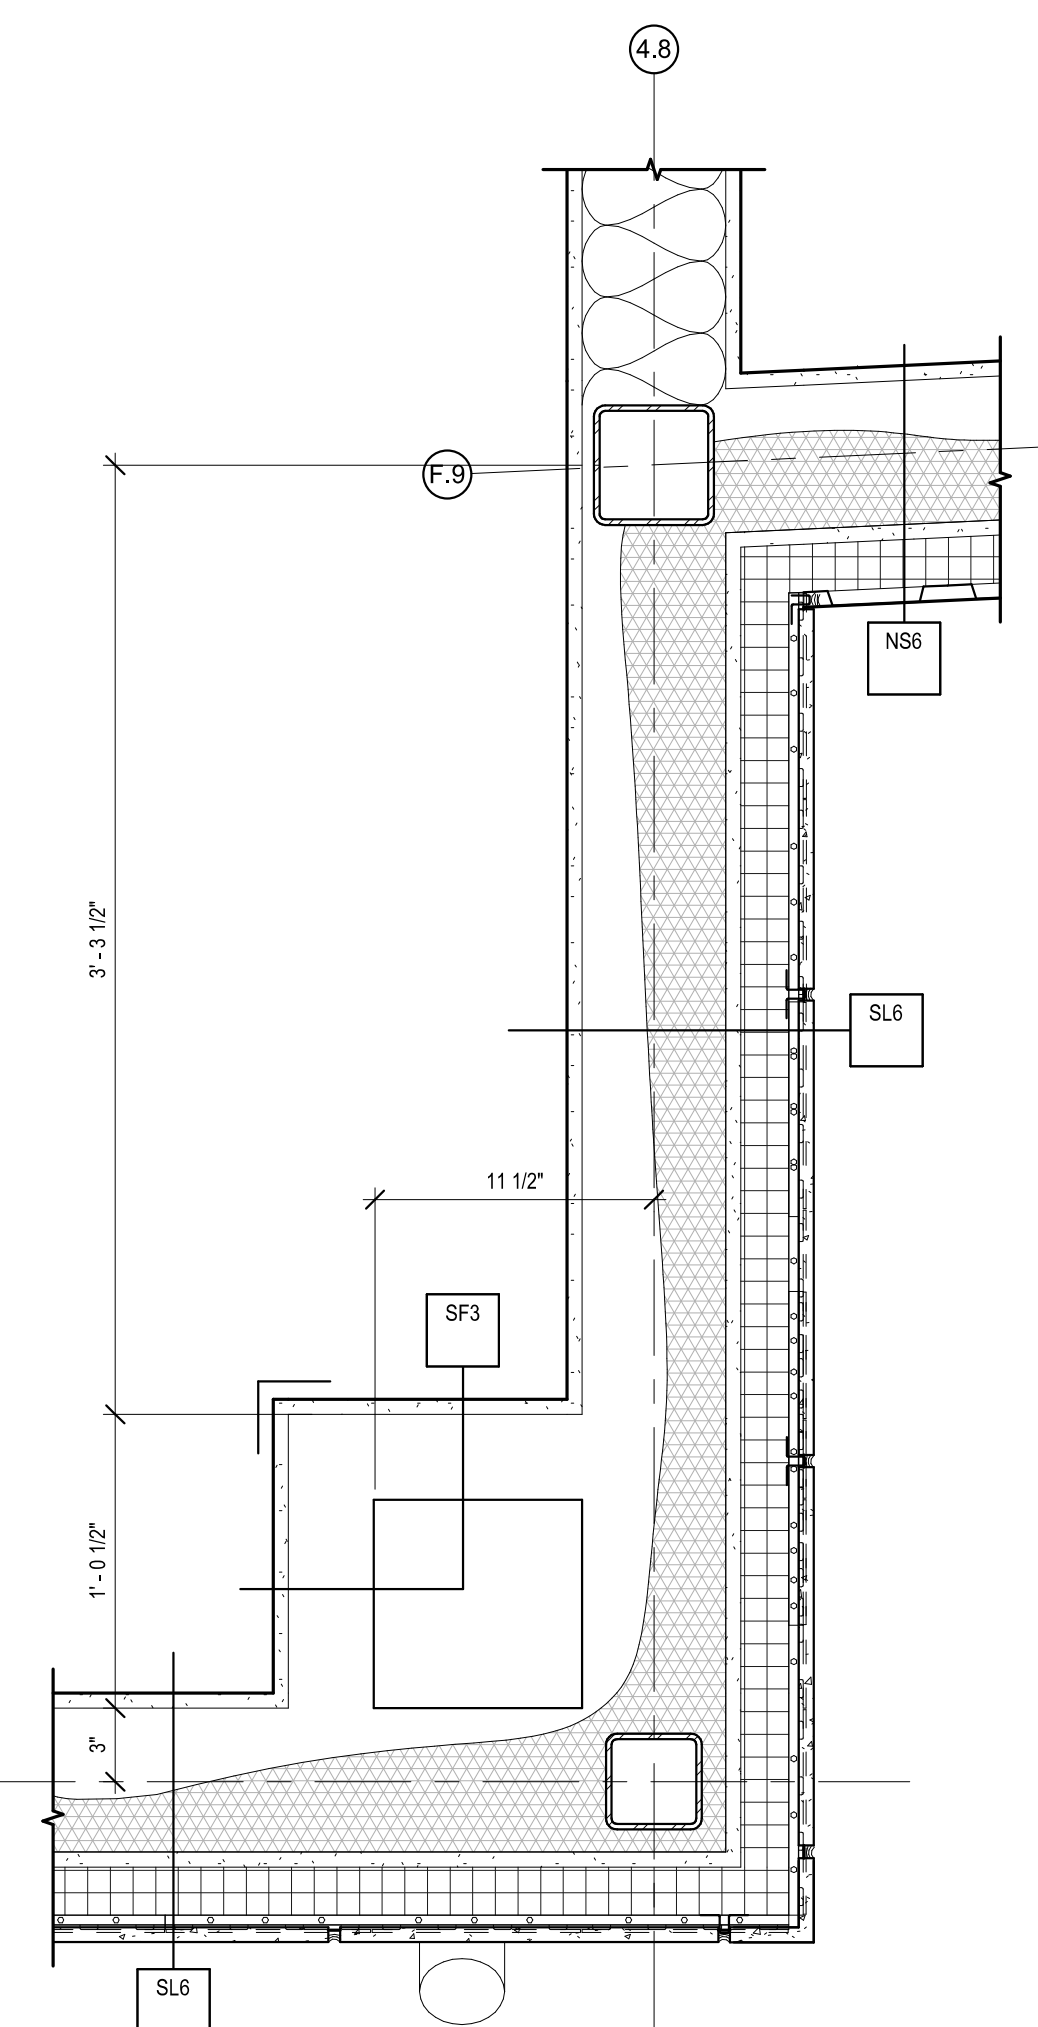

16 A511 Plan Detail
1 1/2" = 1'-0"

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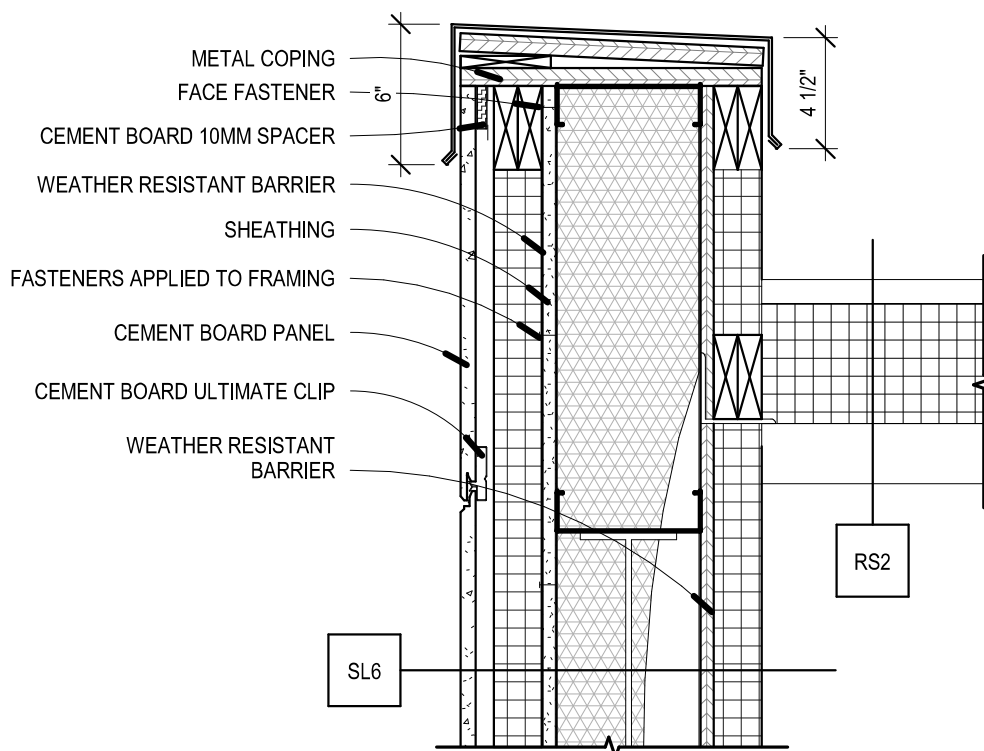
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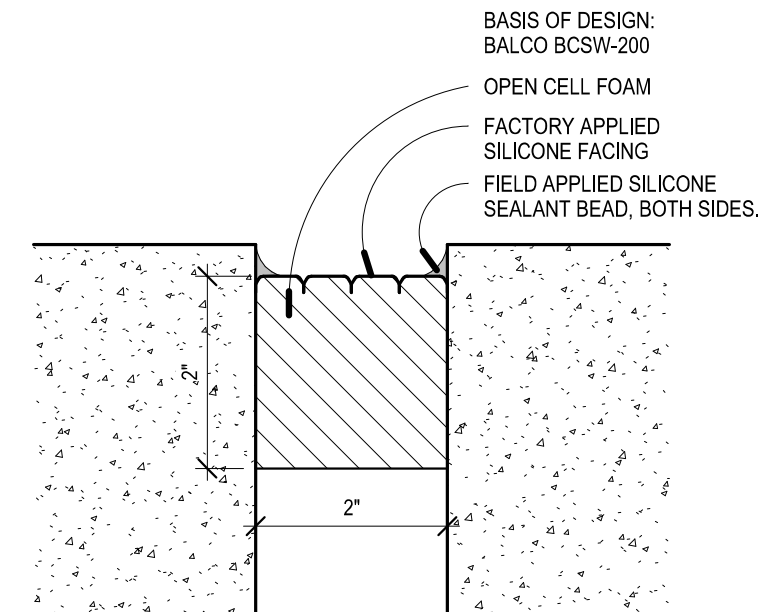
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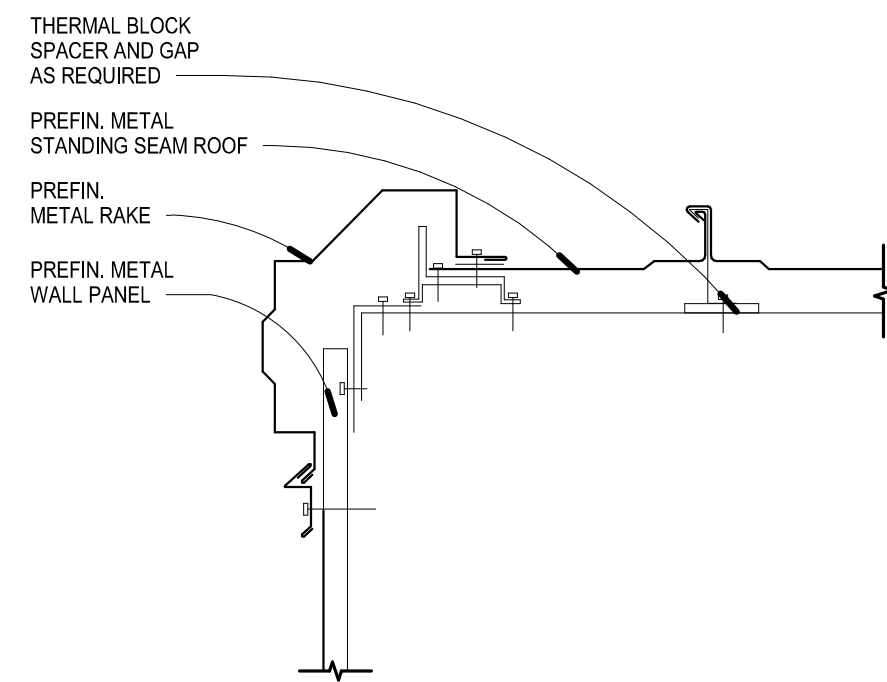
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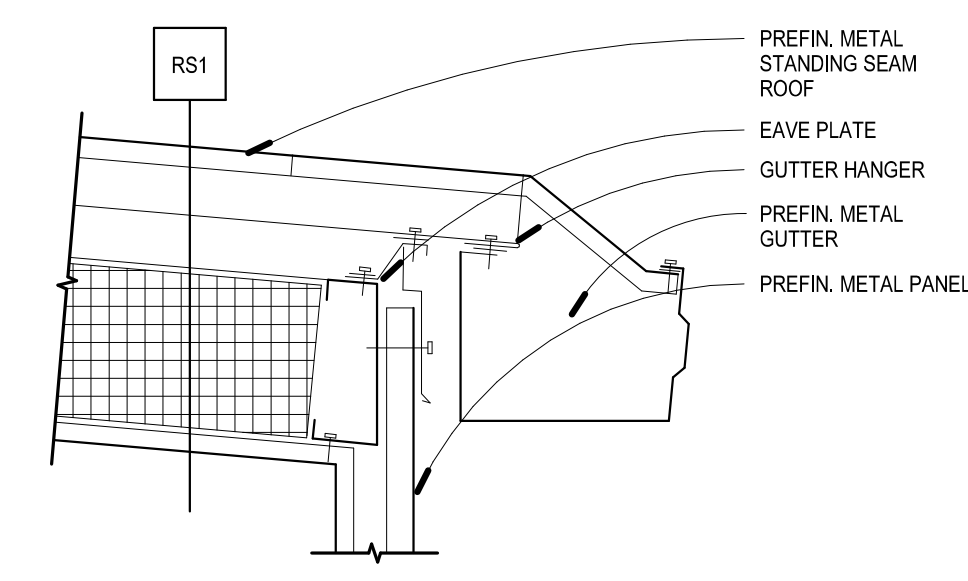
1 A520 Cement Board Parapet
1 1/2" = 1'-0"




2 A520 Expansion Joint at Interior Walls
6" = 1'-0"




3 A520 Typ. PEMB Rake Detail
1 1/2" = 1'-0"




4 A520 PEMB Typ. Gutter Detail
1 1/2" = 1'-0"

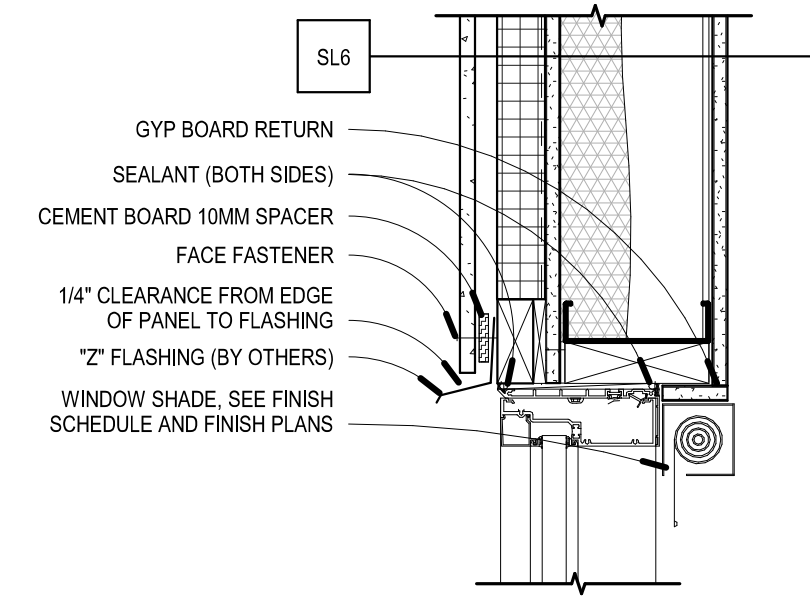


5 A520 Cement Board Window Head Detail
1 1/2" = 1'-0"

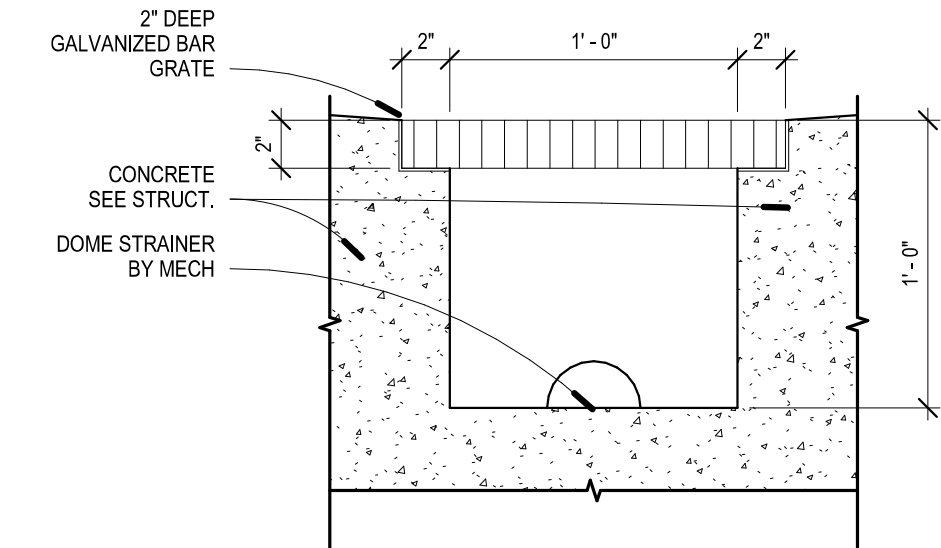


6 A520 Garage Trench Drain Detail
1 1/2" = 1'-0"

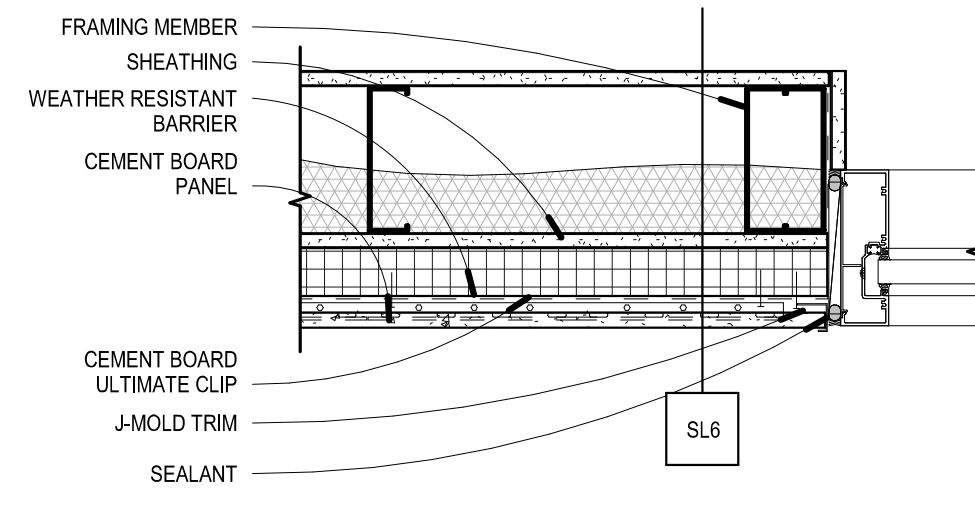


7 A520 Cement Board Window Jamb
1 1/2" = 1'-0"

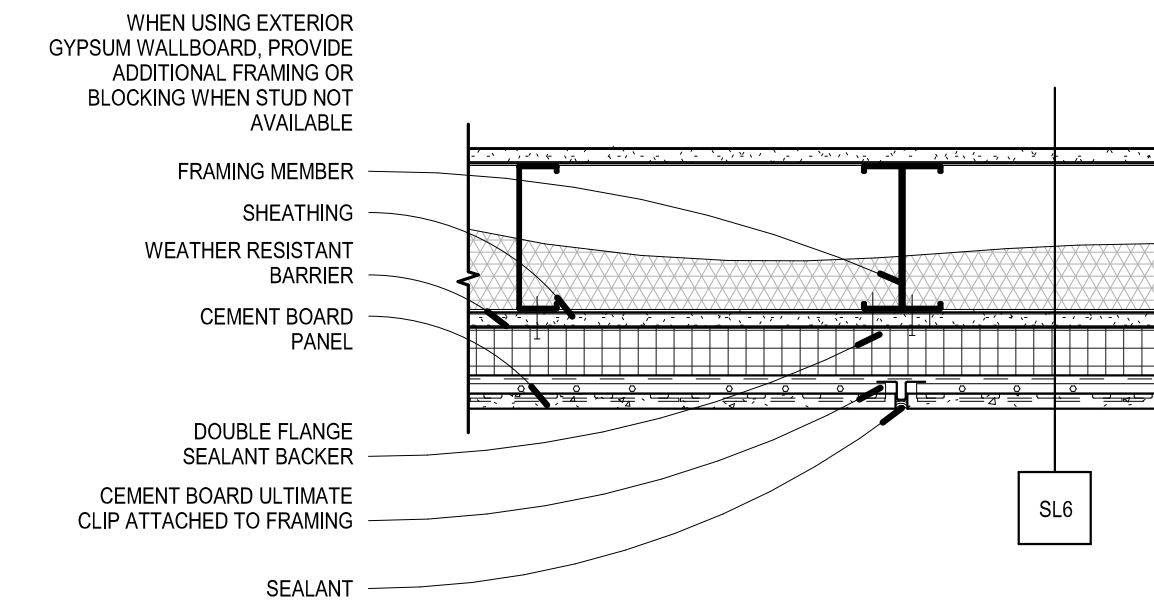


8 A520 Cement Board Expansion Joint
1 1/2" = 1'-0"

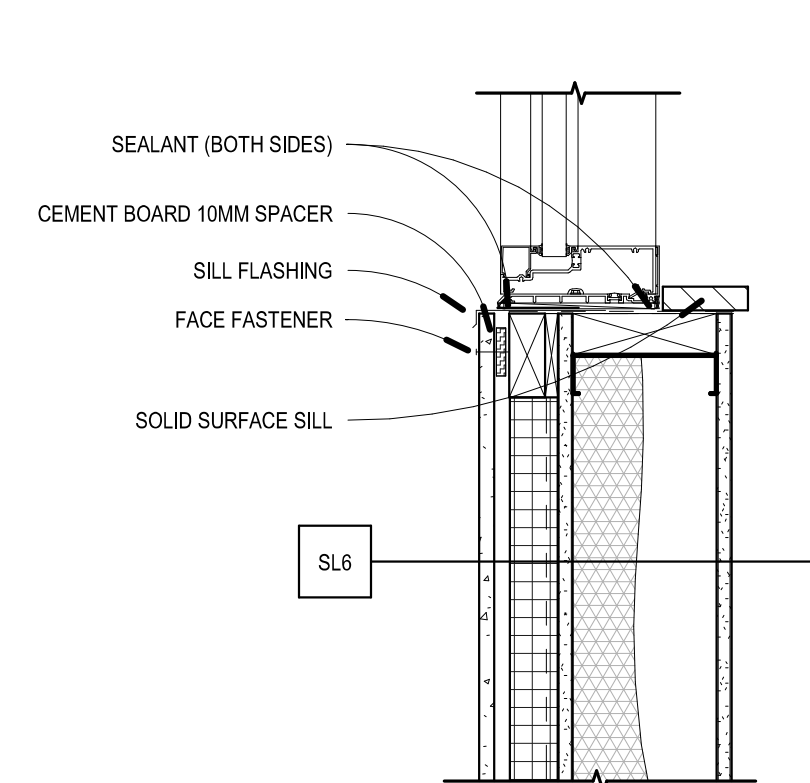


10 A520 Cement Board Window Sill Detail
1 1/2" = 1'-0"

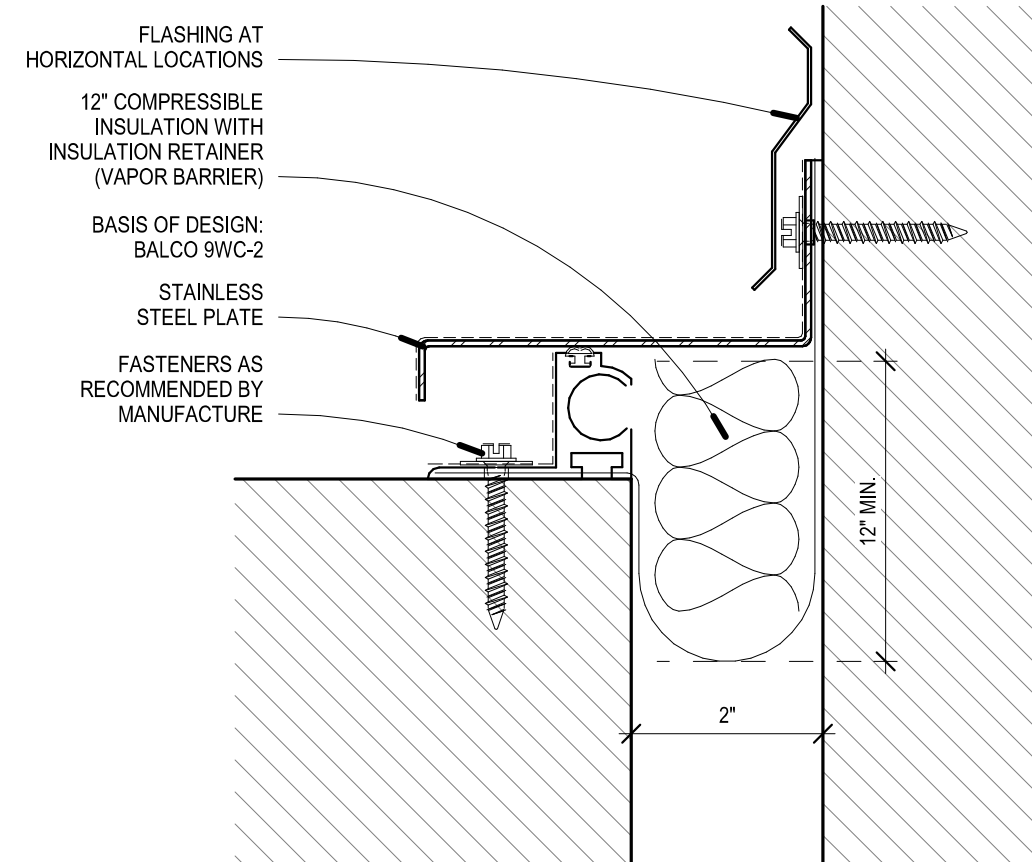


11 A520 Expansion Joint at Ext. Wall or Roof
6" = 1'-0"

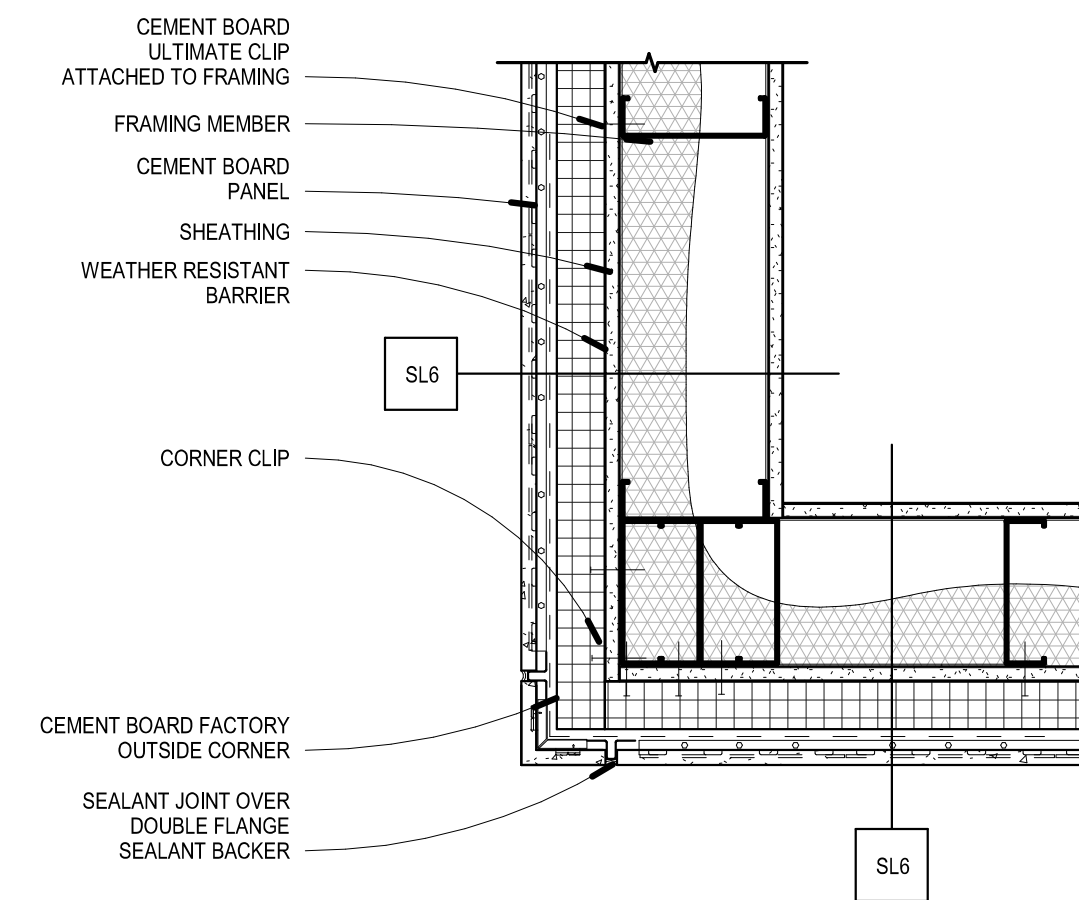


9 A520 Cement Board Outside Corner
1 1/2" = 1'-0"

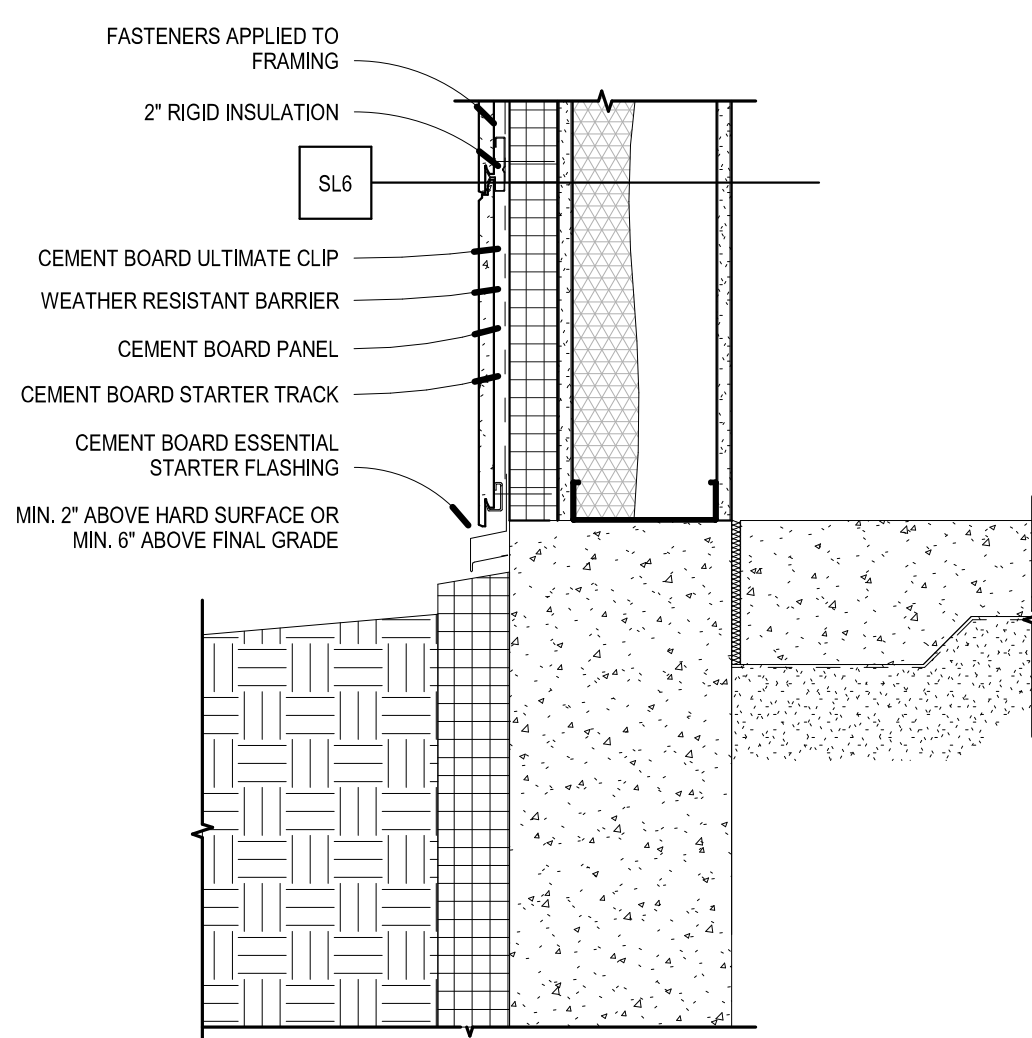


12 A520 Cement Board Base Detail
1 1/2" = 1'-0"

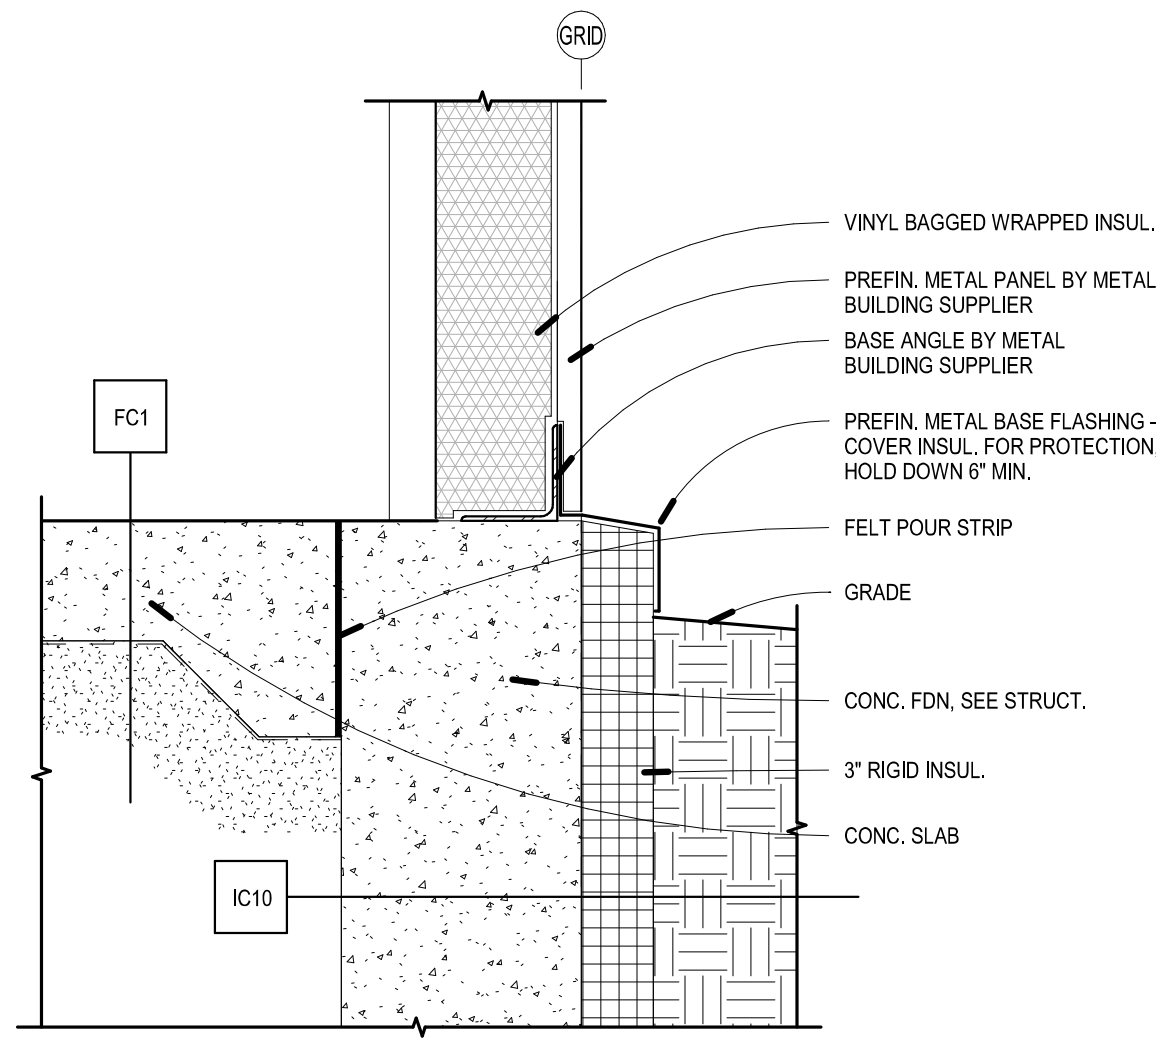

13 A520 PEMB Base Detail
1 1/2" = 1'-0"

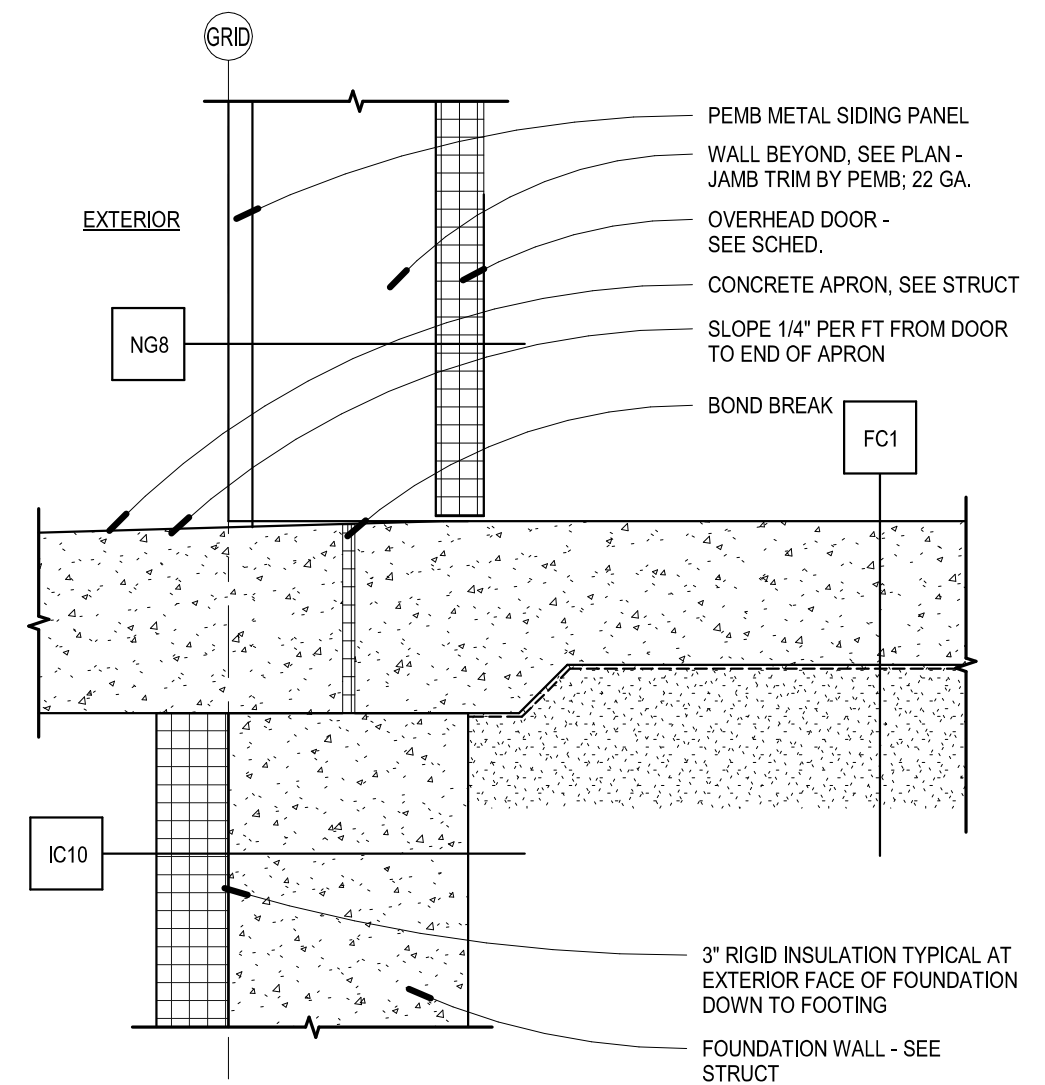

14 A520 Base @ O.H. Door Detail
1 1/2" = 1'-0"

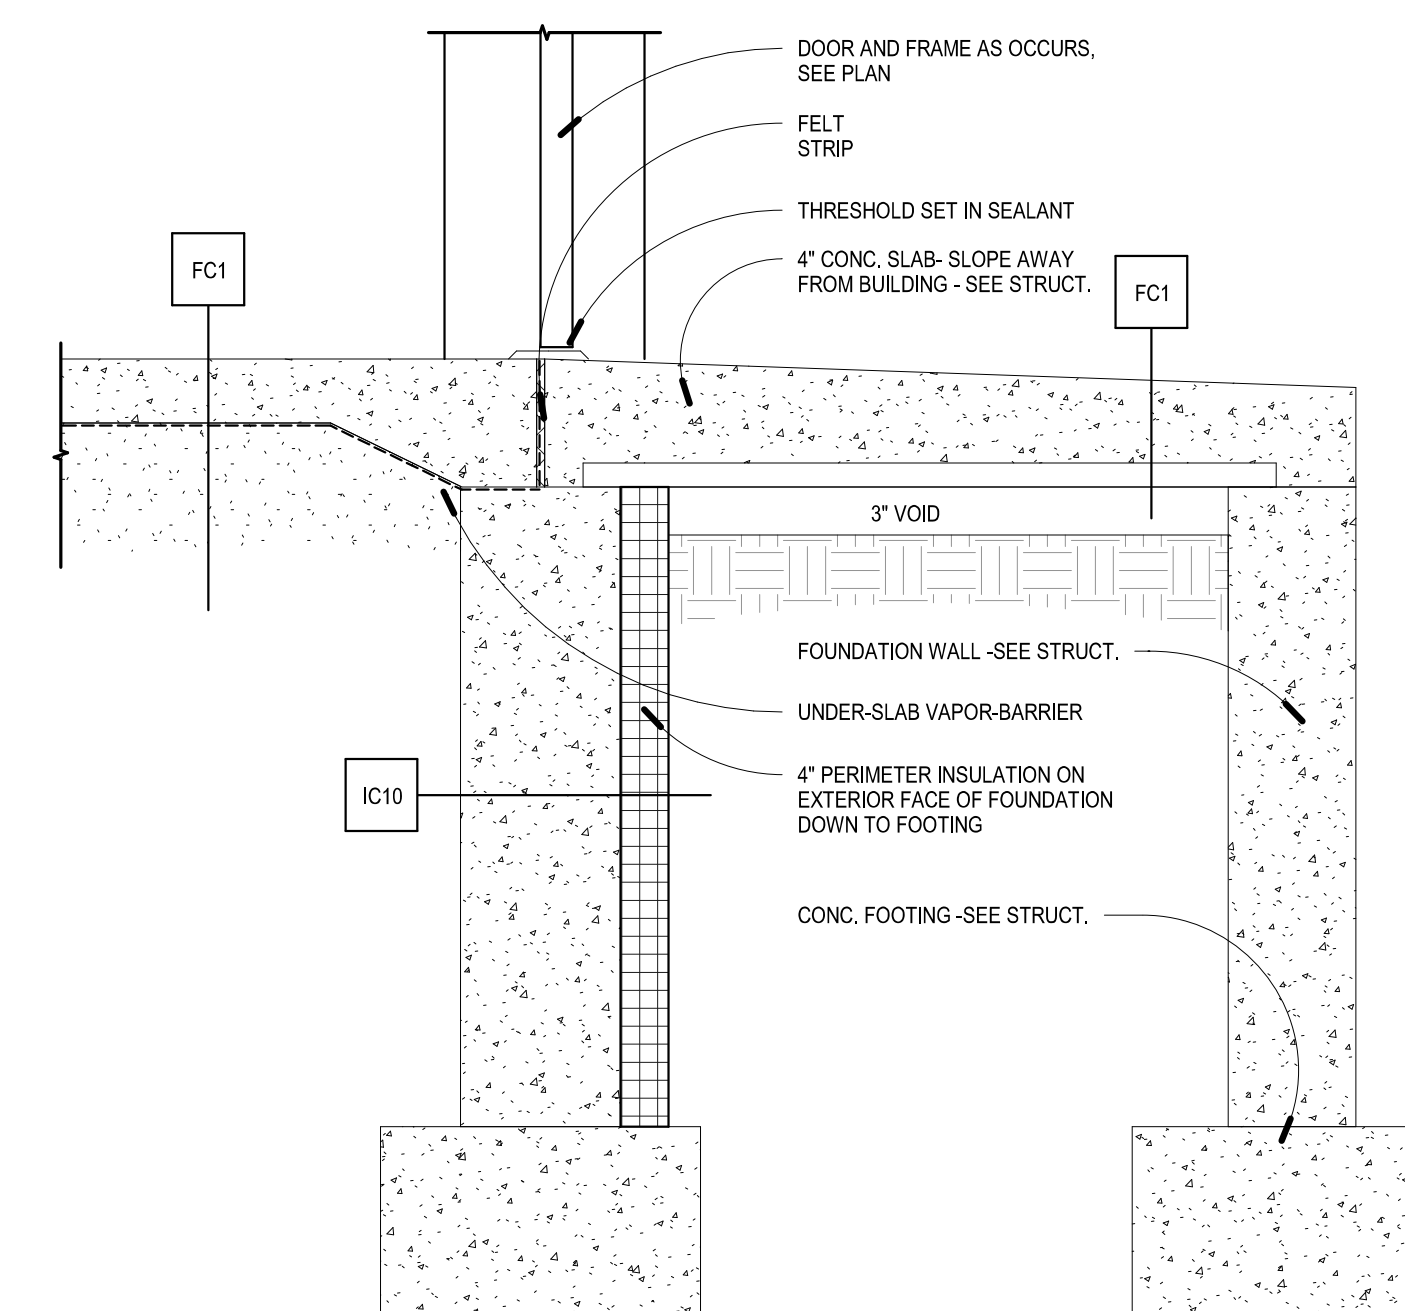

15 A520 Stoop Detail
1" = 1'-0"



DRAWING HISTORY


NO.	DESCRIPTION	DATE
1	CONSTRUCTION DOCUMENTS	01/15/2025

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Details


SHEET

A520

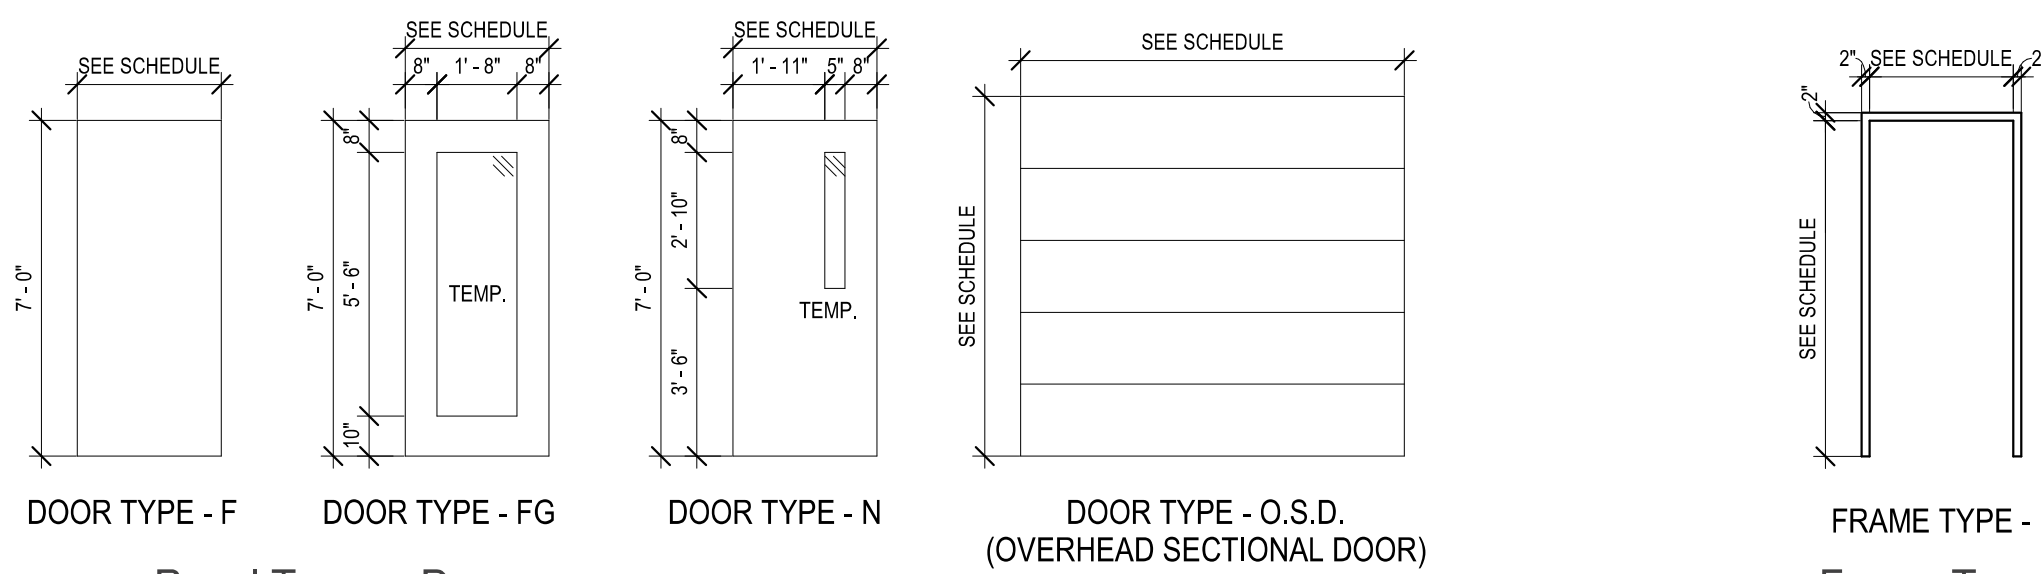

1 A601 Panel Types - Doors
1/4" = 1'-0"

2 A601 Frame Types - Doors
1/4" = 1'-0"

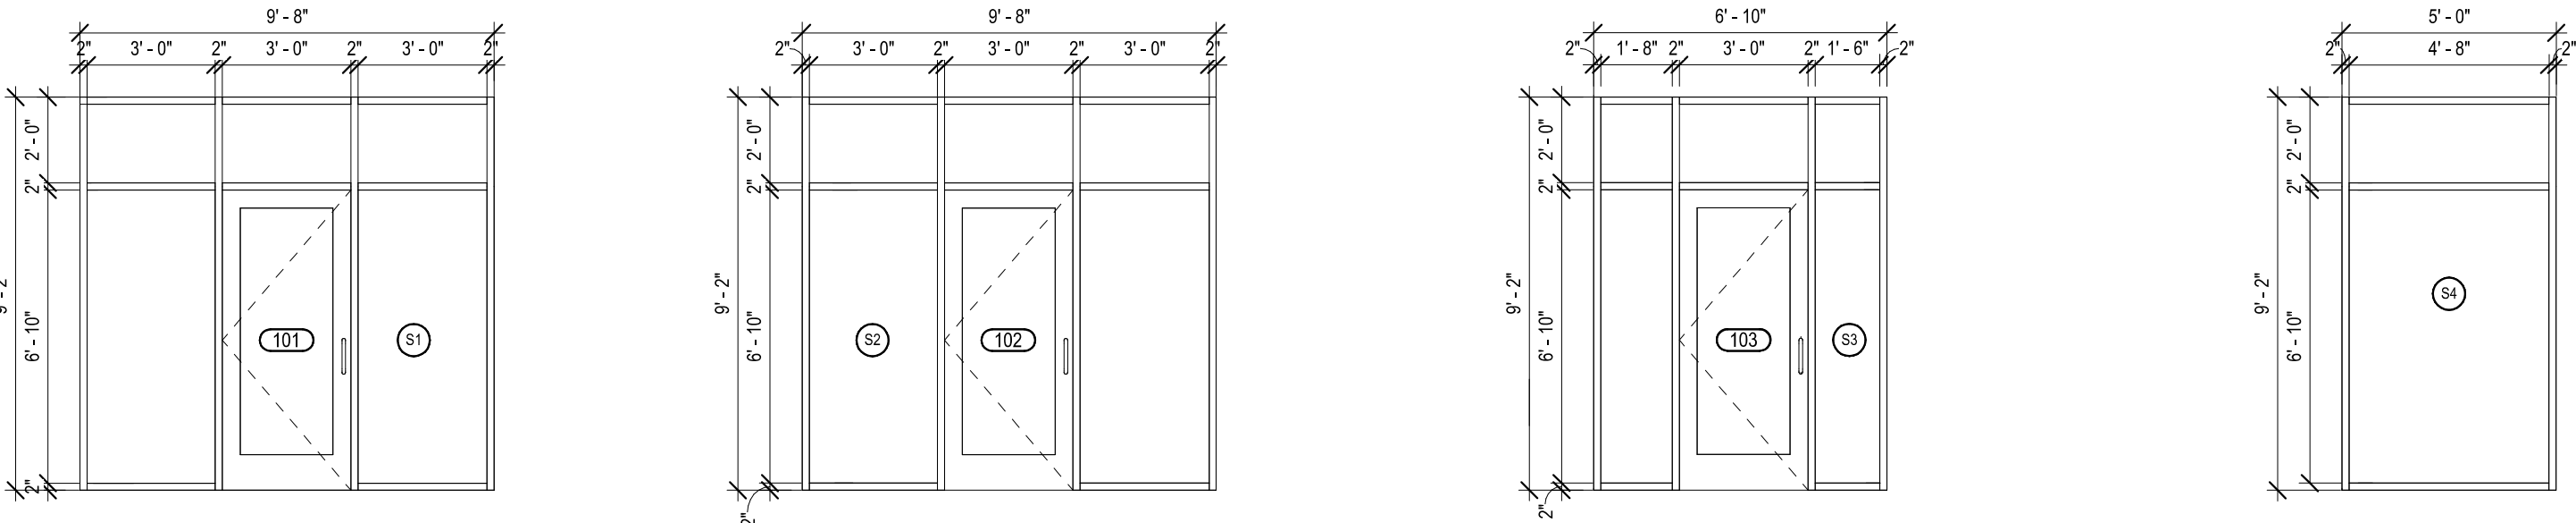


3 A601 Storefront S1 - System 2
1/4" = 1'-0"

4 A601 Storefront S2 - System 1
1/4" = 1'-0"

5 A601 Storefront S3 - System 1
1/4" = 1'-0"


6 A601 Storefront S2 - System 2
1/4" = 1'-0"

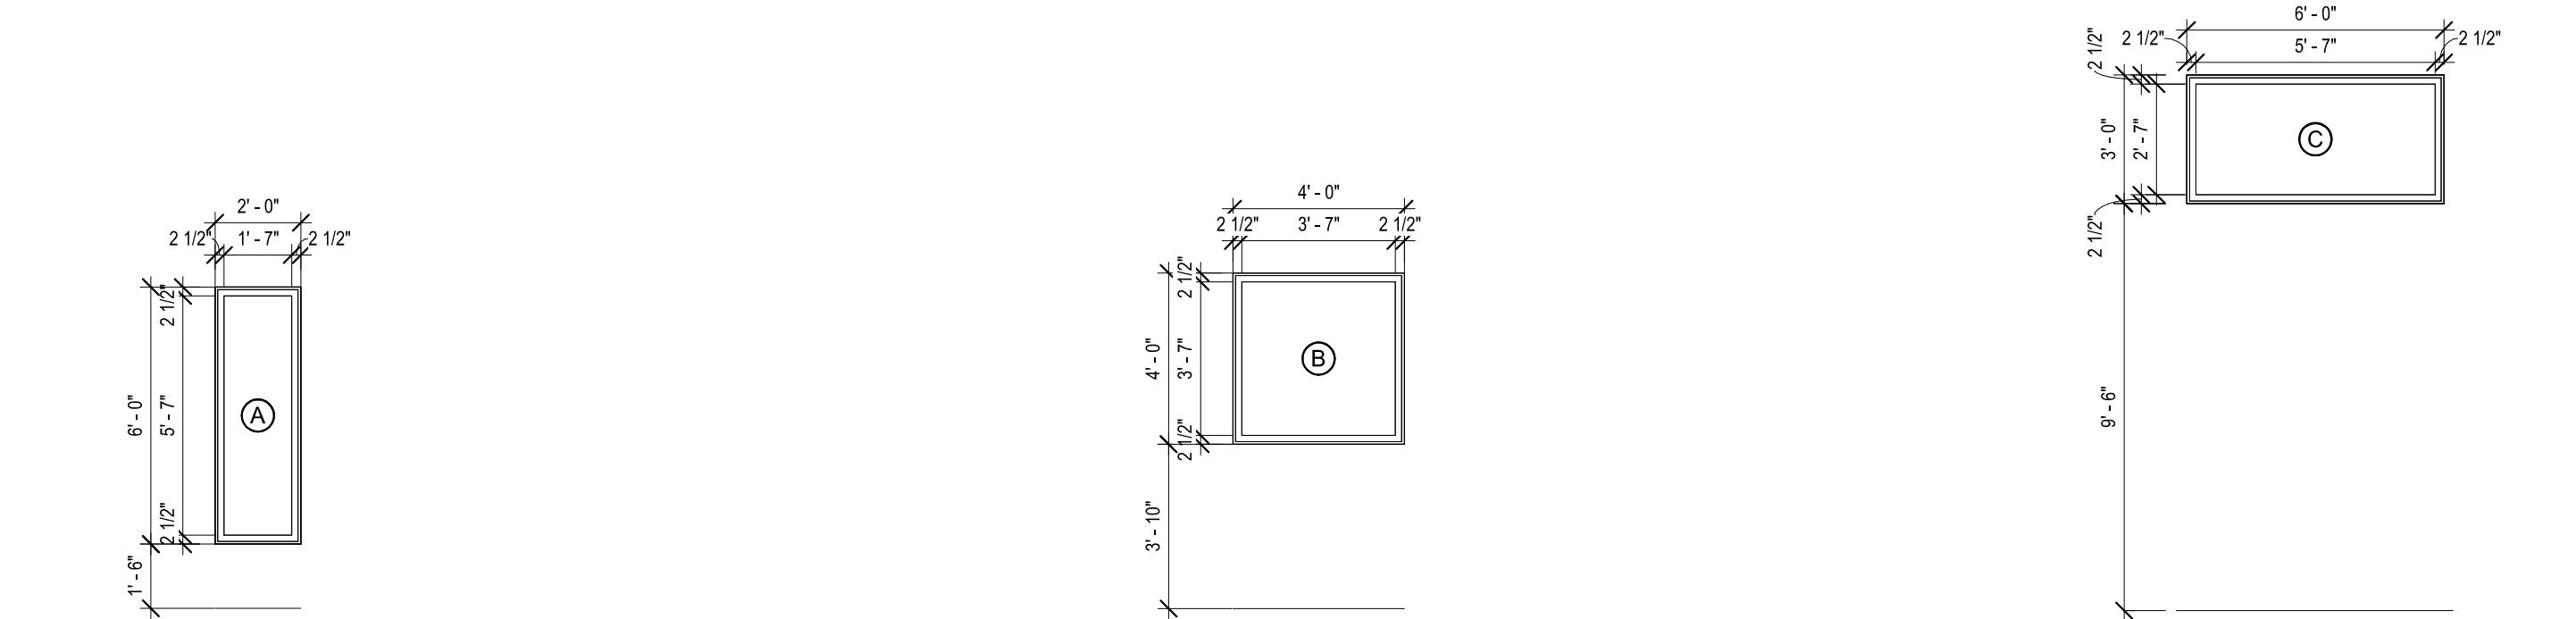

7 A601 Window Type - A
1/4" = 1'-0"

8 A601 Window Type - B
1/4" = 1'-0"


9 A601 Window Type - C
1/4" = 1'-0"

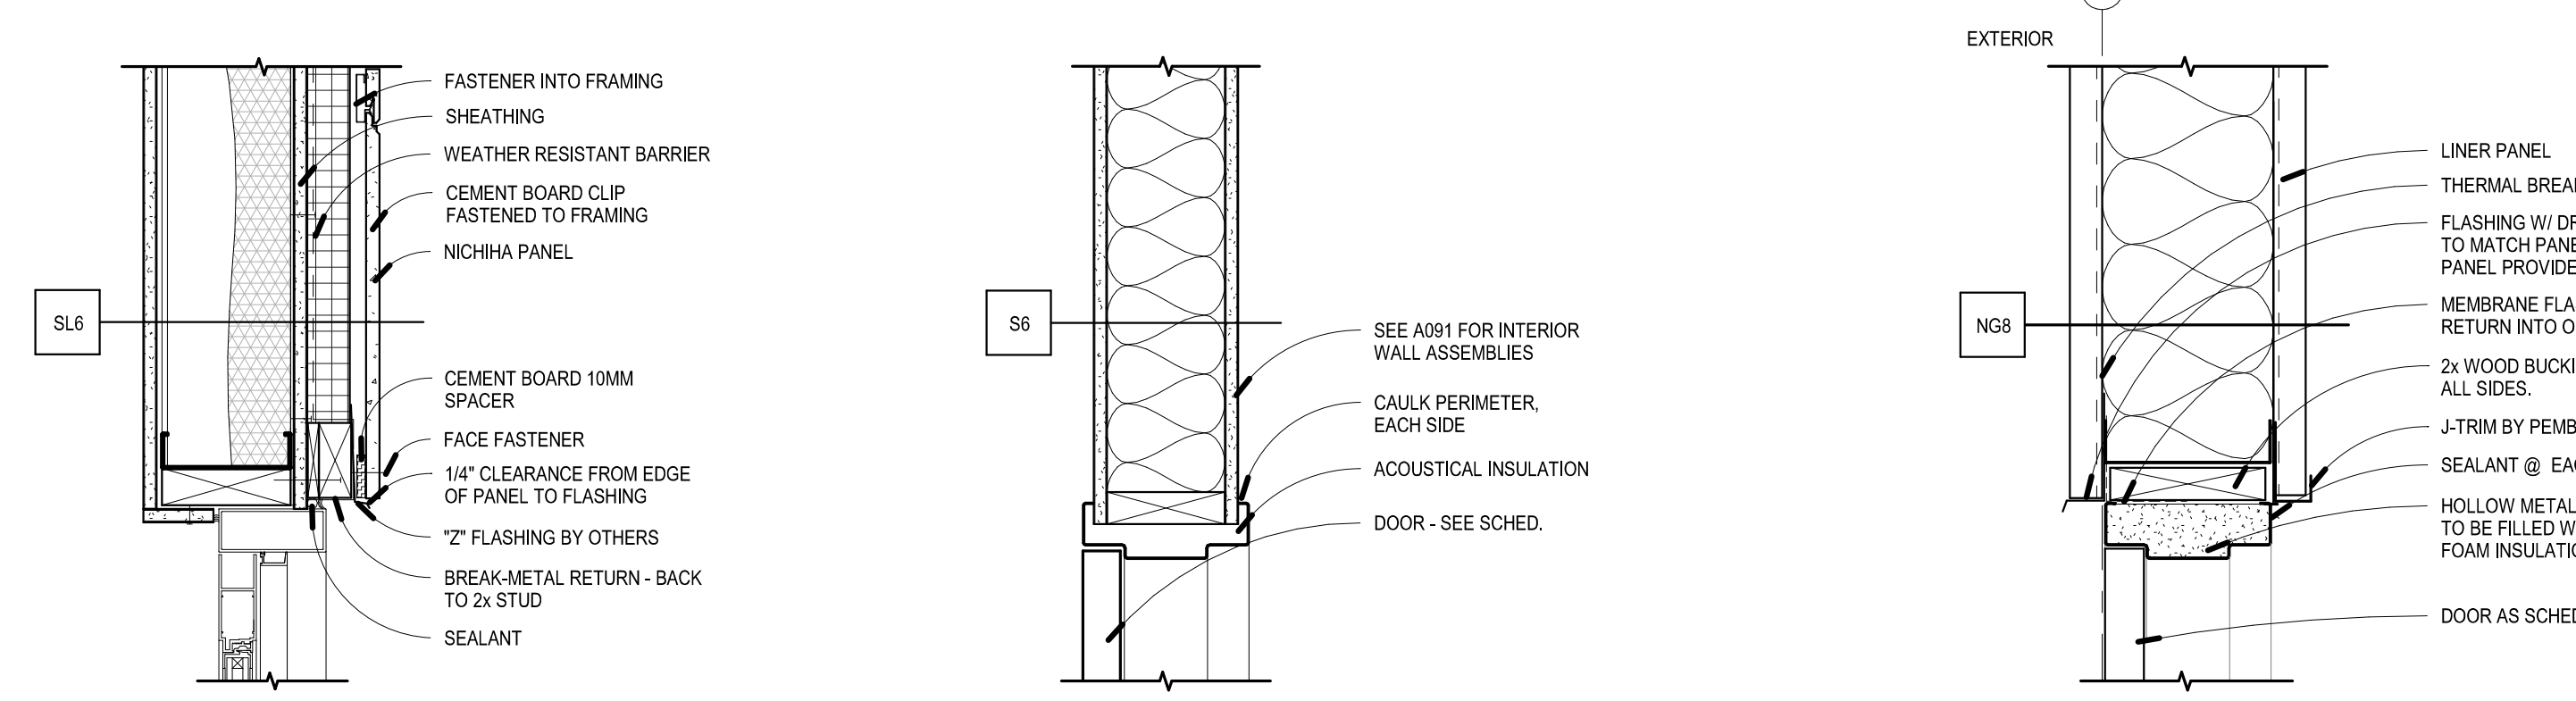

12 A601 Door Head Storefront - Cement Board Panels
1 1/2" = 1'-0"

13 A601 Head/Jamb @ Steel Stud
1 1/2" = 1'-0"

14 A601 HM Head @ PEMB W/ Liner Panel
1 1/2" = 1'-0"

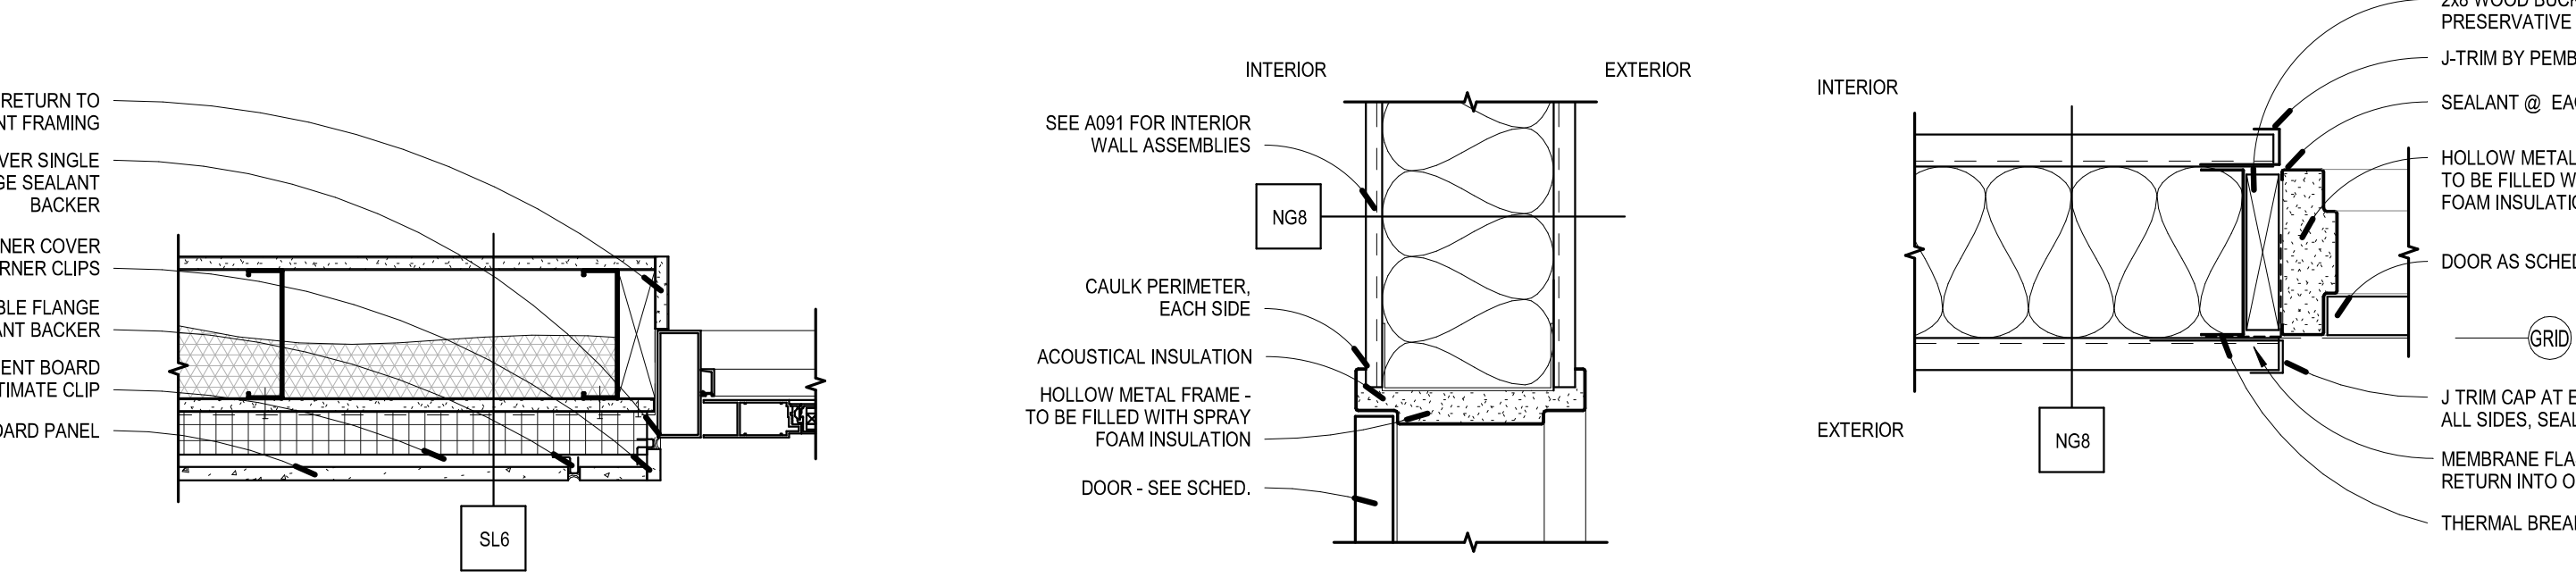

17 A601 Door Jamb Storefront - Cement Board Panels
1 1/2" = 1'-0"


18 A601 Head/Jamb @ PEMB
1 1/2" = 1'-0"

19 A601 HM Jamb @ PEMB W/ Liner Panel
1 1/2" = 1'-0"




DOOR SCHEDULE

Door Number	Room	Exterior Door	Door Pair	Width	Height	Thickness	Door Type	Material	Finish	Glazing	Hardware	Fire Rating	Type	Frame Material	Finish	Comments
101	VESTIBULE		N	3'-0"	7'-0"	1.34"	FG	AL			09		S2	AL		ACCESSIBLE OPERATOR, CARD ACCESS
102	CUSTOMER SERVICE		N	3'-0"	7'-0"	1.34"	FG	AL			11		S3	AL		ACCESSIBLE OPERATOR
103	VESTIBULE		N	3'-0"	7'-0"	1.34"	FG	AL			08		S4	AL		ACCESSIBLE OPERATOR, CARD ACCESS
104	OFFICE		N	3'-0"	7'-0"	1.34"	F	WOOD	WD-1	GL-1	01	20 MIN	1	HM	PT-4	
105	OFFICE		N	3'-0"	7'-0"	1.34"	F	WOOD	WD-1	GL-1	01	20 MIN	1	HM	PT-4	
106	OFFICE		N	3'-0"	7'-0"	1.34"	F	WOOD	WD-1	GL-1	01	20 MIN	1	HM	PT-4	
107	OFFICE		N	3'-0"	7'-0"	1.34"	F	WOOD	WD-1	GL-1	01	20 MIN	1	HM	PT-4	
108	OFFICE		N	3'-0"	7'-0"	1.34"	F	WOOD	WD-1	GL-1	01	20 MIN	1	HM	PT-4	
109	OFFICE		N	3'-0"	7'-0"	1.34"	F	WOOD	WD-1	GL-1	01	20 MIN	1	HM	PT-4	
110A	TRAINING ROOM		N	3'-0"	7'-0"	1.34"	F	WOOD	WD-1	GL-1	03	20 MIN	1	HM	PT-4	
110B	TRAINING ROOM		N	3'-0"	7'-0"	1.34"	F	WOOD	WD-1		03	20 MIN	1	HM	PT-4	
111	HALLWAY		N	3'-0"	7'-0"	1.34"	FG	AL			10		1	AL		CARD ACCESS
112	OPEN WORKSTATIONS		N	3'-0"	7'-0"	1.34"	F	WOOD	WD-1		05		1	HM	PT-4	CARD ACCESS
113A	SUPPLY		N	3'-0"	7'-0"	1.34"	F	WOOD	WD-1		05	20 MIN	1	HM	PT-4	CARD ACCESS
113B	SUPPLY		N	3'-0"	7'-0"	1.34"	F	WOOD	WD-1		05		1	HM	PT-4	CARD ACCESS
114A	MECHANICAL		N	3'-0"	7'-0"	1.34"	F	WOOD	WD-1		05	20 MIN	1	HM	PT-4	CARD ACCESS
114B	MECHANICAL		N	3'-0"	7'-0"	1.34"	F	WOOD	WD-1		05		1	HM	PT-4	CARD ACCESS
115	ELECTRICAL		N	3'-0"	7'-0"	1.34"	F	WOOD	WD-1		05	20 MIN	1	HM	PT-4	CARD ACCESS
117	RESTROOM		N	3'-0"	7'-0"	1.34"	F	WOOD	WD-1		02		1	HM	PT-4	
118	RESTROOM		N	3'-0"	7'-0"	1.34"	F	WOOD	WD-1		02	20 MIN	1	HM	PT-4	
119	RESTROOM		N	3'-0"	7'-0"	1.34"	F	WOOD	WD-1		02		1	HM	PT-4	
120A	GARAGE		N	14'-0"	14'-0"	2"	O.S.D.	STEEL			04			STEEL		
120B	GARAGE		N	3'-0"	7'-0"	1.34"	F	HM	PT-4		07		1	HM	PT-4	CARD ACCESS
120C	GARAGE		N	14'-0"	14'-0"	2"	O.S.D.	STEEL			04			STEEL		
120D	GARAGE		N	14'-0"	14'-0"	2"	O.S.D.	STEEL			04			STEEL		
120E	GARAGE		N	3'-0"	7'-0"	1.34"	F	HM	PT-4		07		1	HM	PT-4	CARD ACCESS

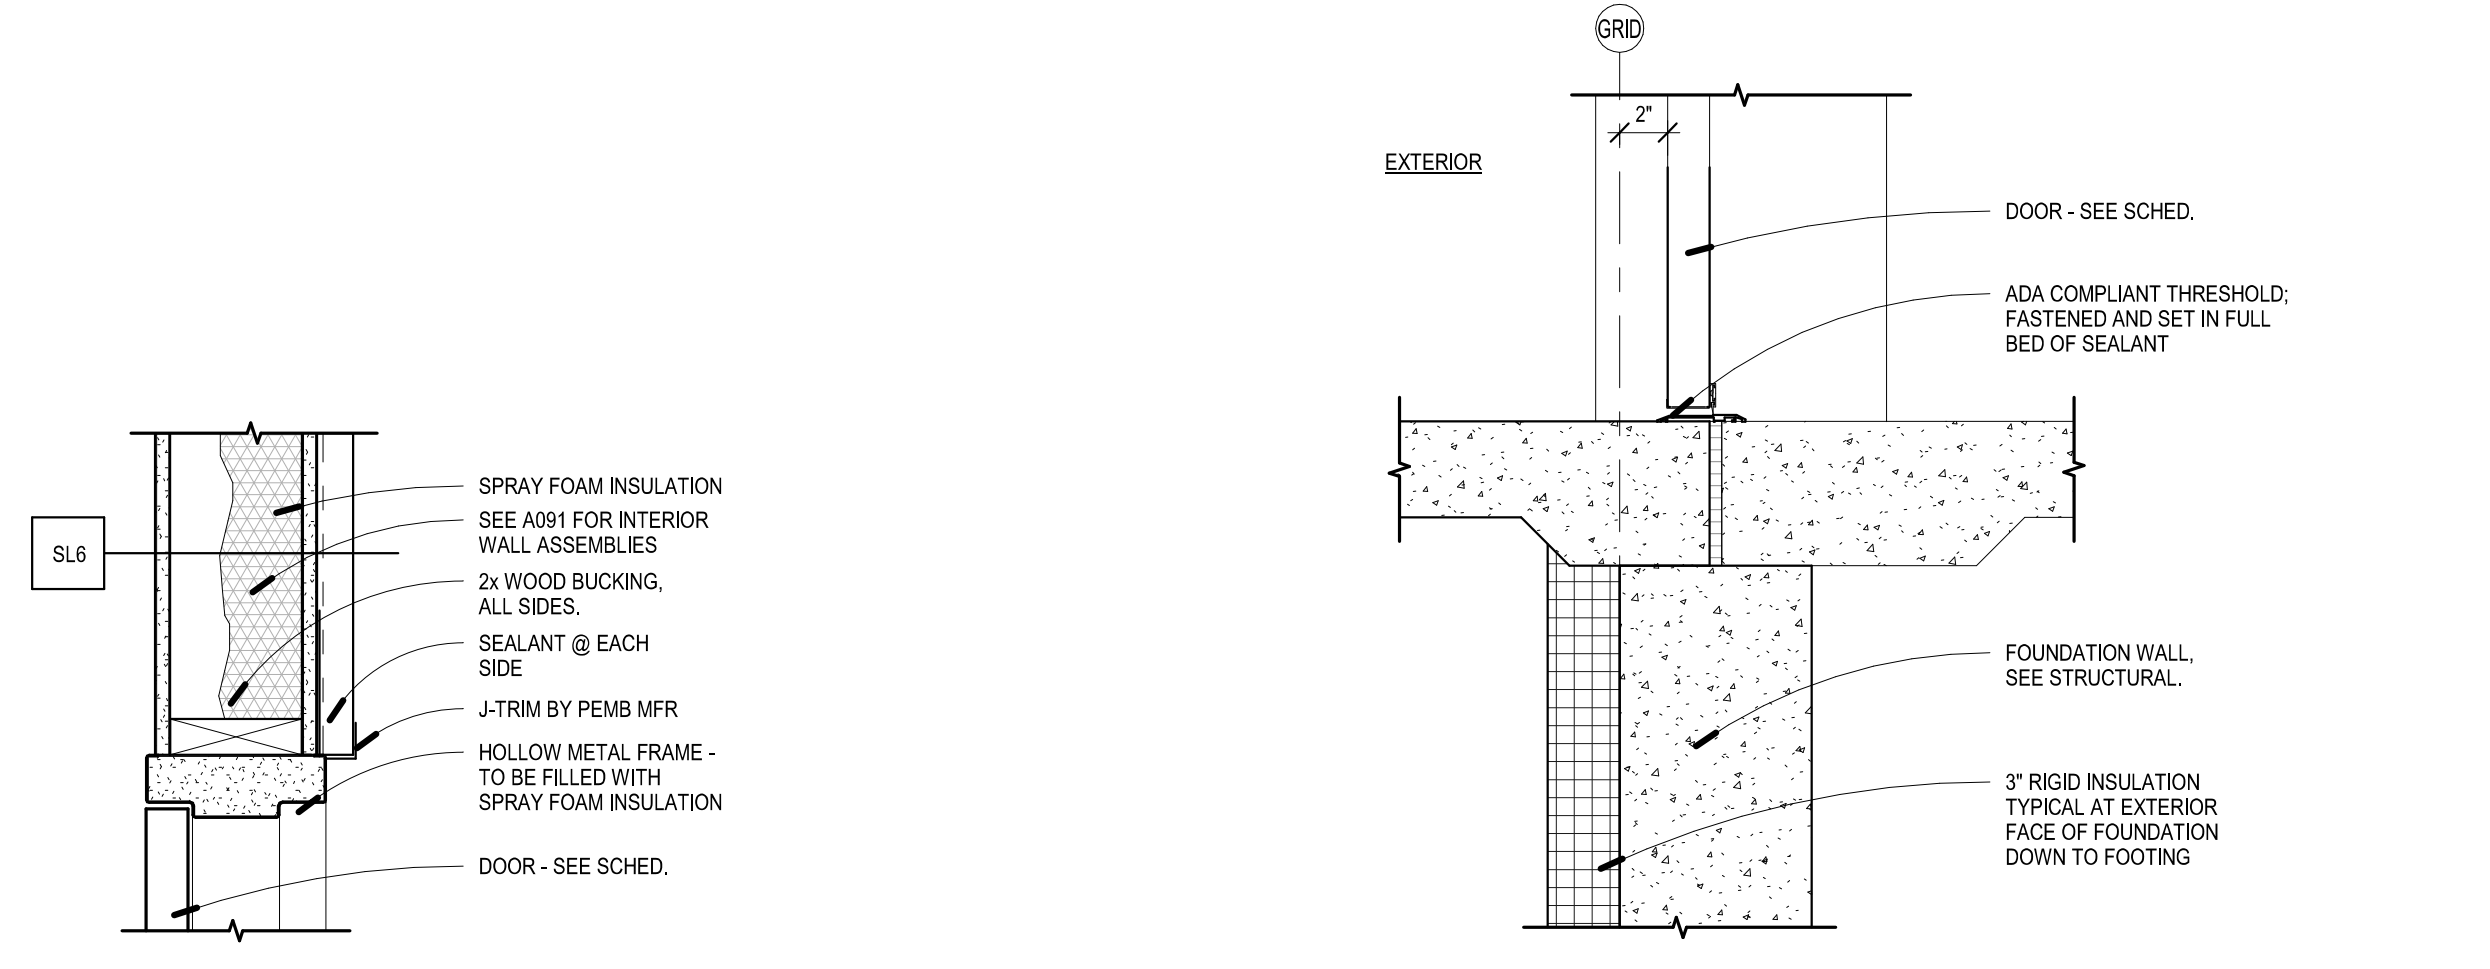


10 A601 Head/Jamb @ Stud / Liner Panel
1 1/2" = 1'-0"

11 A601 Door Threshold Detail
1 1/2" = 1'-0"

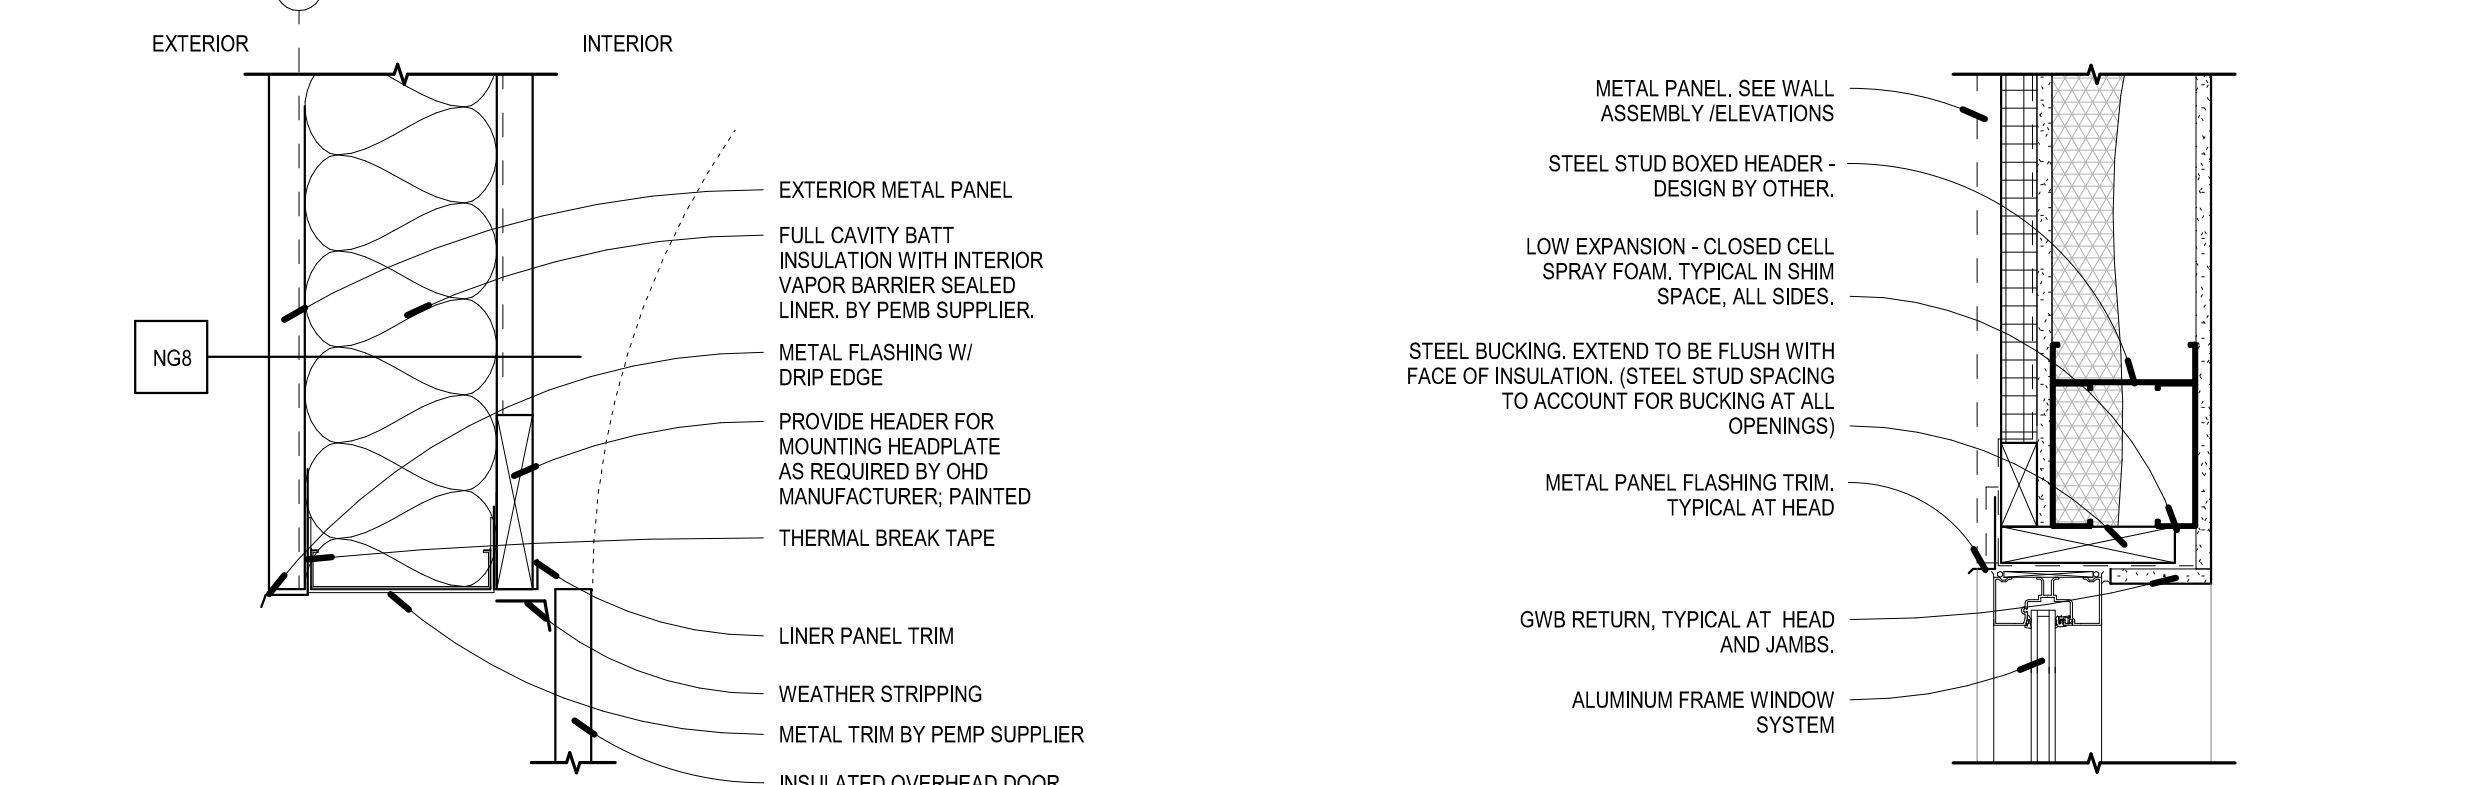

15 A601 Head @ O.H. Door W/ Liner Panel
1 1/2" = 1'-0"

16 A601 Head @ NS Wall Type
1 1/2" = 1'-0"

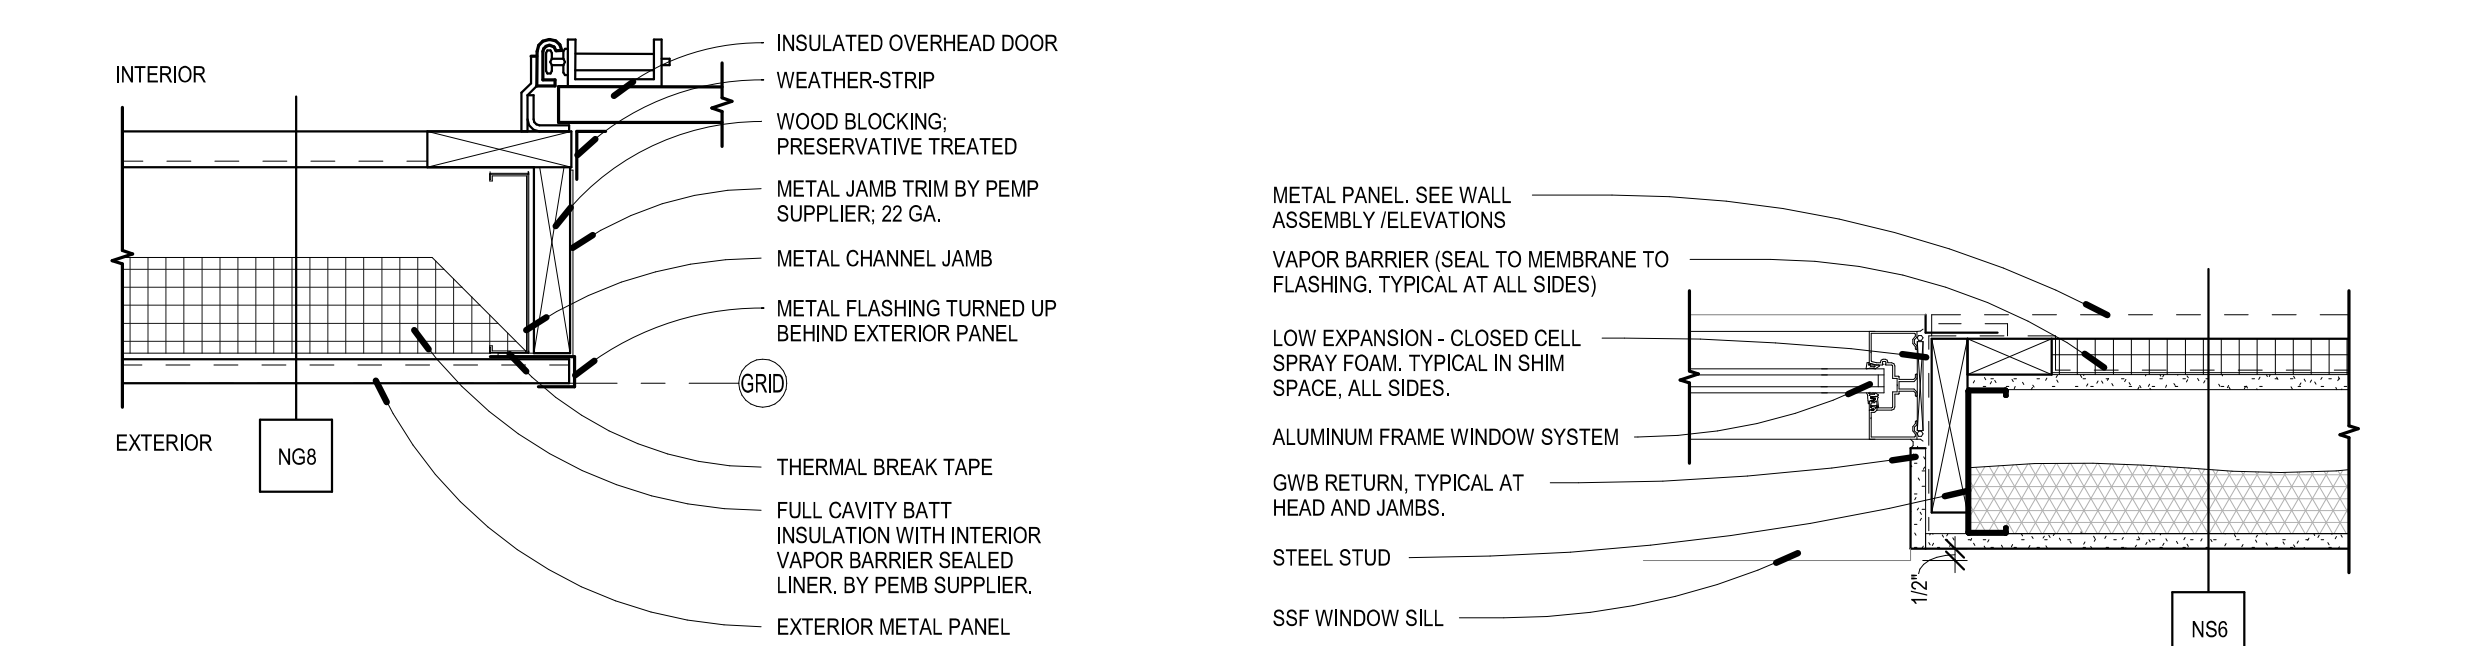

20 A601 Jamb @ O.H. Door W/ Liner Panel
1 1/2" = 1'-0"

21 A601 Jamb @ NS Wall Type
1 1/2" = 1'-0"



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FINISH SCHEDULE

DIVISION	TYPE	MARK	MANUFACTURER	STYLE	COLOR	SIZE	INSTALLATION	FINISH	LOCATION	COMMENTS
ARCHITECTURAL WOOD CASEWORK										
06 41 00	PLAM	1	WILSONART	HPL	RIVER CHERRY 7937-38	-	-	38 FINE VELVET TEXTURE	-	
WOOD DOORS										
08 14 16	WD	1	VT INDUSTRIES	NATURAL BIRCH	TOFFEE TF24	-	-	SATIN	-	
TILING										
09 30 00	T	1	MILE STONE	AREA 51	STEEL	12"x24"	1/2 OFFSET	-	BATHROOM & STORAGE FLOORS	
09 30 00	T	2	MILE STONE	AREA 51	WHITE	12"x24"	1/2 OFFSET	-	BATHROOM WALLS	
09 30 00	T	3	CAESAR CERAMICS USA	WAVES	PACIFIC	12"x24", 6"x24"	SEE 2/A701 FOR PATTERN DETAIL	-	BREAKROOM & CUSTOMER SERVICE FLOORS	
TILING - GROUT										
09 30 00	G	1	LATICRETE	SEE SPEC	45 RAVEN	MFR RECOMMENDATION	SEE SPEC	-	T-1 LOCATIONS	
09 30 00	G	2	LATICRETE	SEE SPEC	89 SMOKE GREY	MFR RECOMMENDATION	SEE SPEC	-	T-2 LOCATIONS	
09 30 00	G	3	LATICRETE	SEE SPEC	42 PLATIUM	MFR RECOMMENDATION	SEE SPEC	-	T-3 LOCATIONS	
TILING - METAL PROFILES										
09 30 00	MTLP	1	SCHLUTER	JOLLY	ANODIZED ALUMINUM	-	-	-	TOPOUTSIDE CORNERS OF WALL TILE	
09 30 00	MTLP	2	SCHLUTER	DILEX-AHK	ANODIZED ALUMINUM	-	-	-	COVE OF FLOORWALL TILE	
09 30 00	MTLP	3	SCHLUTER	RENO-TK	ANODIZED ALUMINUM	-	-	-	CARPET TO TILE FLOOR TRANSITION	
09 30 00	MTLP	4	SCHLUTER	RENO-U	ANODIZED ALUMINUM	-	-	-	TILE TO CONCRETE FLOOR TRANSITION	
ACOUSTICAL TILE CEILINGS										
09 51 00	ACT	1	USG	MARS	WHITE	24"x24"	15/16" GRID	LIGHTLY TEXTURED, SQUARE	-	
SUSPENDED WOOD CEILINGS										
09 54 26	WDC	1	9WOOD	9100-D HYBRID PANEL	MAHOGANY STAIN ON WESTERN HEMLOCK	12"W x LENGTH VARIES	15/16" GRID (HEAVY DUTY)	-	-	
RESILIENT FLOORING - BASE & ACCESSORIES										
09 65 00	RB	1	TARKETT	TRADITIONAL BASE 1/8" (TP)	08 ICICLE W	4" HIGH	COVERED	-	TYPICAL	
09 65 00	RR	1	TARKETT	SLT-71-J	71 STORM CLOUD CG	-	CARPET TO CONC. REDUCER	-	SEE FINISH FLOOR PLANS	
TILE CARPETING										
09 68 13	WOM	1	TARKETT	ABRASIVE ACTION II (02578)	WINTER GRAY (19103)	12"x24"	MONOLITHIC	-	-	
09 68 13	CPT	1	TARKETT	MENTOR (11686)	BE KIND (20506)	24"x24"	VERTICAL ASHLAR	-	-	
INTERIOR PAINTING										
09 91 23	PT	1	SHERWIN WILLIAMS	-	ESSENTIAL GRAY SW6002	-	-	EG-SHEL	TYPICAL	
09 91 23	PT	2	SHERWIN WILLIAMS	-	POOLHOUSE SW7603	-	-	SEMI-GLOSS	RESTROOMS ABOVE TILE	
09 91 23	PT	3	SHERWIN WILLIAMS	-	SMOKY BLUE SW7604	-	-	EG-SHEL	ACCENT	
09 91 23	PT	4	SHERWIN WILLIAMS	-	ESSENTIAL GRAY SW6002	-	-	SEMI-GLOSS	HM DOORS & FRAMES	
09 91 23	PT	5	SHERWIN WILLIAMS	-	CEILING BRIGHT WHITE SW7007	-	-	FLAT	OPEN CEILINGS	
WALL AND DOOR PROTECTION										
10 26 00	CG	1	INPRO ARCHITECTURAL PRODUCTS	HIGH IMPACT 160	PEBBLE GRAY 0387	2X2X4	BLUNOSE RETAINER	-	-	
WINDOW SHADES										
12 24 00	RWS	1	MECHO	MECHO'S MANUAL SHADE SYSTEM	SOHO 1615 SMOKE	-	MANUAL	3% OPACITY	WINDOWS - SEE FINISH FLOOR PLANS	
COUNTERTOPS-PLASTIC LAMINATE										
12 36 00	PLAM	2	WILSONART	HPL	WHITE CASCADE 5003-38	-	-	38 FINE VELVET TEXTURE	-	
COUNTERTOPS-SOLID SURFACE										
12 36 00	SSF	1	WILSONART	-	CHILLED EARTH 9228SS	1/2" THICK	-	-	WINDOW SILLS AND VANITY TOPS	

GENERAL NOTES

1. ALL FINISHES TO BE INSTALLED PER MANUFACTURER RECOMMENDATIONS UNO

ABBREVIATIONS

ACT:	ACOUSTICAL CEILING TILE
BRK:	BRICK
CG:	CORNER GUARD
CMU:	CONCRETE MASONRY UNIT
CMU-G:	CONCRETE MASONRY UNIT (GLAZED)
CMU-B:	CONCRETE MASONRY UNIT (BURNISHED)
CMU-S:	CONCRETE MASONRY UNIT (STANDARD 8"x8" SCORED)
CONC:	CONCRETE
CONC-S:	SEALED CONCRETE
CPT:	CARPET
CPT-AS:	CARPET -ANTI-STATIC
CPT-ESD:	CARPET -ELECTROSTATIC DISCHARGE
CS:	CAST STONE
EXP:	EXPOSED
FRP:	FIBERGLASS REINFORCED PANEL
FRT:	FRY REGLET REVEAL TRIM
FWP:	FABRIC-WRAPPED ACOUSTICAL PANEL
G:	GROUT
GB:	GLASS BOARD
GWB:	GYPSUM WALL BOARD
GL:	GLASS
INTB:	INTEGRAL BASE
LVT:	LUXURY VINYL TILE
MB:	MARKER BOARD
MIR:	MIRROR
MTL:	METAL
MTLP:	METAL PROFILE TRIM
N:	NONE
FLAM:	PLASTIC LAMINATE
FLAS:	PLASTER -STANDARD
PT:	PAIN
PT-E:	PAINT -EPOXY
PRF:	PREFINISHED
PWP:	PREFINISHED WALL PANEL
OWP:	OPERABLE WALL PANEL
QT:	QUARRY TILE
QT-B:	QUARRY TILE BASE
RAF:	RESILIENT ATHLETIC FLOORING
RB:	RESILIENT BASE
RN:	RUBBER NOSING
RR:	RUBBER REDUCER
RSTR:	RUBBER STAIR TREADS - RISERS
RWS:	ROLLER WINDOW SHADES
SC:	SPECIAL COATING - SEE SPECS
SOT:	STATIC DISSIPATIVE TILE
SLT:	SLATE
SLT-T:	SLATE TILE
SS:	STAINLESS STEEL
SSF:	SOLID SURFACE
ST:	STONE
STN:	STAIN
SV:	SHEET VINYL
SWU:	SOUND-ABSORBING WALL UNIT
T:	TILE
TB:	TACK BOARD
TBWP:	TRAFFIC BEARING WATER PROOFING
TP:	TOILET PARTITION
VCT:	VINYL COMPOSITION TILE
VT:	VINYL PLANK FLOORING
VT:	VINYL TILE FLOORING
WDC:	WOOD CEILING
WD:	WOOD
WDC:	WOOD CEILING
WOM:	WALK-OFF MAT
WT:	WINDOW TREATMENT




TURTLE MOUNTAIN COMMUNICATIONS NEW BUILDING
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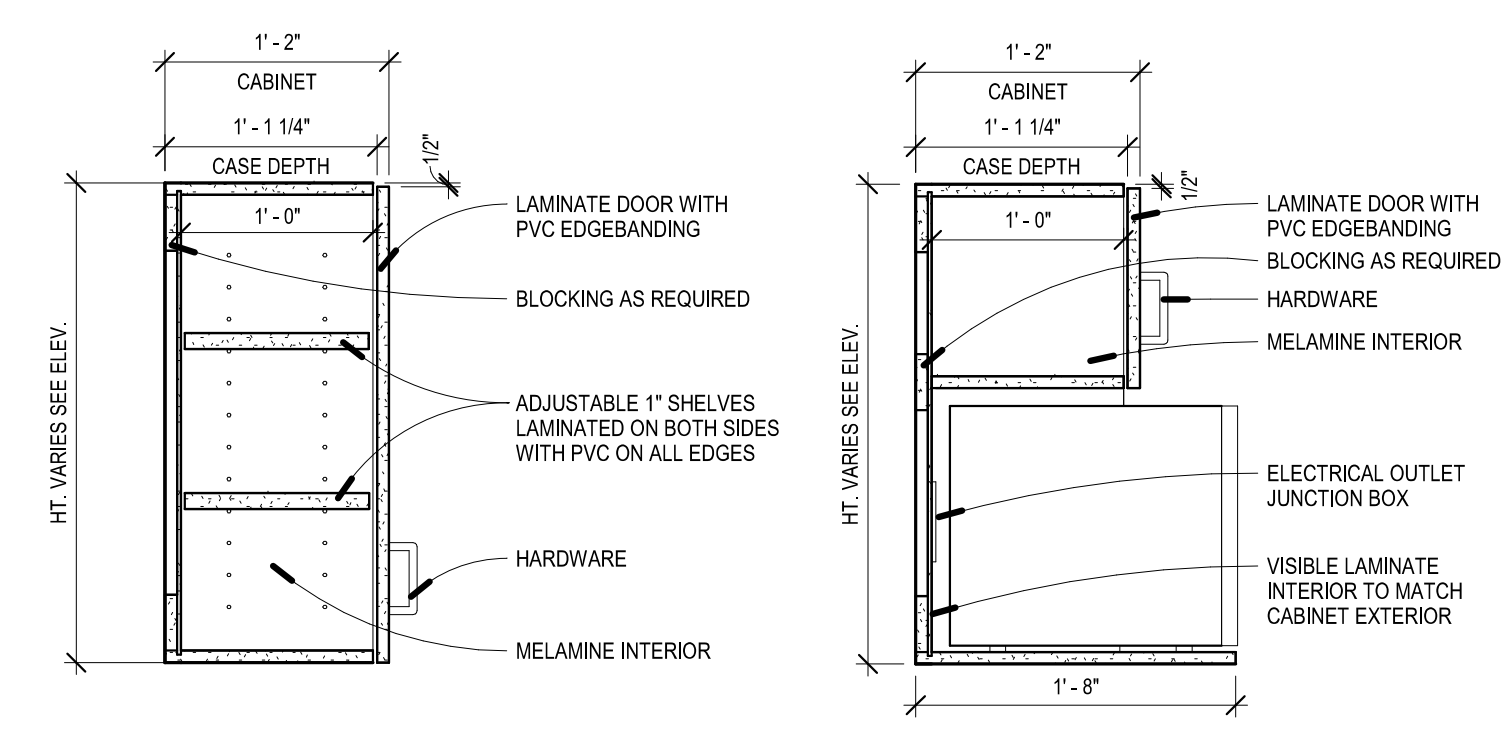
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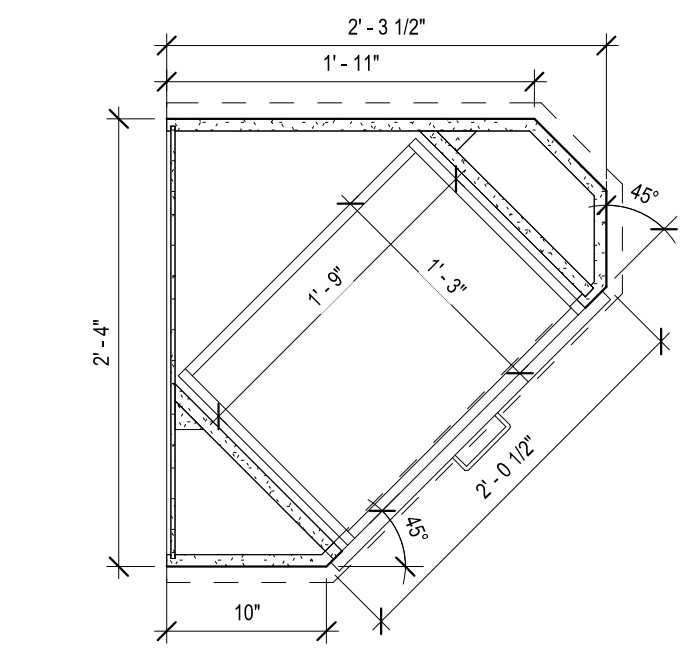


1 A610 Transition Details
1/2" = 1'-0"




2 A610 Upper Cabinet
1" = 1'-0"

3 A610 Upper MW Cabinet
1" = 1'-0"

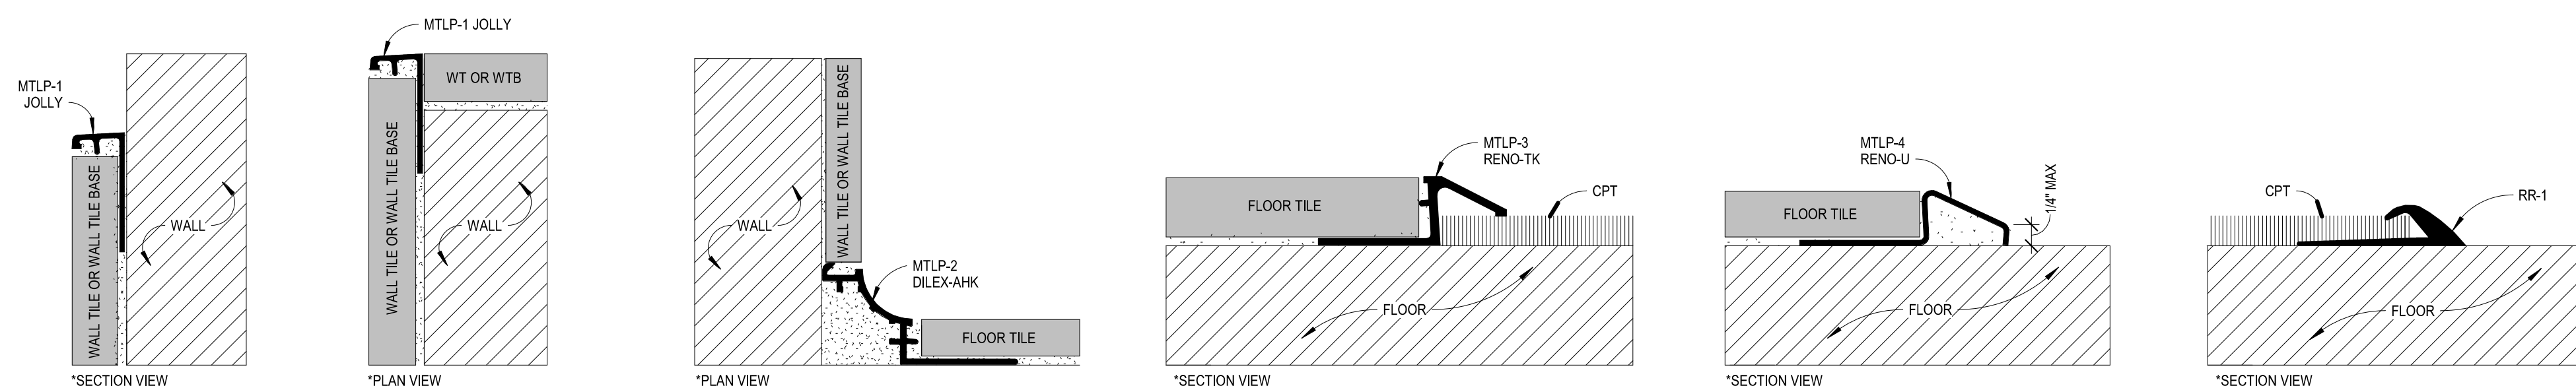

4 A610 Cash Drawer Cabinet Detail
1" = 1'-0"

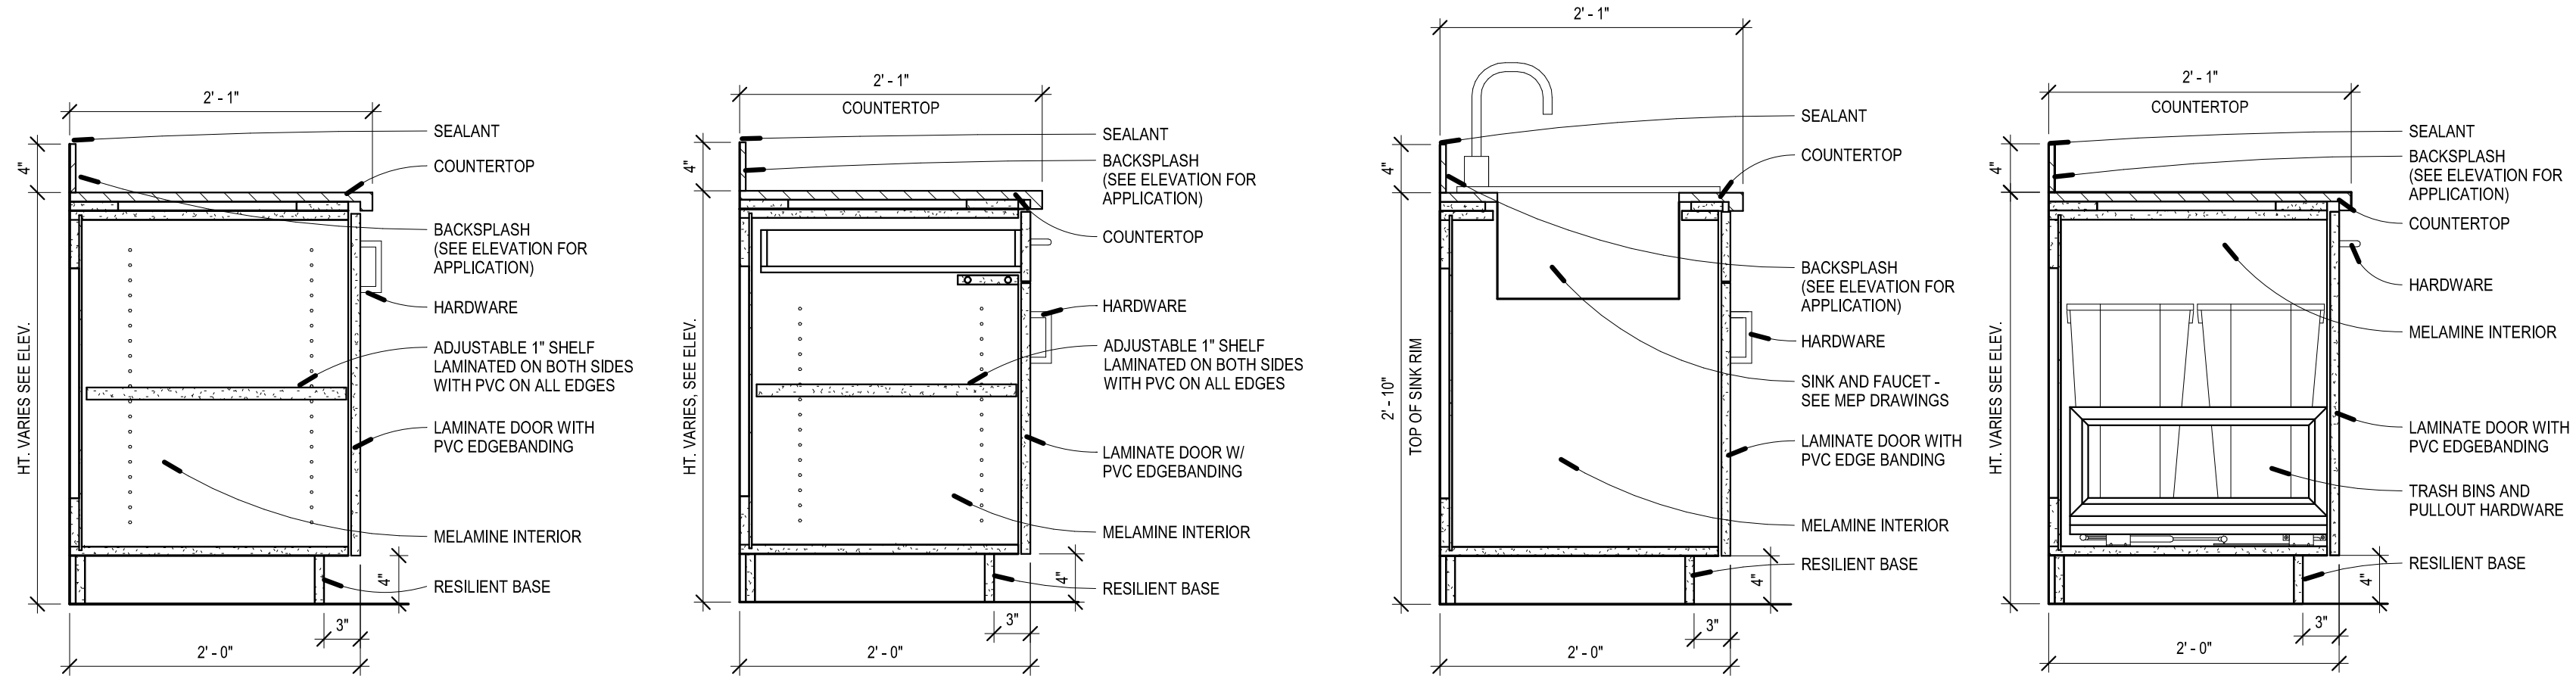


5 A610 Base Cabinet - 1 Door
1" = 1'-0"

6 A610 Base Cabinet - 1 DR, 1 DWR
1" = 1'-0"

7 A610 Sink Base
1" = 1'-0"

8 A610 Trash Pull-Out Cabinet
1" = 1'-0"

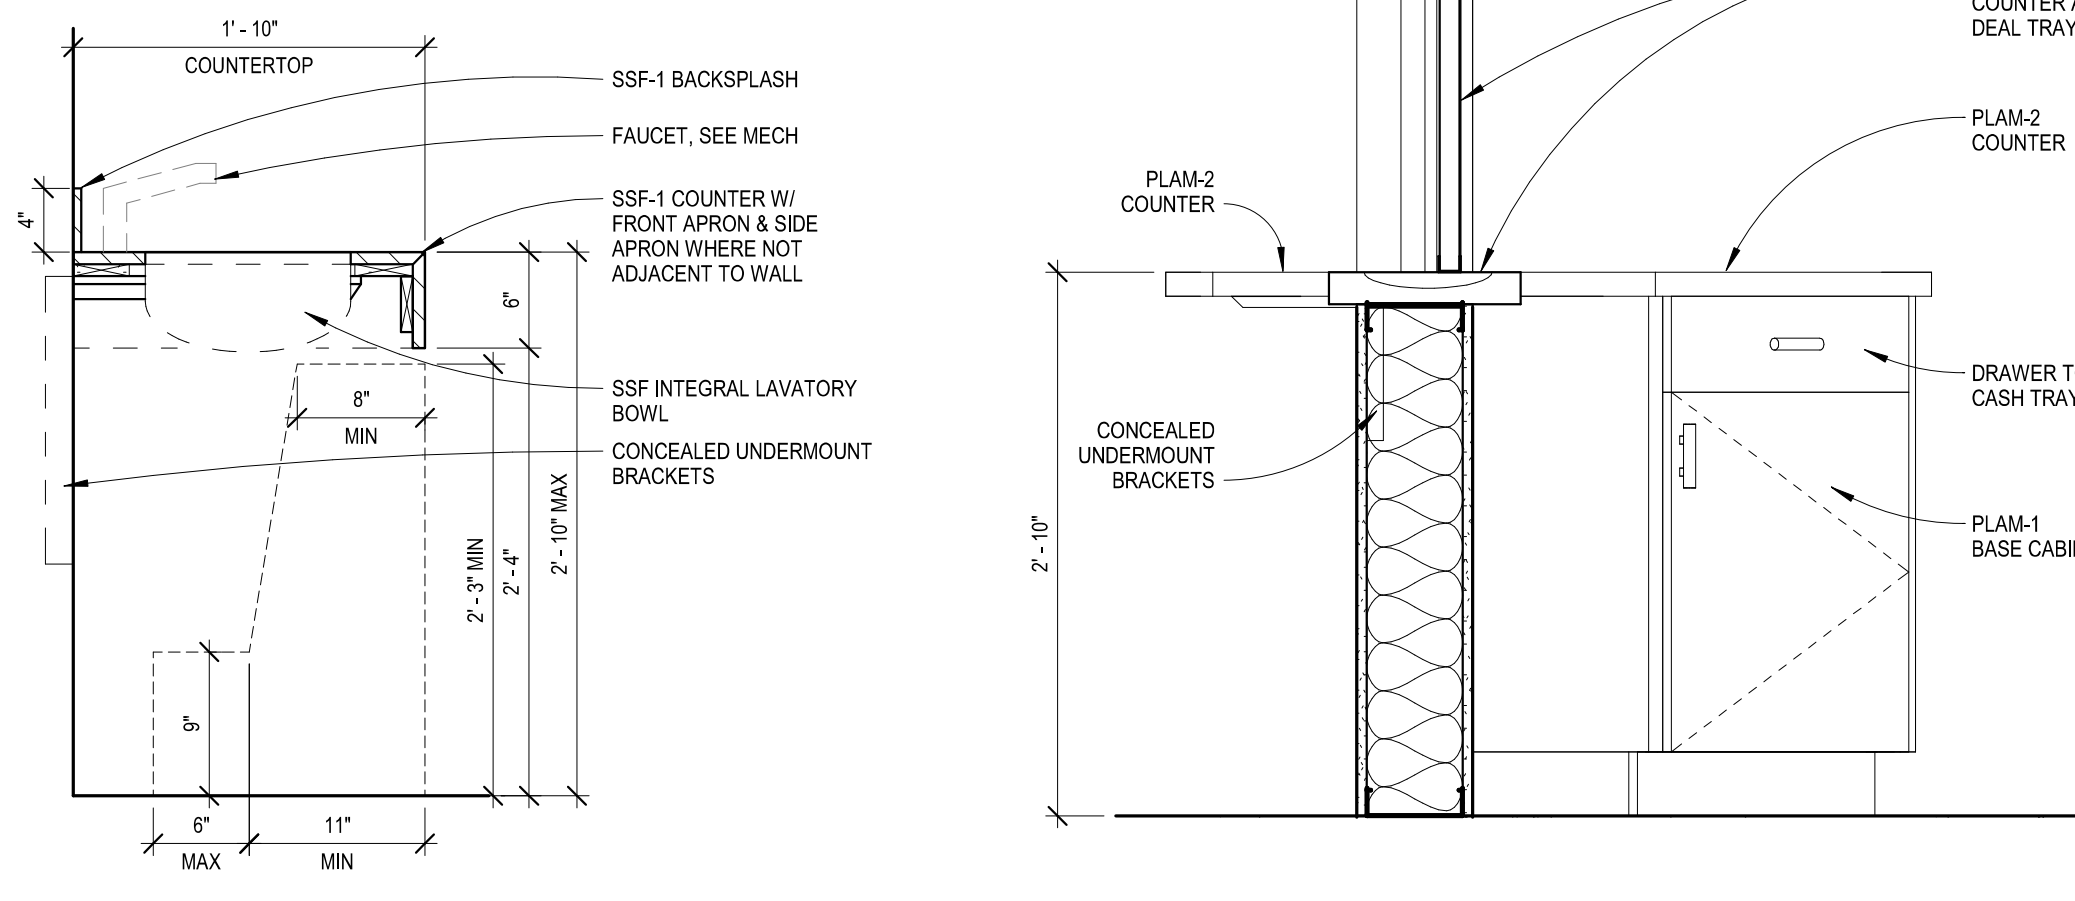

9 A610 Vanity Top
1" = 1'-0"

10 A610 Section at Cust. Service Wdw
1" = 1'-0"



DRAWING HISTORY

NO.	DESCRIPTION	DATE
1	CONSTRUCTION DOCUMENTS	01/15/2025

DRAWN BY: SRR
JN: 24-054

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GENERAL NOTES - FINISH PLANS


- CORNER GUARDS ON ALL EXPOSED GYP CORNERS. ALL CORNER GUARDS (CG) TO BE CG-1 U.N.O.
- SEE ENLARGED PLANS AND INTERIOR ELEVATIONS FOR WALL TILE LOCATIONS, HEIGHTS AND INSTALLATION PATTERNS.
- SEE REFLECTED CEILING PLAN FOR CEILING HEIGHT AND FINISH AND FINISH SCHEDULE FOR FINISH.
- TV AND BRACKET BY OWNER - PROVIDE POWER, DATA AND BLOCKING.
- FLOOR FINISH PATTERNS REPRESENTATIONAL FOR INSTALL PATTERN AND DIRECTION ONLY. REFER TO FINISH SCHEDULE FOR EXACT SIZE.
- REFER TO DOOR SCHEDULE FOR DOOR AND FRAME FINISHES.

KEYNOTES - FINISH PLANS


- MPL-3 AT FLOOR TILE TO CPT TRANSITION.
- MPL-4 AT FLOOR TILE TO CONC. TRANSITION.
- RR-1 AT CPT TO CONC. TRANSITION.
- PROVIDE 60"H WALL TILE ON ALL WALLS. USE MTL-1 AT TOP WITH PT-2 ABOVE & MTL-2 AT COVE BASE TO FLOOR TILE.
- RWS-1 (MANUAL) W/ SSF-1 SILL.

FINISH LEGEND:

	CONC-S		WOM-1
	CPT-1		T-1 1/2 OFFSET
	T-3 SEE 2/701 FOR DETAIL		Room Name T-01 T-01 Finish Base Finish

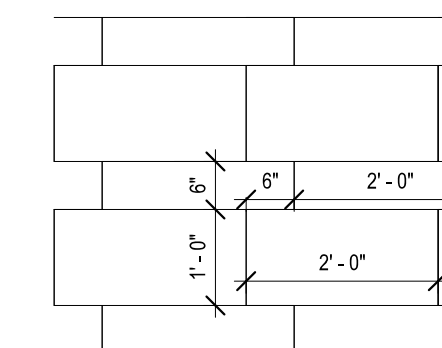

2 A701 T-3 Pattern Detail
1/2" = 1'-0"

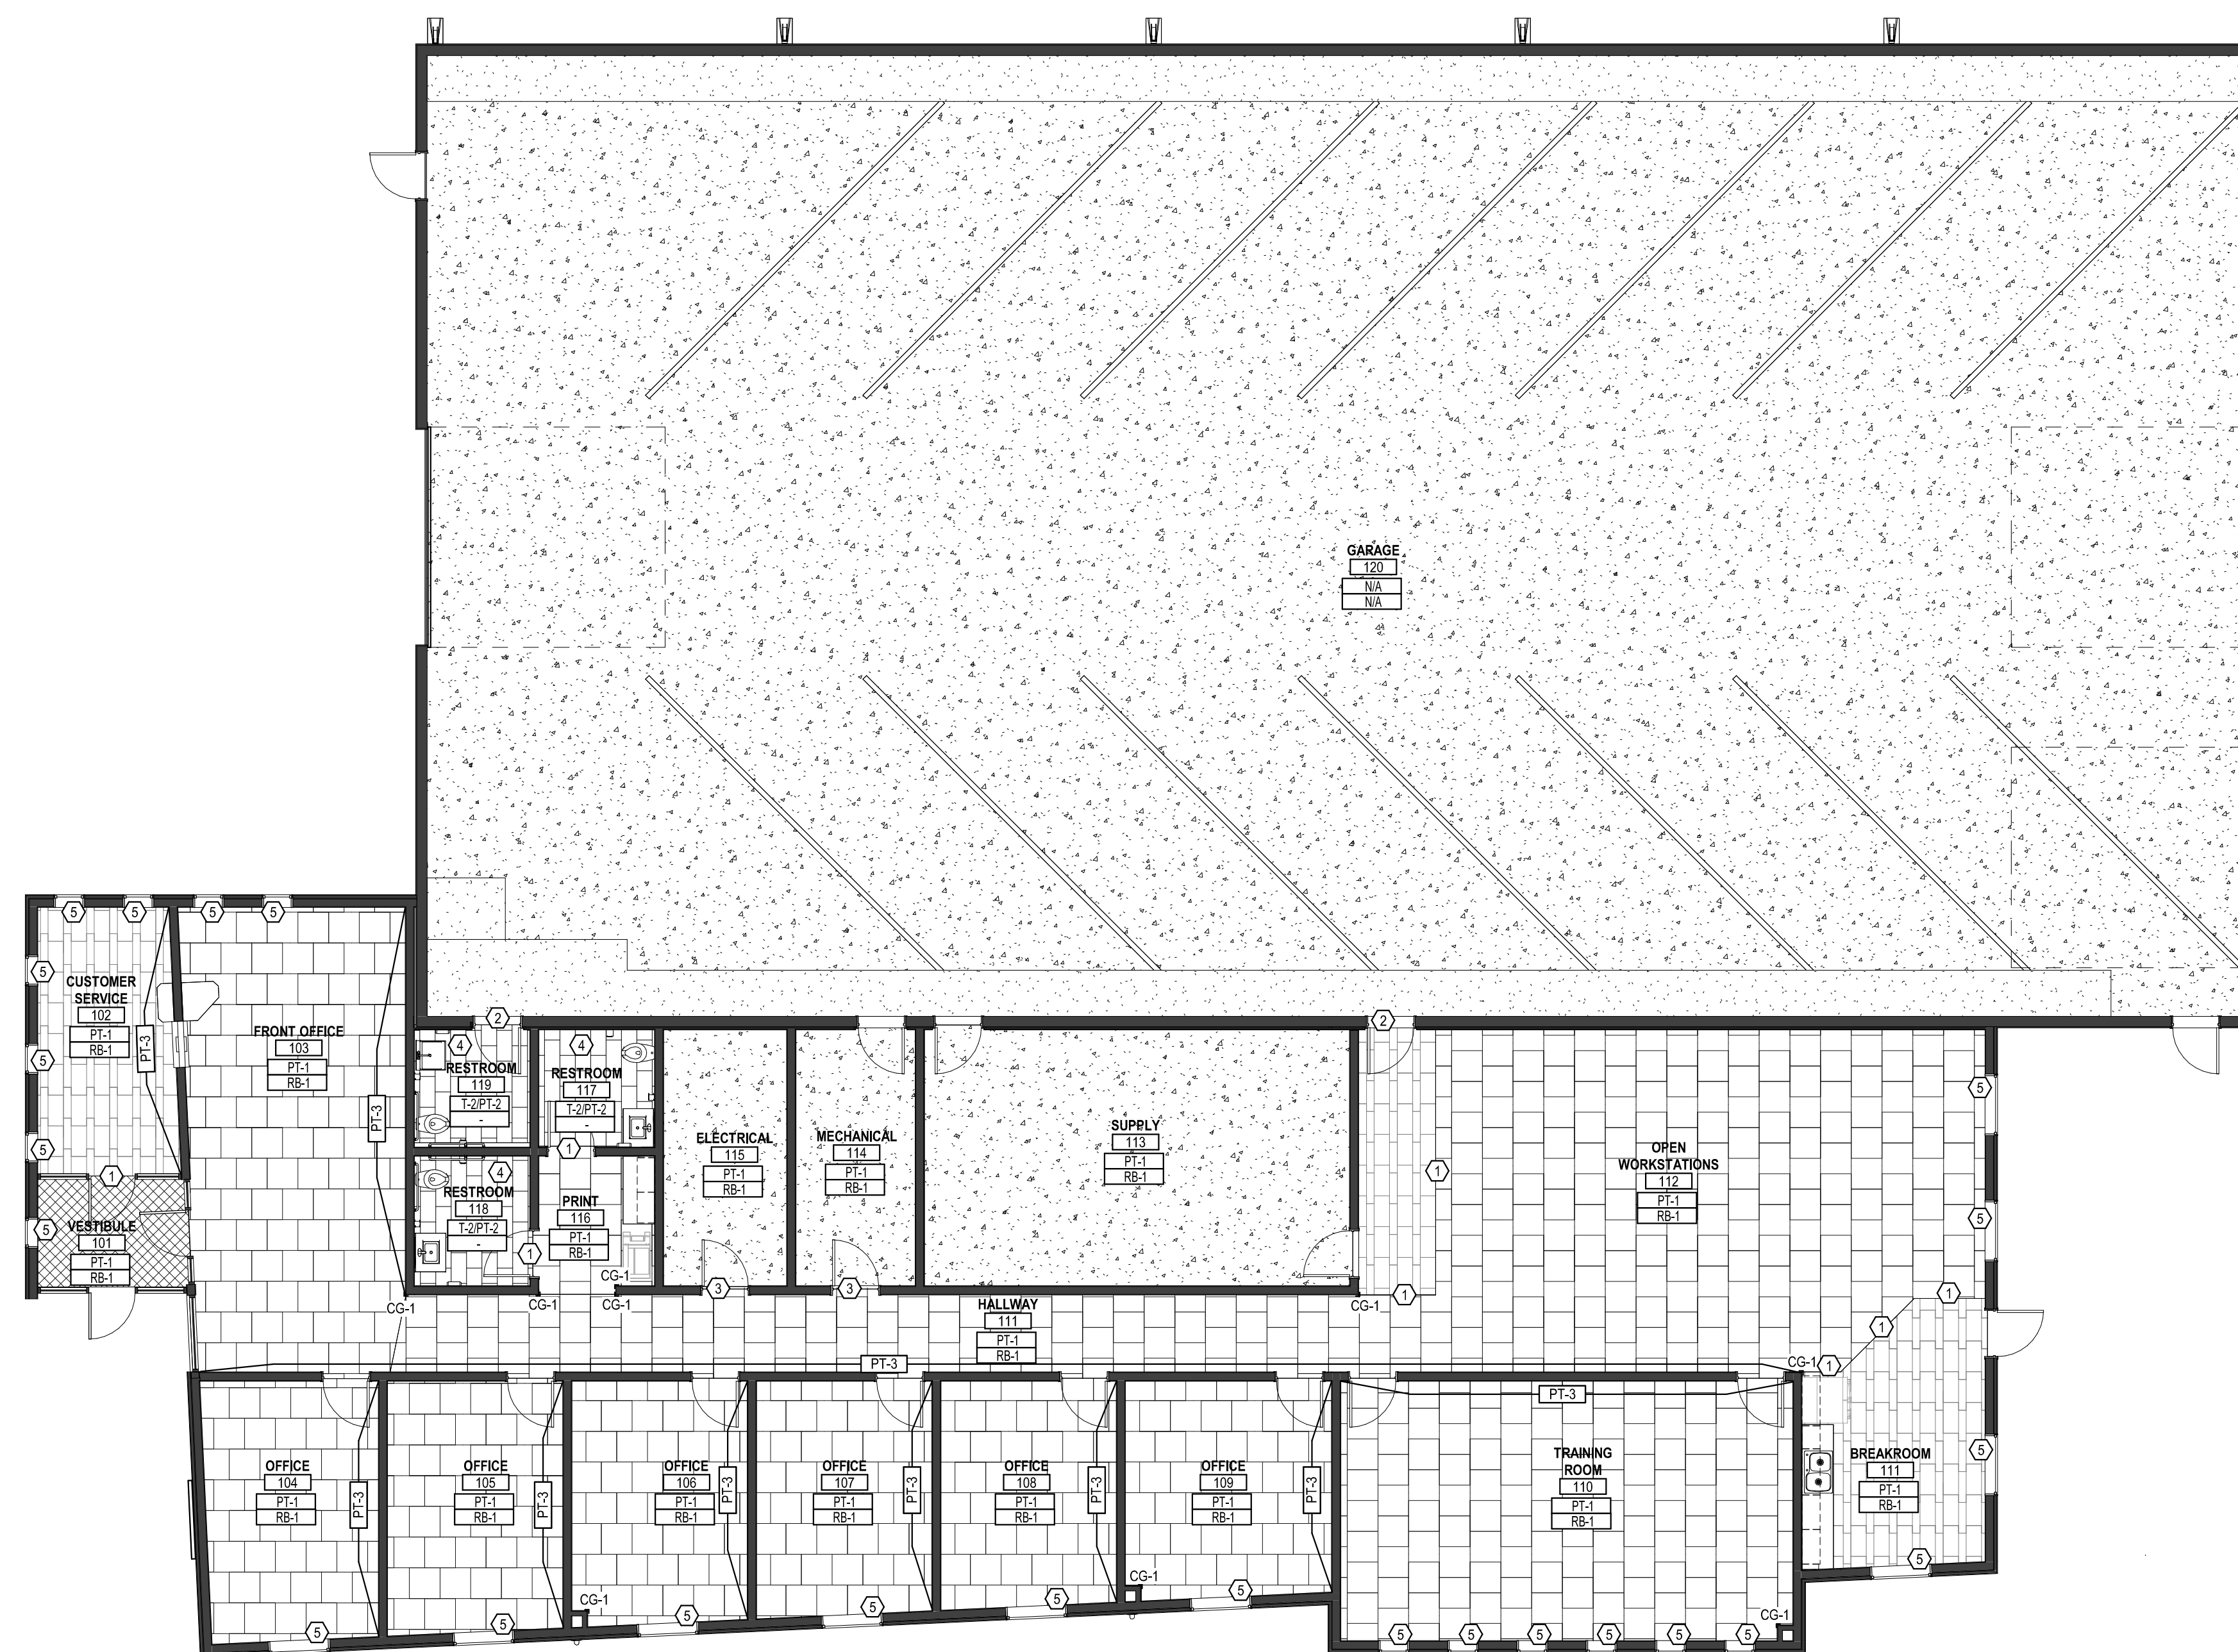

1 A701 First Floor - Finish Plan
1/8" = 1'-0"



DRAWING HISTORY

NO.	DESCRIPTION	DATE
1	CONSTRUCTION DOCUMENTS	01/15/2025

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First Floor Finish Plan

SHEET


A701

NOTES - FURNITURE


1. FURNITURE FOR REFERENCE ONLY, NOT IN CONTRACT.

KEYNOTES - INTERIOR SIGNAGE

- Ⓐ TYPE A - RESTROOM.
- Ⓒ TYPE B - HCP RESTROOM.
- Ⓓ TYPE C - ROOM NUMBER/NAME PLATE.
- Ⓔ TYPE D - ROOM NAME/ROOM NUMBER.
- Ⓕ TYPE E - WORKSTATION NAME PLATE.
- Ⓖ TYPE F - OCCUPANT LOAD.

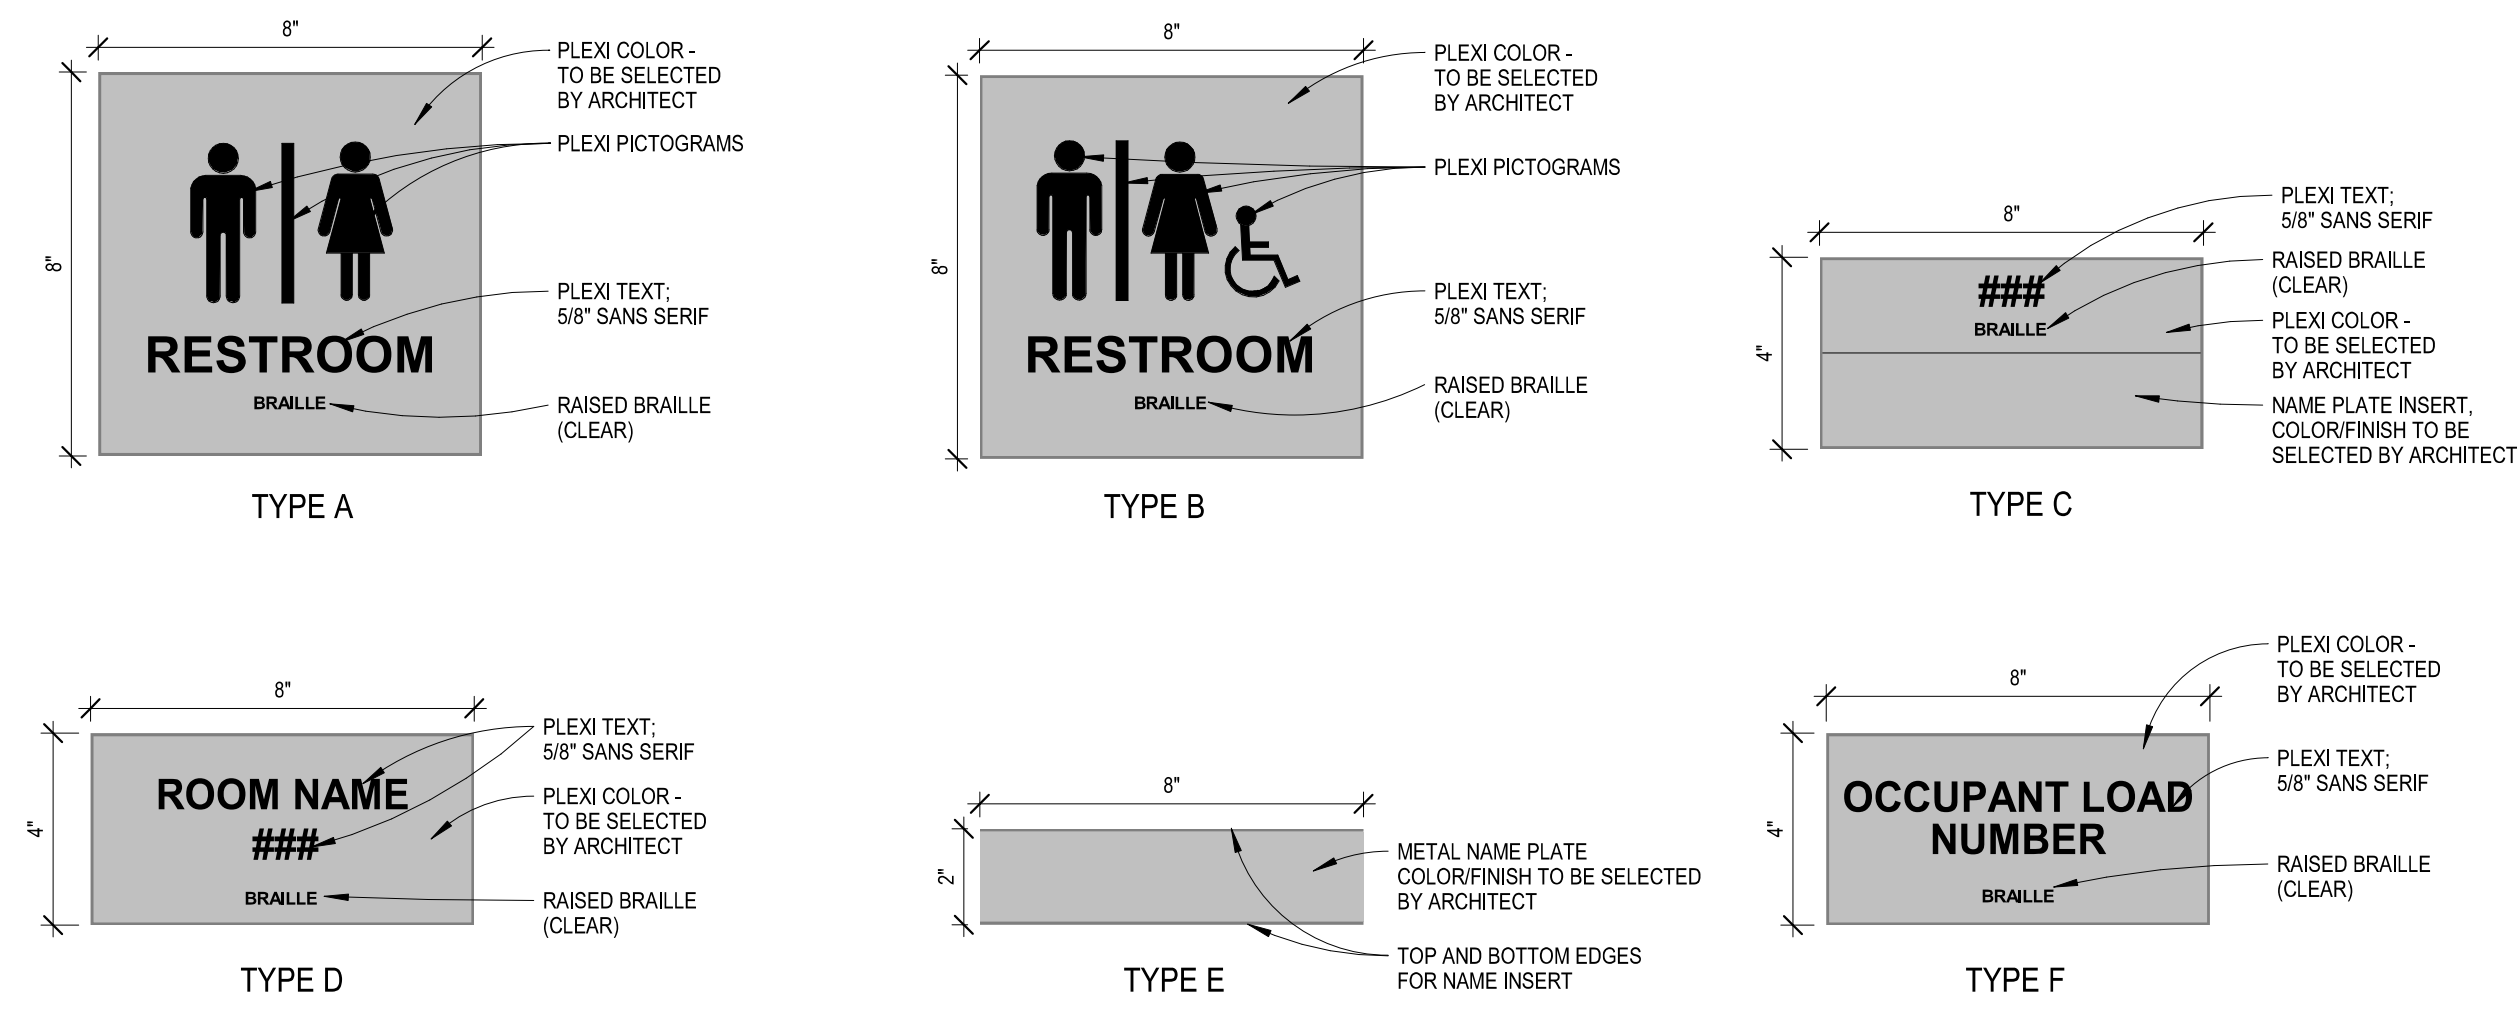

2 A801 Interior Signage Types
3" = 1'-0"

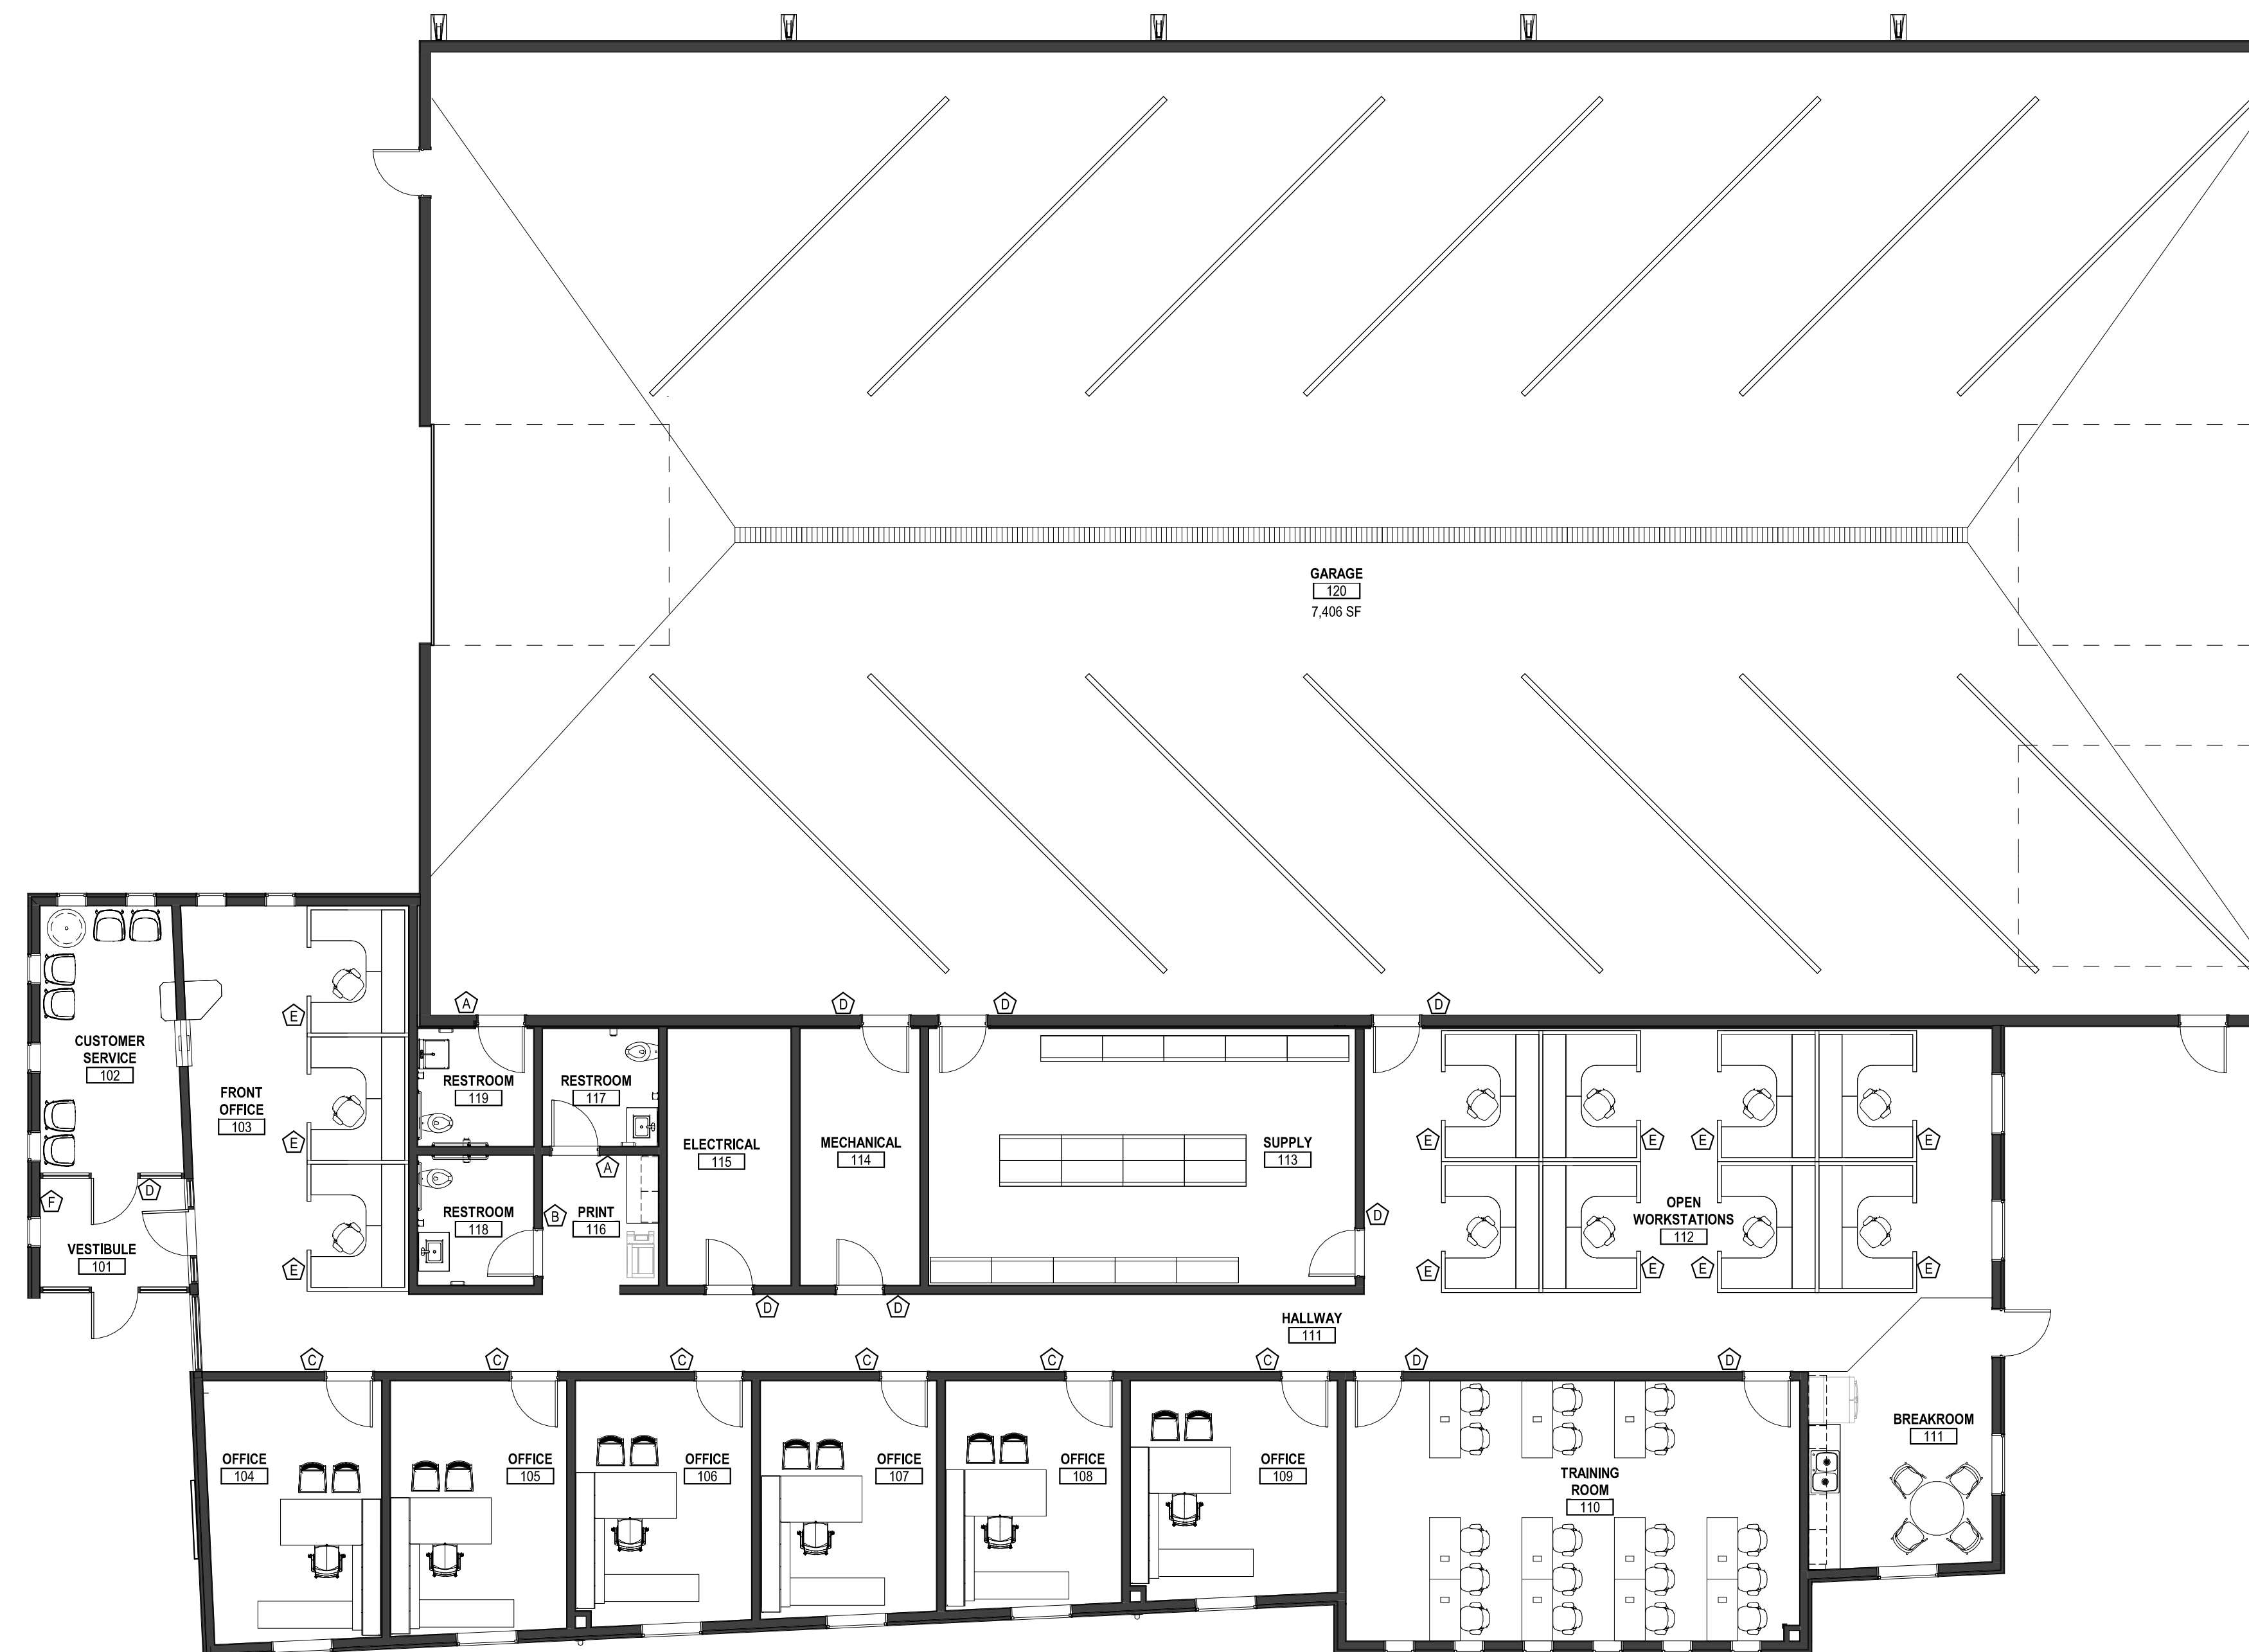

1 A801 First Floor - Furniture Plan
1/8" = 1'-0"



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NO.	DESCRIPTION	DATE
1	CONSTRUCTION DOCUMENTS	01/15/2025

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First Floor Furniture & Signage Plan

SHEET

A801



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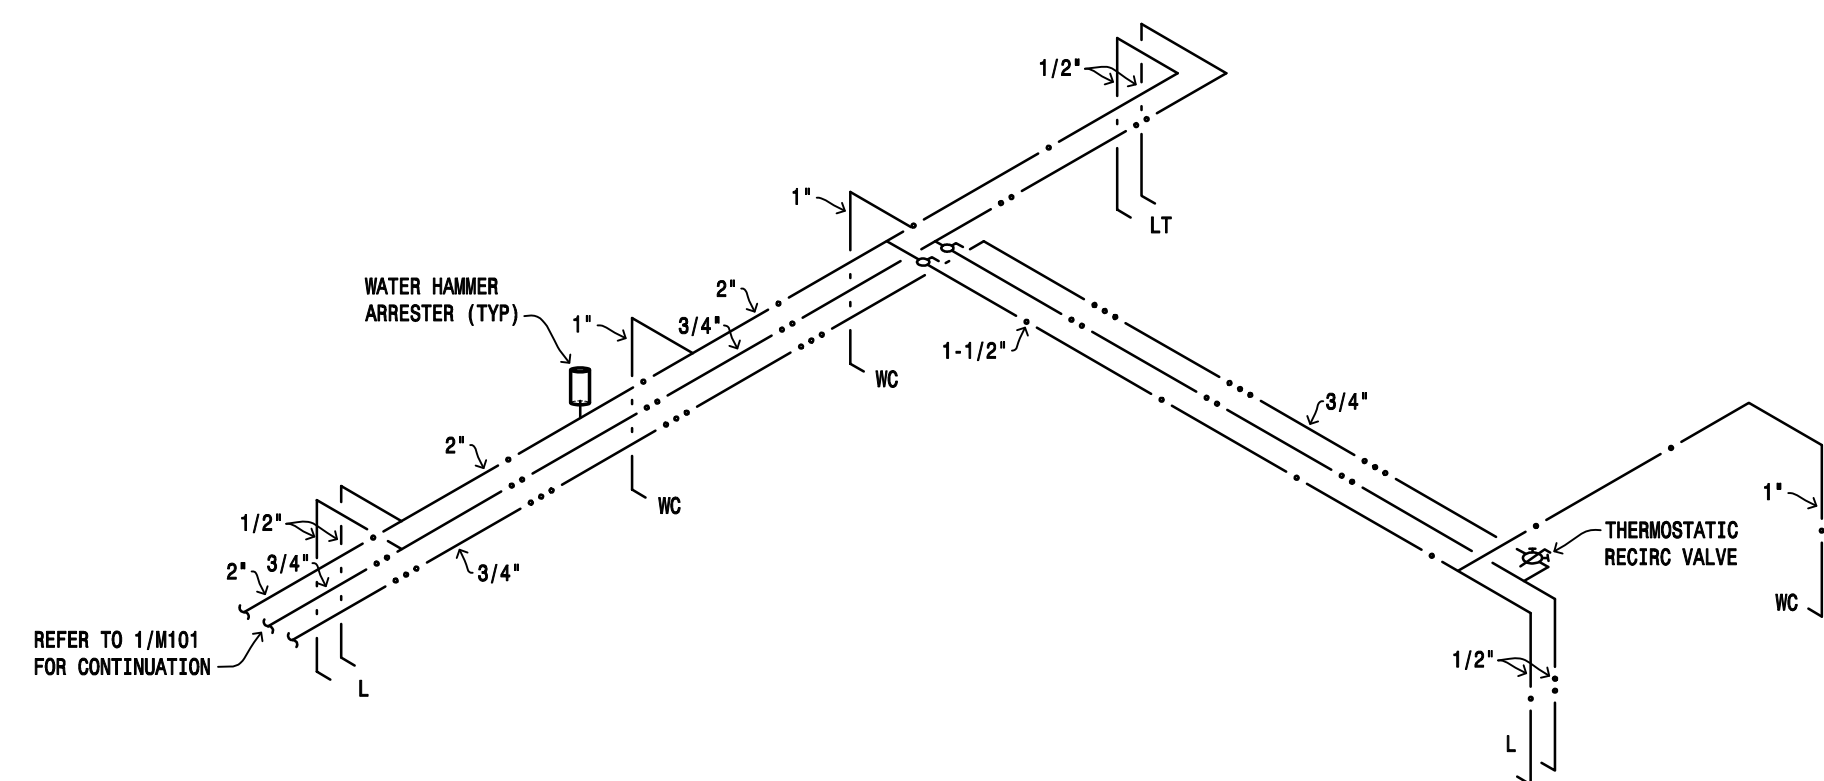
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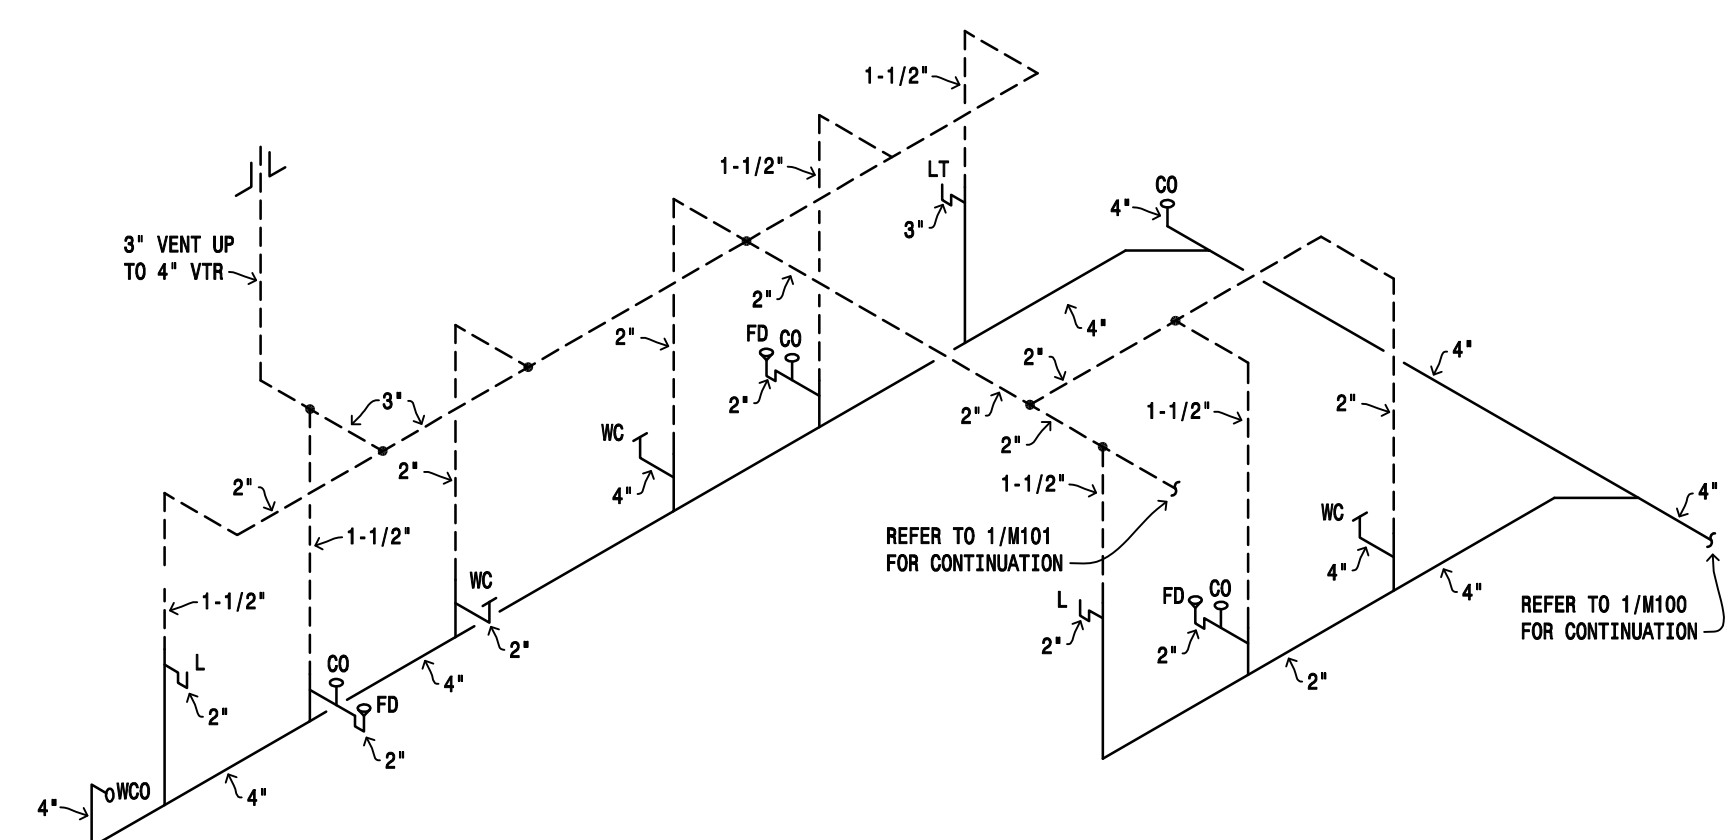
GENERAL NOTES:

- MECHANICAL CONTRACTOR SHALL COORDINATE INSTALLATION OF ALL MECHANICAL EQUIPMENT WITH ALL OTHER TRADES. CONTRACTOR TO VERIFY AND MAINTAIN ALL EQUIPMENT CLEARANCE AS REQUIRED BY CODE AND MANUFACTURERS RECOMMENDATIONS.
- ALL WATER SUPPLIES, STOPS, TRAPS, TAILPIECES, AND FINAL CONNECTIONS SHALL BE PROVIDED BY PLUMBING CONTRACTOR.
- PLUMBING CONTRACTOR SHALL PROVIDE CLEAN OUTS AT THE BASE OF ALL SANITARY AND STORM STACKS.
- PLUMBING CONTRACTOR TO SLEEVE PIPING WHERE REQUIRED. COORDINATE WITH GENERAL CONTRACTOR.
- PROVIDE FIRE CAULK AROUND ALL DUCTWORK AND PIPING AT ALL RATED WALLS AND FLOOR PENETRATIONS. REFER TO THE ARCHITECTS DRAWINGS FOR LOCATIONS OF RATED WALLS AND FLOORS.
- PROVIDE FIRESTOPPING AT PENETRATIONS OF RATED WALLS AND FLOORS. REFER TO THE ARCHITECTS DRAWINGS FOR LOCATIONS OF RATED WALLS AND FLOORS.
- CONTRACTOR TO CONFIRM AND COORDINATE MECHANICAL PENETRATIONS AT EXTERIOR WALLS AND ROOF WITH ARCHITECT AND MECHANICAL ENGINEER PRIOR TO INSTALL.
- ALL DOMESTIC WATER, SANITARY, AND STORM PIPING SHALL BE ROUTED IN A MANNER TO PREVENT PIPE FREEZING. IF CONTRACTOR HAS CONCERNS OR QUESTIONS, CONTACT DESIGN TEAM PRIOR TO INSTALLATION.


PLUMBING ROUGH-IN CONNECTION SCHEDULE				
FIXTURE	WASTE	VENT	CW	HW
FD	2"	1-1/2"	-	-
L	2"	1-1/2"	1/2"	1/2"
LT	3"	1-1/2"	1/2"	1/2"
S	2"	1-1/2"	1/2"	1/2"
WC	4"	2"	1"	-




3 M100 DOMESTIC WATER RISER DIAGRAM
SCALE: NOT-TO-SCALE




2 M100 DRAIN, WASTE, AND VENT RISER DIAGRAM
SCALE: NOT-TO-SCALE

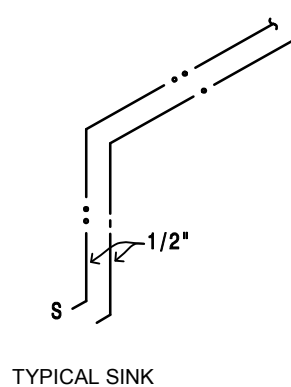


5 M100 DOMESTIC WATER RISER DIAGRAM
SCALE: NOT-TO-SCALE

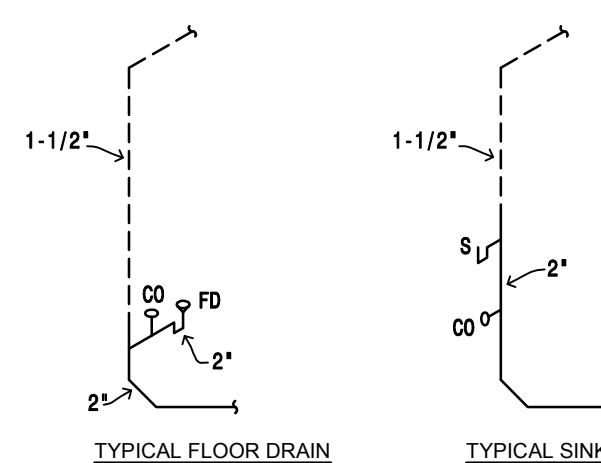

4 M100 DRAIN, WASTE, AND VENT RISER DIAGRAM
SCALE: NOT-TO-SCALE

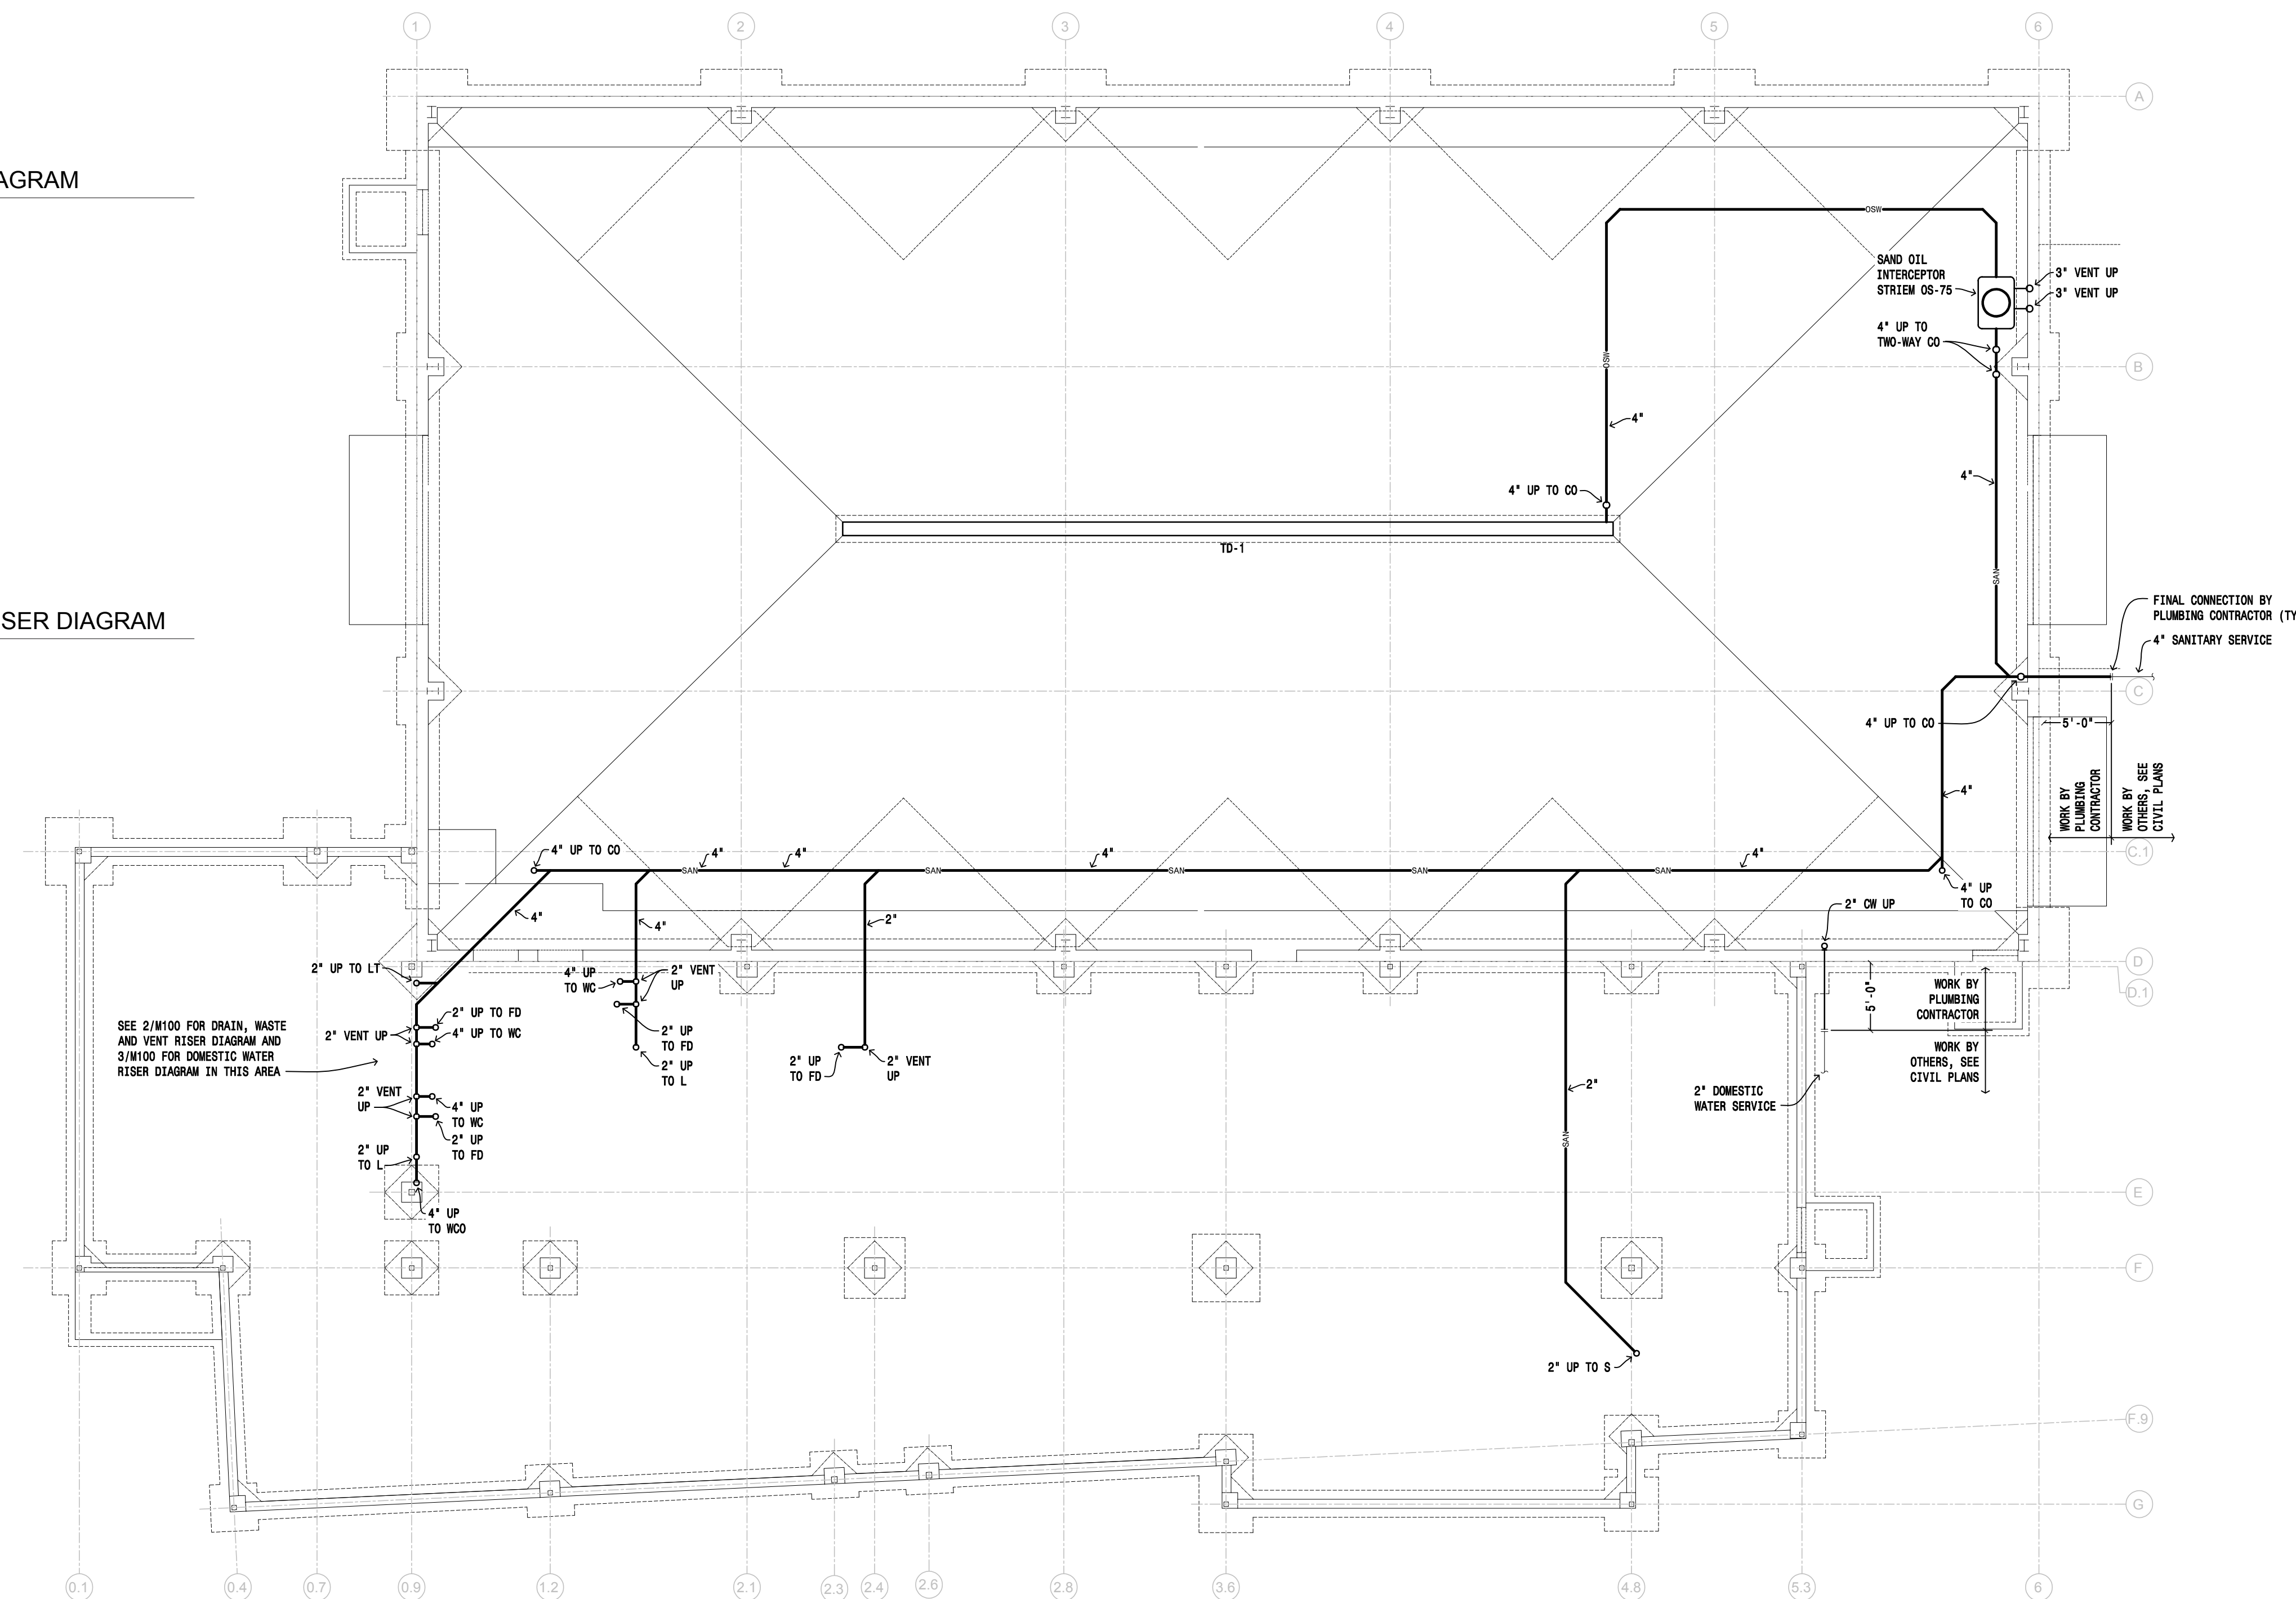

1 M100 FOUNDATION PLAN - UNDERGROUND PLUMBING
1/8" = 1'-0"

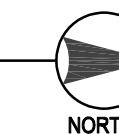

DRAWING HISTORY


NO.	DESCRIPTION	DATE
1	DESIGN DOCUMENTS	01/15/25

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FOUNDATION PLAN -
UNDERGROUND PLUMBING

SHEET

M100



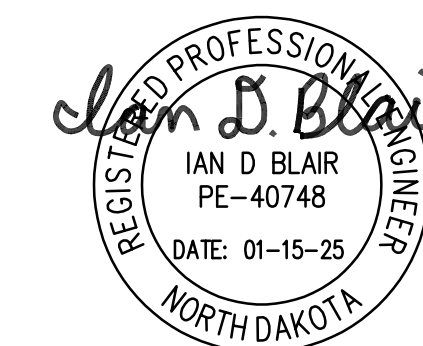

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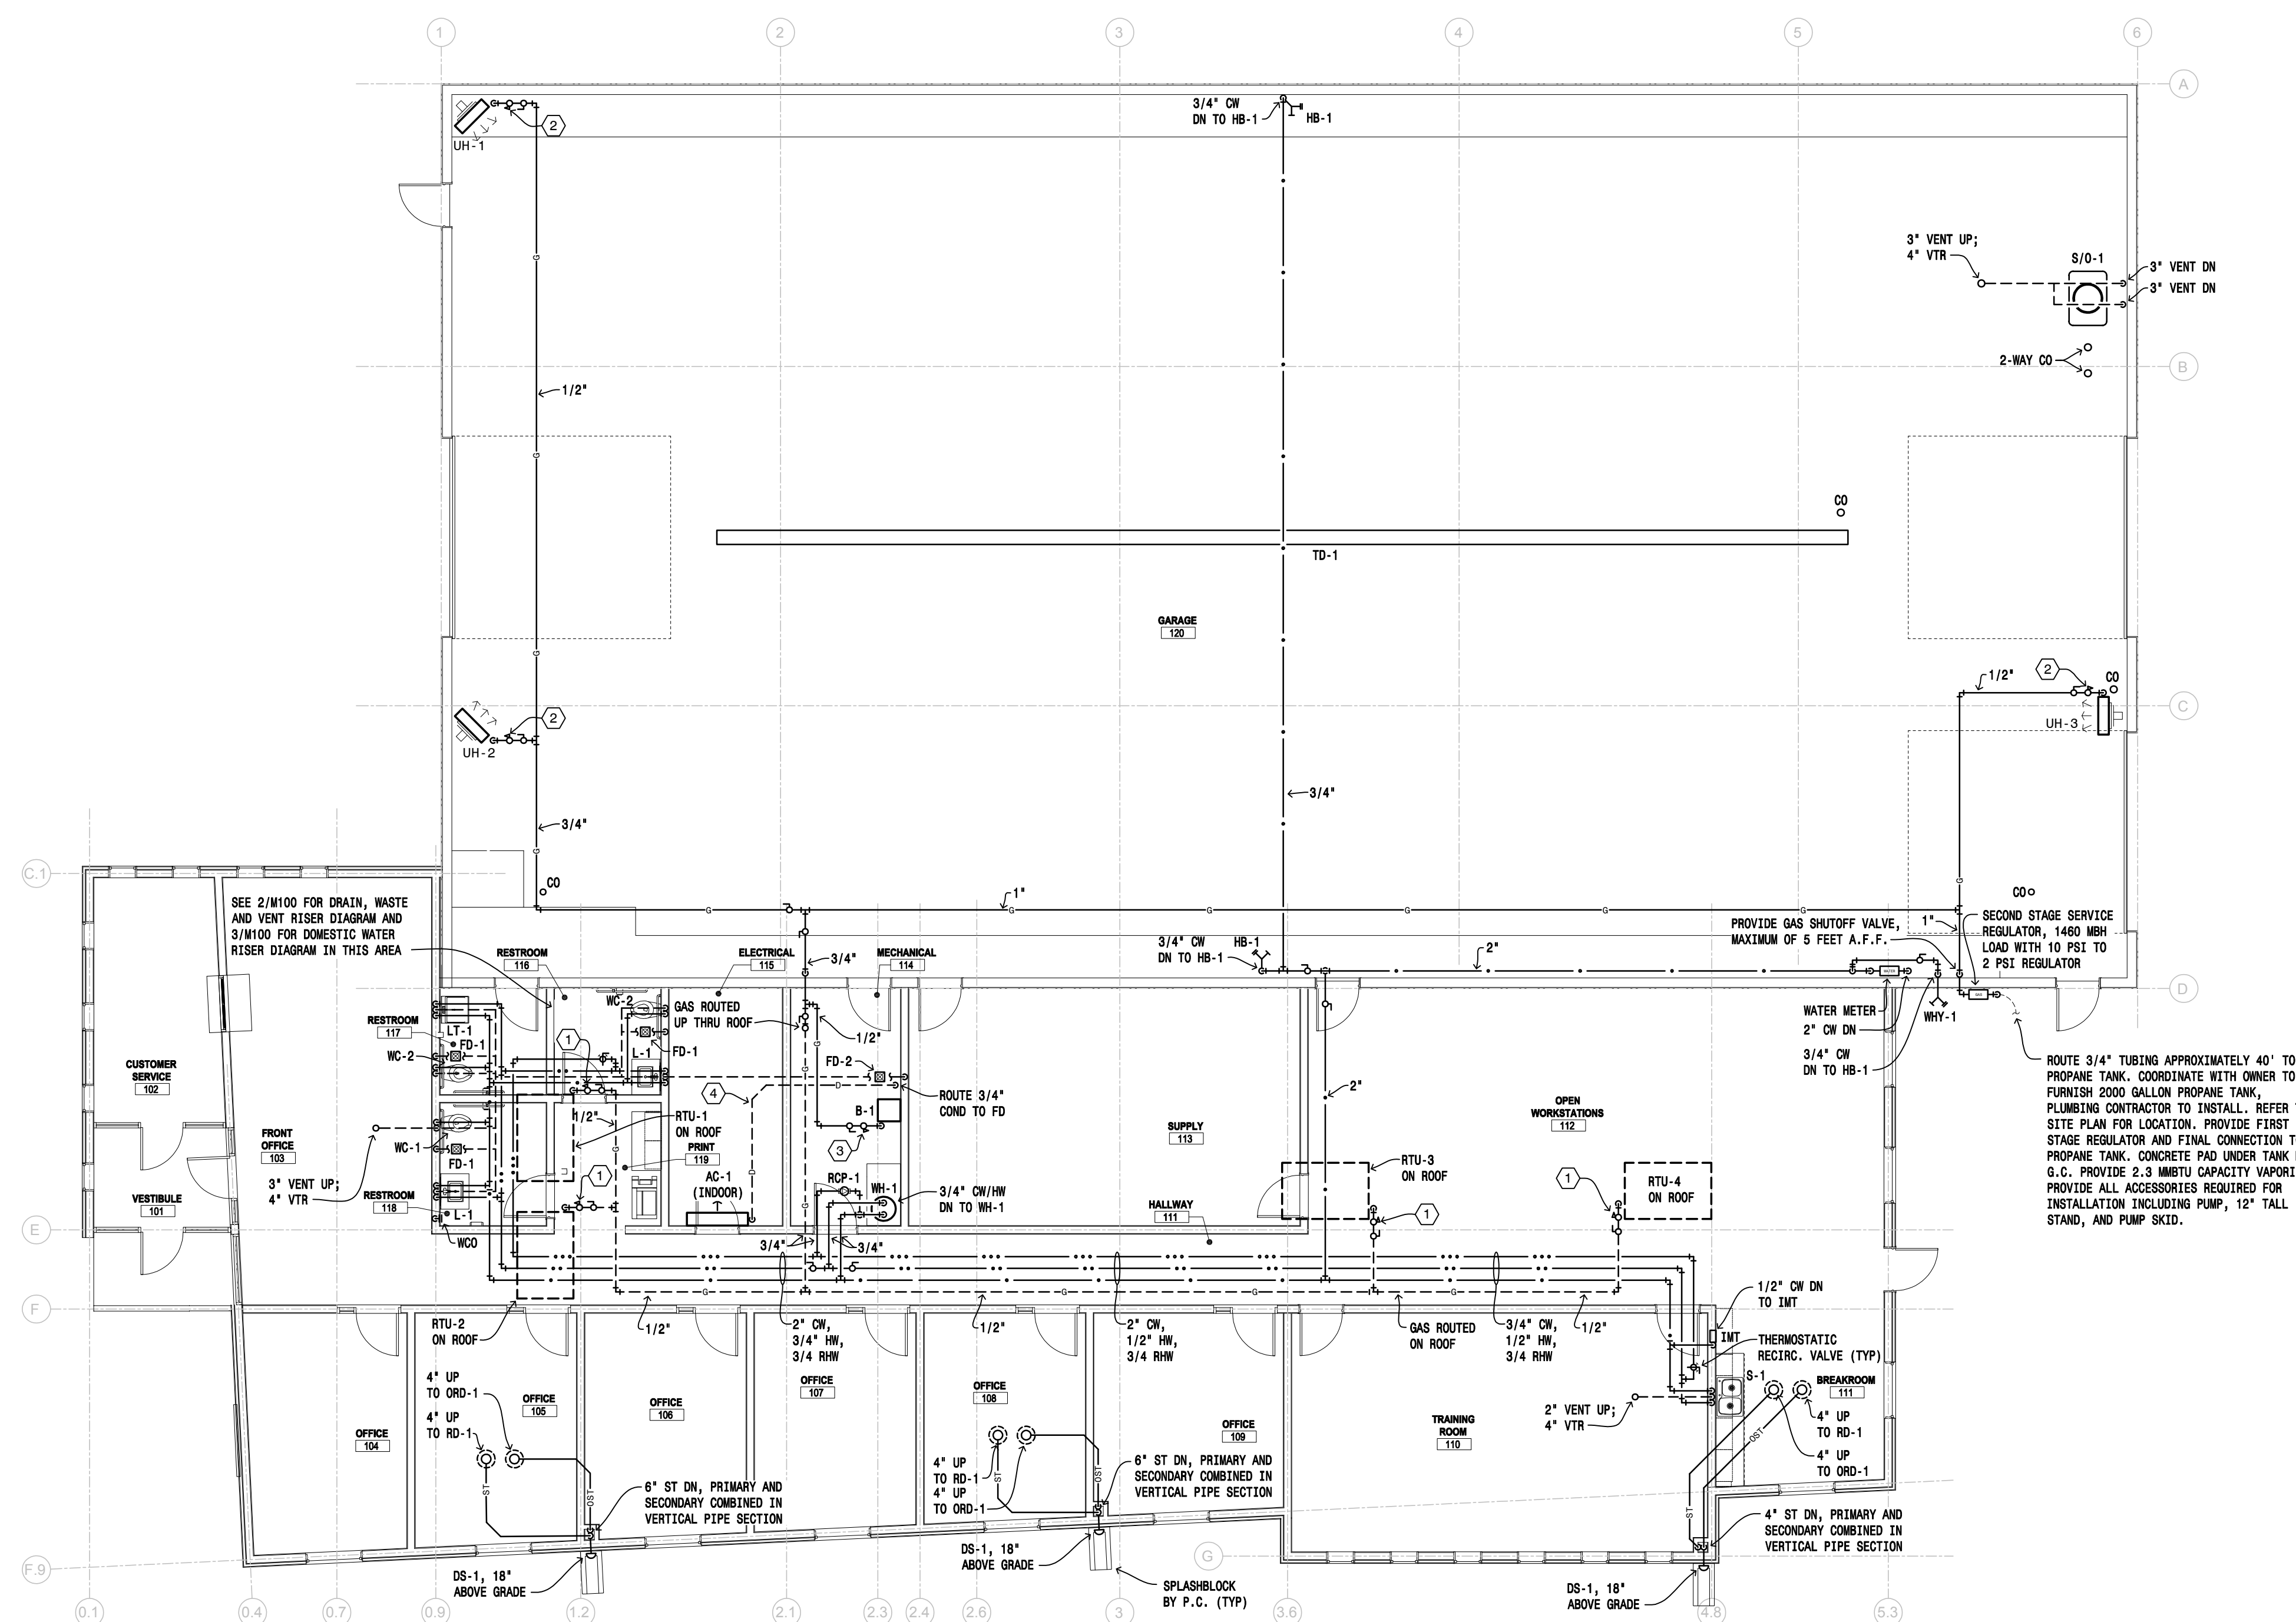
GENERAL NOTES:

- MECHANICAL CONTRACTOR SHALL COORDINATE INSTALLATION OF ALL MECHANICAL EQUIPMENT WITH ALL OTHER TRADES. CONTRACTOR TO VERIFY AND MAINTAIN ALL EQUIPMENT CLEARANCE AS REQUIRED BY CODE AND MANUFACTURERS RECOMMENDATIONS.
- ALL WATER SUPPLIES, STOPS, TRAPS, TAILPIECES, AND FINAL CONNECTIONS SHALL BE PROVIDED BY PLUMBING CONTRACTOR.
- PLUMBING CONTRACTOR SHALL PROVIDE CLEAN OUTS AT THE BASE OF ALL SANITARY AND STORM STACKS.
- PLUMBING CONTRACTOR TO SLEEVE PIPING WHERE REQUIRED. COORDINATE WITH GENERAL CONTRACTOR.
- PROVIDE FIRE CAULK AROUND ALL DUCTWORK AND PIPING AT ALL RATED WALLS AND FLOOR PENETRATIONS. REFER TO THE ARCHITECTS DRAWINGS FOR LOCATIONS OF RATED WALLS AND FLOORS.
- PROVIDE FIRESTOPPING AT PENETRATIONS OF RATED WALLS AND FLOORS. REFER TO THE ARCHITECTS DRAWINGS FOR LOCATIONS OF RATED WALLS AND FLOORS.
- CONTRACTOR TO CONFIRM AND COORDINATE MECHANICAL PENETRATIONS AT EXTERIOR WALLS AND ROOF WITH ARCHITECT AND MECHANICAL ENGINEER PRIOR TO INSTALL.
- ALL DOMESTIC WATER, SANITARY, AND STORM PIPING SHALL BE ROUTED IN A MANNER TO PREVENT PIPE FREEZING. IF CONTRACTOR HAS CONCERNS OR QUESTIONS, CONTACT DESIGN TEAM PRIOR TO INSTALLATION.



PLUMBING ROUGH-IN CONNECTION SCHEDULE				
FIXTURE	WASTE	VENT	CW	HW
FD	2"	1-1/2"	-	-
L	2"	1-1/2"	1/2"	1/2"
MB	3"	1-1/2"	1/2"	1/2"
S	2"	1-1/2"	1/2"	1/2"
WC	4"	2"	1"	-

PLAN NOTES:

- ROUTE 1/2" LP FROM REGULATOR TO RTU AND PROVIDE SHUTOFF VALVE, DIRT LEG, AND UNIONS. 2 PSIG TO 7" W.C. REGULATOR AT EQUIPMENT.
- ROUTE 3/4" LP FROM REGULATOR TO UNIT HEATER AND PROVIDE SHUTOFF VALVE, DIRT LEG, AND UNIONS. 2 PSIG TO 7" W.C. REGULATOR AT EQUIPMENT.
- ROUTE 1/2" LP FROM REGULATOR TO BOILER AND PROVIDE SHUTOFF VALVE, DIRT LEG, AND UNIONS. 2 PSIG TO 7" W.C. REGULATOR AT EQUIPMENT.
- COORDINATE CONDENSATE ROUTING WITH ELECTRICAL EQUIPMENT.



1 M101 FIRST FLOOR PLAN - PLUMBING
1/8" = 1'-0"

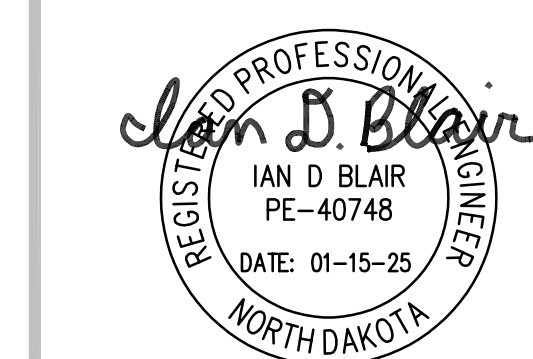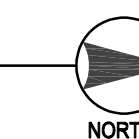

DRAWING HISTORY

NO.	DESCRIPTION	DATE
1	DESIGN DOCUMENTS	01/15/25

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FIRST FLOOR PLAN - PLUMBING

SHEET

M101



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GENERAL NOTES:



- COORDINATE DUCTWORK ROUTING WITH OTHER TRADES TO ALLOW FOR SUFFICIENT SPACE TO ROUTE DUCTWORK.
- MECHANICAL CONTRACTOR SHALL COORDINATE INSTALLATION OF ALL MECHANICAL EQUIPMENT WITH ALL OTHER TRADES. CONTRACTOR TO VERIFY AND MAINTAIN ALL EQUIPMENT CLEARANCES AS REQUIRED BY CODE AND MANUFACTURERS RECOMMENDATIONS.
- INTAKE AIR MUST BE ROUTED A MINIMUM OF 10'-0" AWAY FROM ANY EXHAUST DUCT OUTLETS. INTAKE WALL CAPS SHALL HAVE INSECT/BIRDSCREEN BARRIER AND CAULK AROUND PERIMETER OF CAP (TYPICAL).
- PROVIDE FIRE CAULK AROUND ALL DUCTWORK AND PIPING AT ALL RATED WALLS AND FLOOR PENETRATIONS.

PLAN NOTES:

- COMBUSTION AIR AND VENT PIPING. SIZE AND TERMINATE PER MANUFACTURER'S REQUIREMENTS.
- 18x12 SA/RA UP TO ROOFTOP UNIT.
- COORDINATE WITH GENERAL CONTRACTOR FOR OPENING SIZES AND LOCATIONS FOR DIFFUSER INSTALLATION IN WOOD PLANK CEILING. CEILING OPENINGS WILL BE CUT BY GENERAL CONTRACTOR.
- ELECTRIC HEAT BY DIVISION 26.

TEMPERATURE CONTROLS NOTES:

- PROVIDE ALL CONTROL WIRING BETWEEN ROOFTOP UNIT AND ASSOCIATED THERMOSTAT.
- PROVIDE ALL CONTROL WIRING BETWEEN ALL UNIT HEATERS AND ASSOCIATED THERMOSTATS.
- PROVIDE ALL CONTROL WIRING BETWEEN OUTSIDE AIR MOTORIZED DAMPER, EXHAUST FANS, AND CO/NO2 SENSOR.
- PROVIDE ALL CONTROL WIRING BETWEEN AIR CONDITIONER AND ASSOCIATED THERMOSTAT.
- PROVIDE ALL CONTROL WIRING BETWEEN TANKER THERMOSTATS, CIRCULATING PUMPS, AND BOILERS.
- EF-3: PROVIDE WITH TIMELOCK TO OPERATE DURING OCCUPIED HOURS.

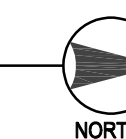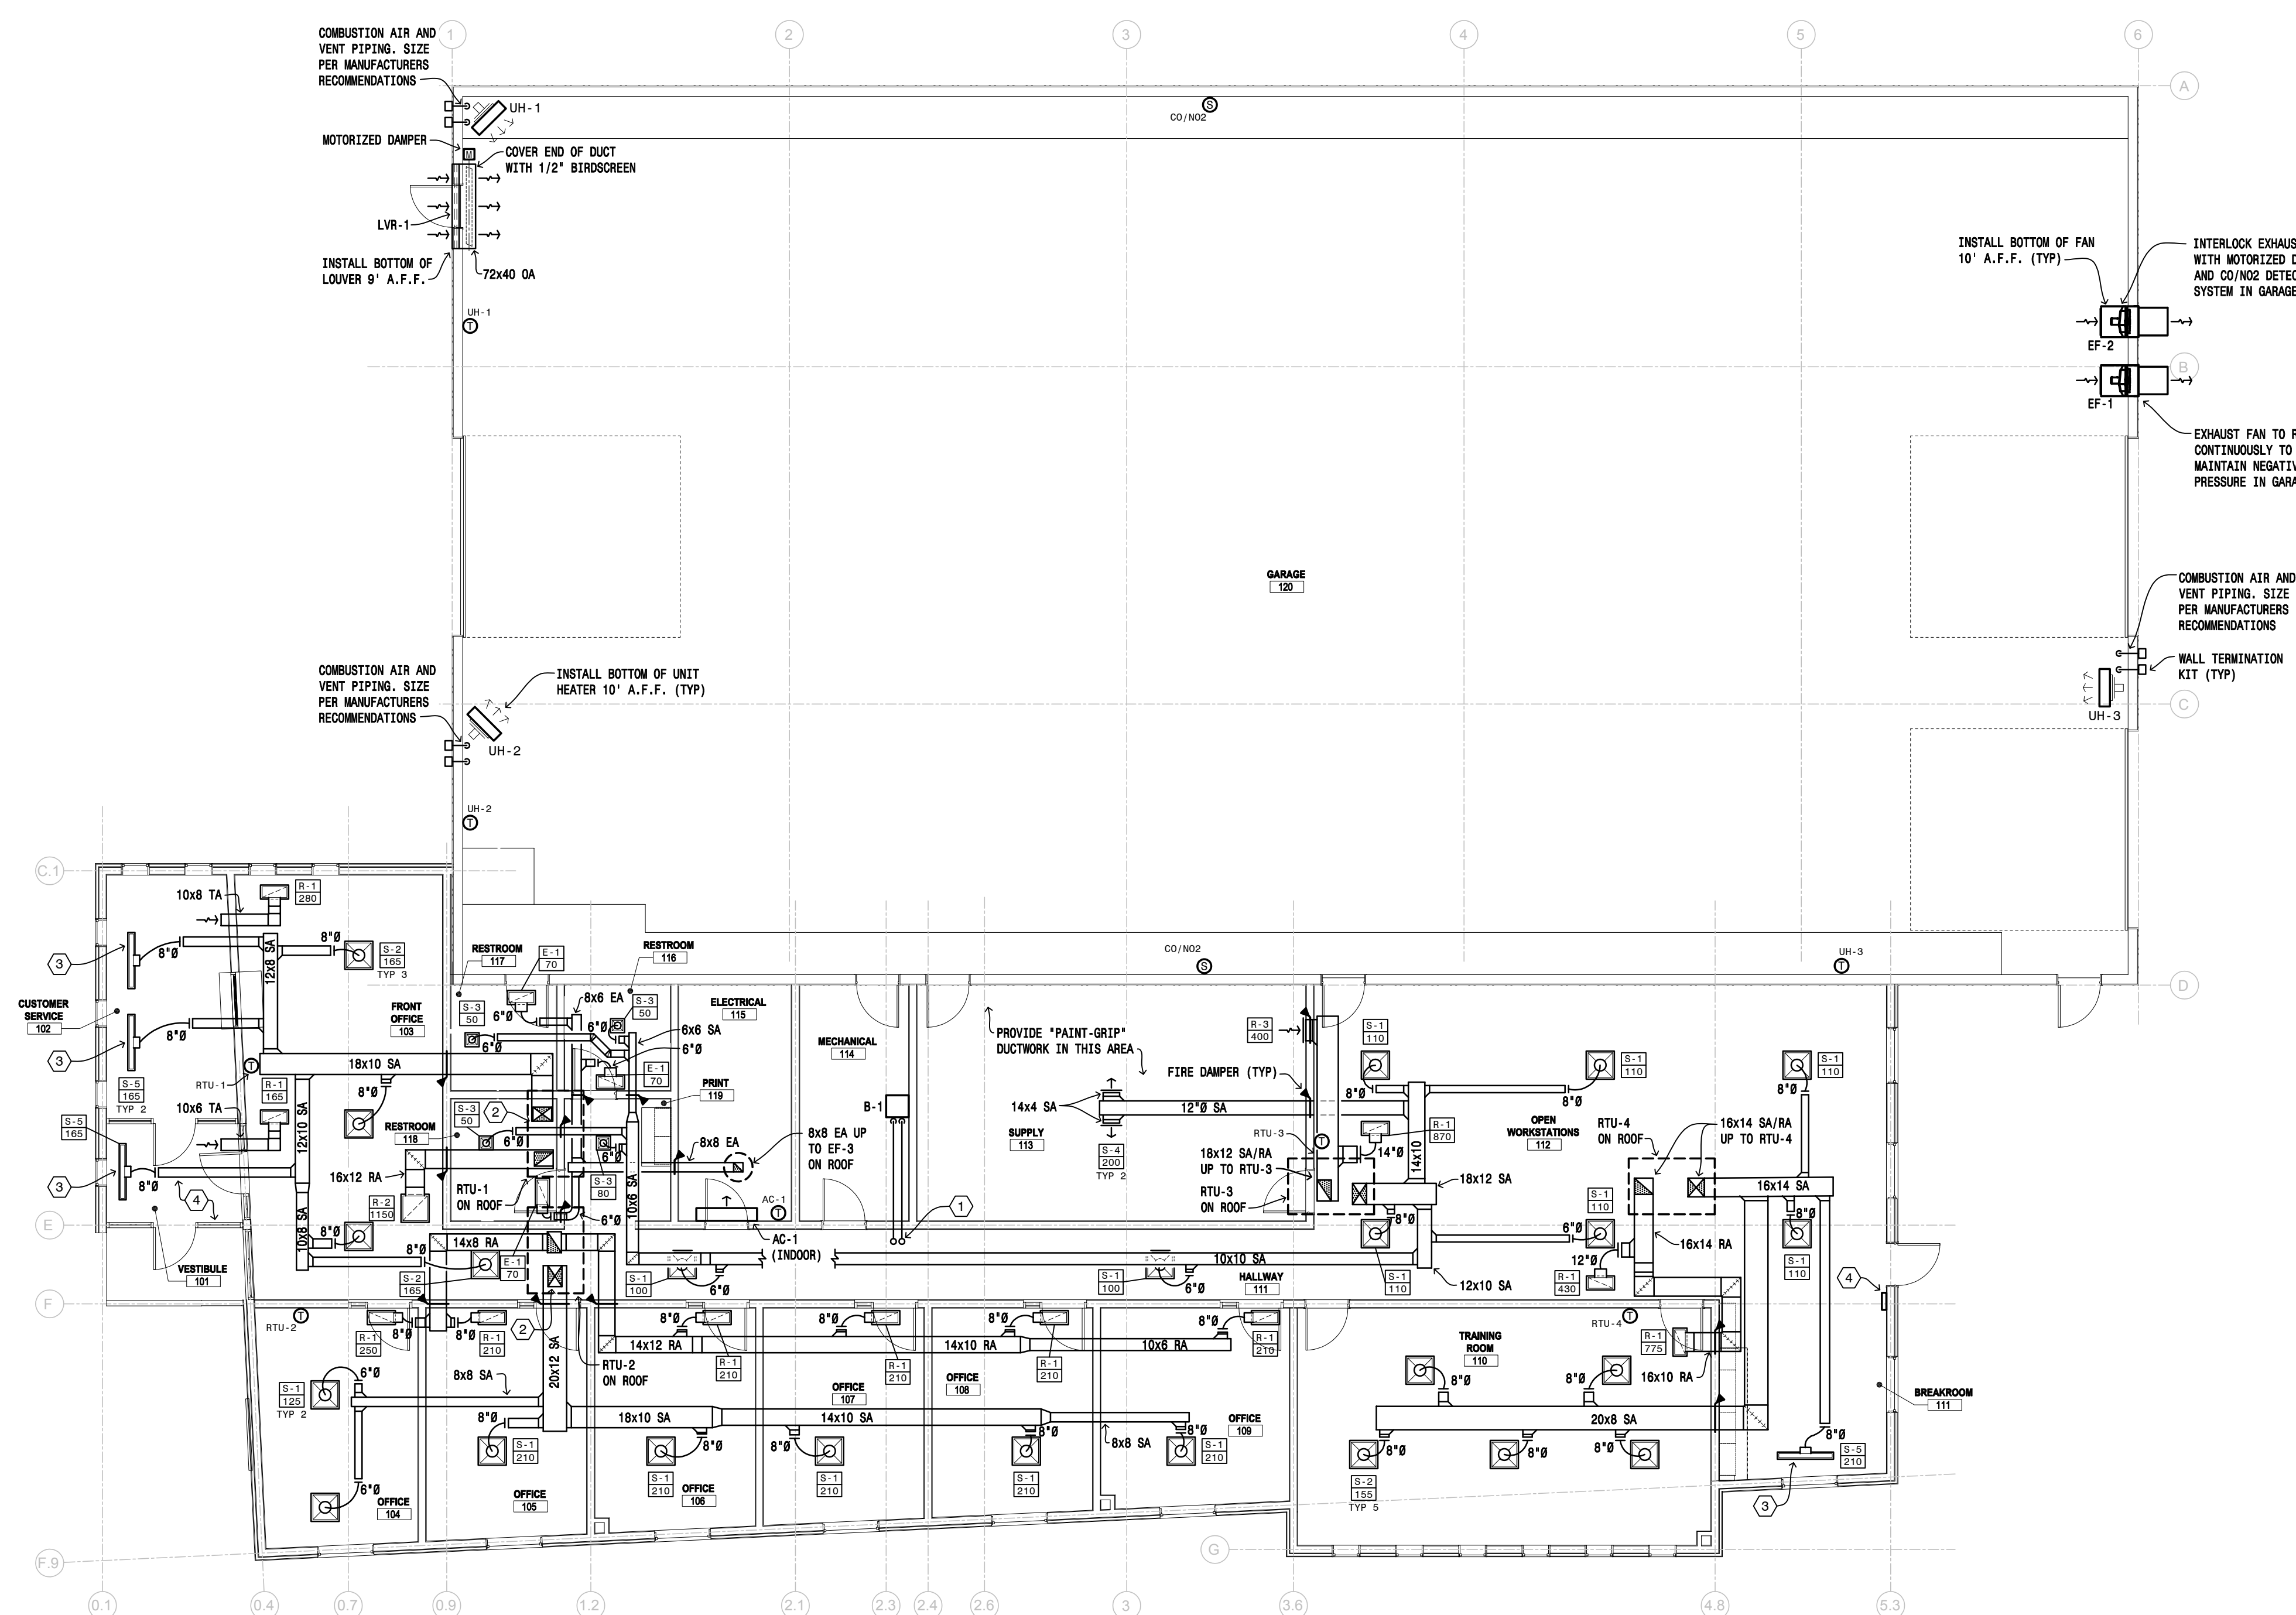

DRAWING HISTORY


NO.	DESCRIPTION	DATE
1	DESIGN DOCUMENTS	01/15/25

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**FIRST FLOOR PLAN -
VENTILATION**

SHEET

M200



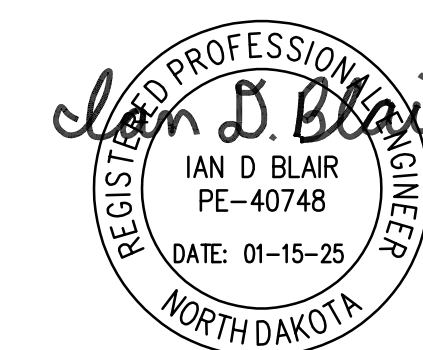

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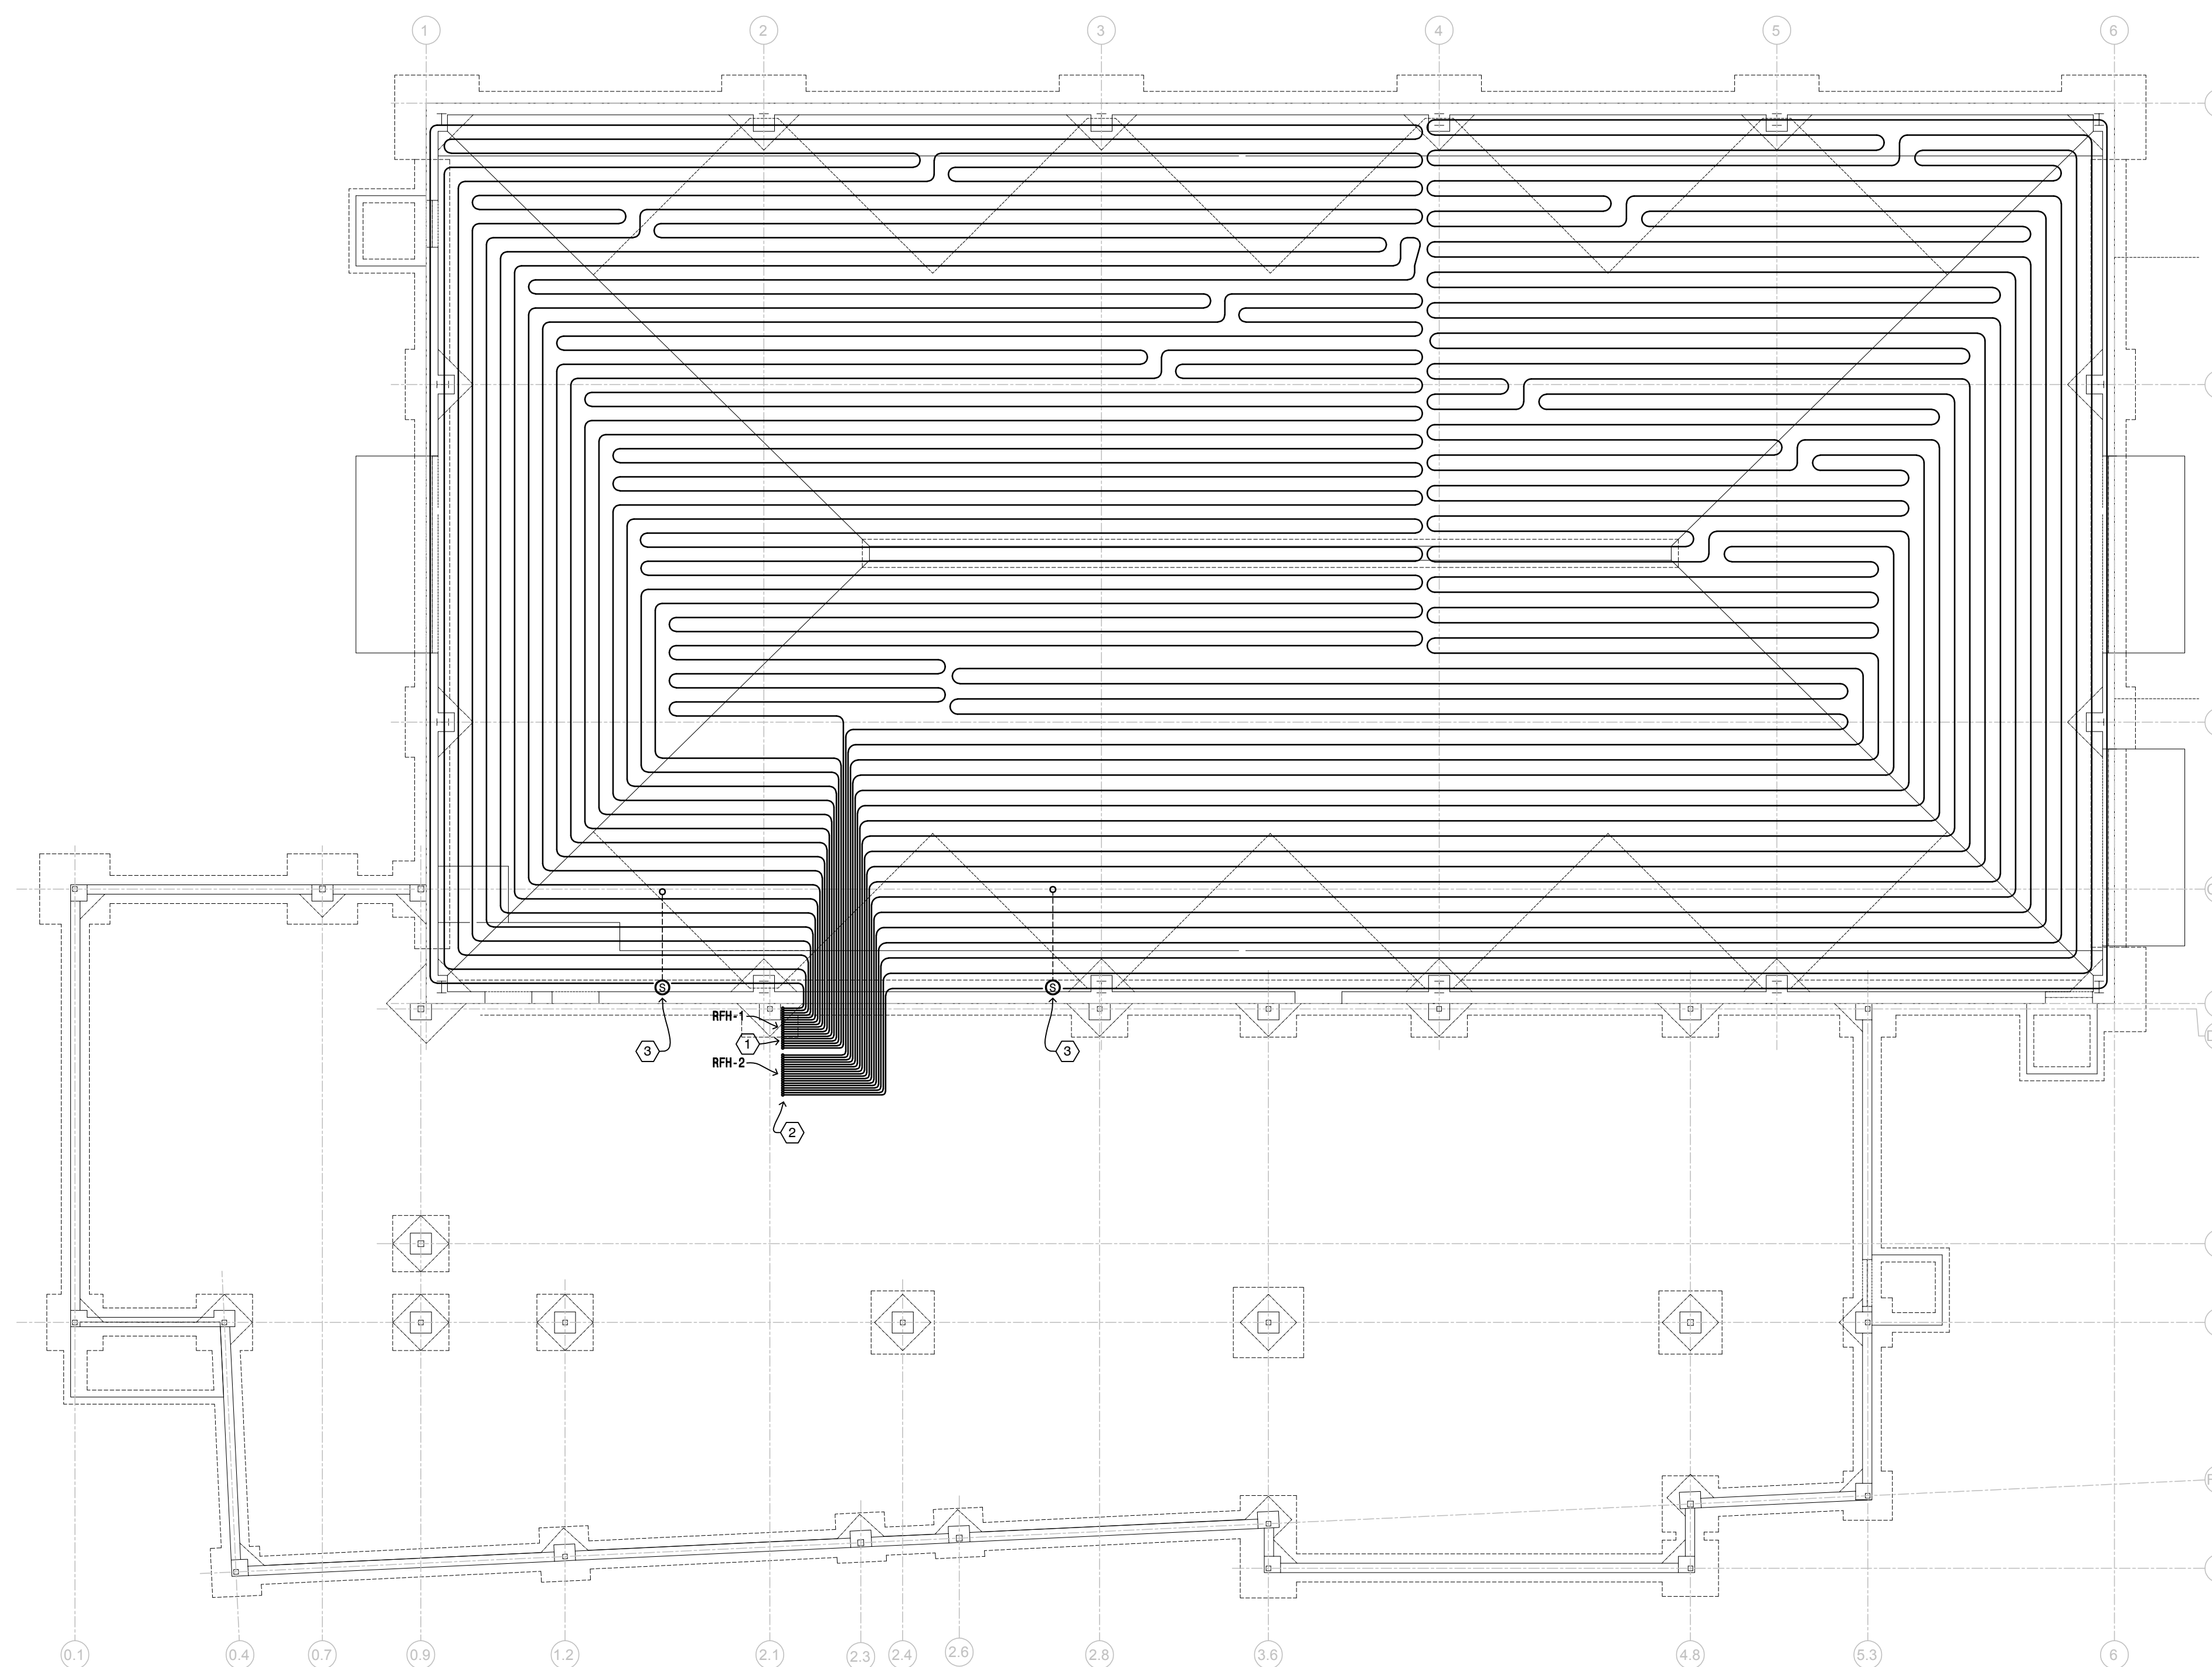
MBN ENGINEERING, INC.
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GENERAL NOTES:

- MECHANICAL CONTRACTOR SHALL COORDINATE INSTALLATION OF ALL MECHANICAL EQUIPMENT IN THE MECHANICAL ROOM WITH ALL OTHER TRADES. CONTRACTOR TO VERIFY AND MAINTAIN ALL EQUIPMENT CLEARANCES AS REQUIRED BY CODE AND MANUFACTURERS RECOMMENDATIONS.
- CONTRACTOR SHALL COORDINATE MECHANICAL PENETRATIONS AND CORE DRILLED FLOOR PENETRATIONS WITH ARCHITECT AND OTHER DISCIPLINES PRIOR TO INSTALL.
- PROVIDE FIRE CAULK AROUND ALL PIPING AT ALL RATED WALLS AND FLOOR PENETRATIONS.

PLAN NOTES:



- INSTALL RADIANT FLOOR HEATING RFH-1, 9 LOOPS TOTAL, 420' AVERAGE LENGTH, 5/8" TUBING AT 12° O.C., 9.9 GPM TOTAL. TUBING INSULATION INSTALLED BY MECHANICAL CONTRACTOR.
- INSTALL RADIANT FLOOR HEATING RFH-2, 9 LOOPS TOTAL, 425' AVERAGE LENGTH, 5/8" TUBING AT 12° O.C., 10.1 GPM TOTAL. TUBING INSULATION INSTALLED BY MECHANICAL CONTRACTOR.
- TERMAR THERMOSTAT BY MECHANICAL CONTRACTOR.



1 M300

FOUNDATION PLAN - UNDERGROUND HYDRONIC

1/8" = 1'-0"

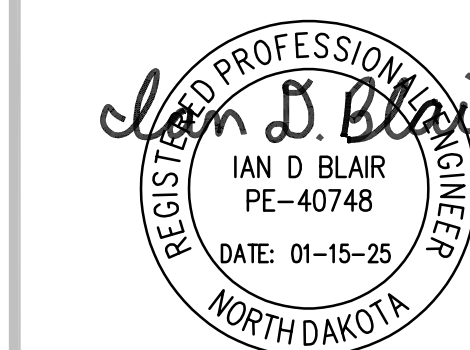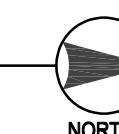

DRAWING HISTORY

NO.	DESCRIPTION	DATE
1	DESIGN DOCUMENTS	01/15/25

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**FOUNDATION PLAN -
UNDERGROUND HYDRONIC**

SHEET

M300



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GENERAL NOTES:


- MECHANICAL CONTRACTOR SHALL COORDINATE INSTALLATION OF ALL MECHANICAL EQUIPMENT IN THE MECHANICAL ROOM WITH ALL OTHER TRADES. CONTRACTOR TO VERIFY AND MAINTAIN ALL EQUIPMENT CLEARANCES AS REQUIRED BY CODE AND MANUFACTURERS RECOMMENDATIONS.
- CONTRACTOR SHALL COORDINATE MECHANICAL PENETRATIONS AND CORE DRILLED FLOOR PENETRATIONS WITH ARCHITECT AND OTHER DISCIPLINES PRIOR TO INSTALL.
- PROVIDE FIRE CAULK AROUND ALL PIPING AT ALL RATED WALLS AND FLOOR PENETRATIONS.

PLAN NOTES:

- REFRIGERANT PIPING. SIZE PER MANUFACTURER'S REQUIREMENTS.



TEMPERATURE CONTROLS NOTES:

- PROVIDE ALL CONTROL WIRING BETWEEN TEQMAR THERMOSTATS, CIRCULATING PUMPS, AND BOILERS.

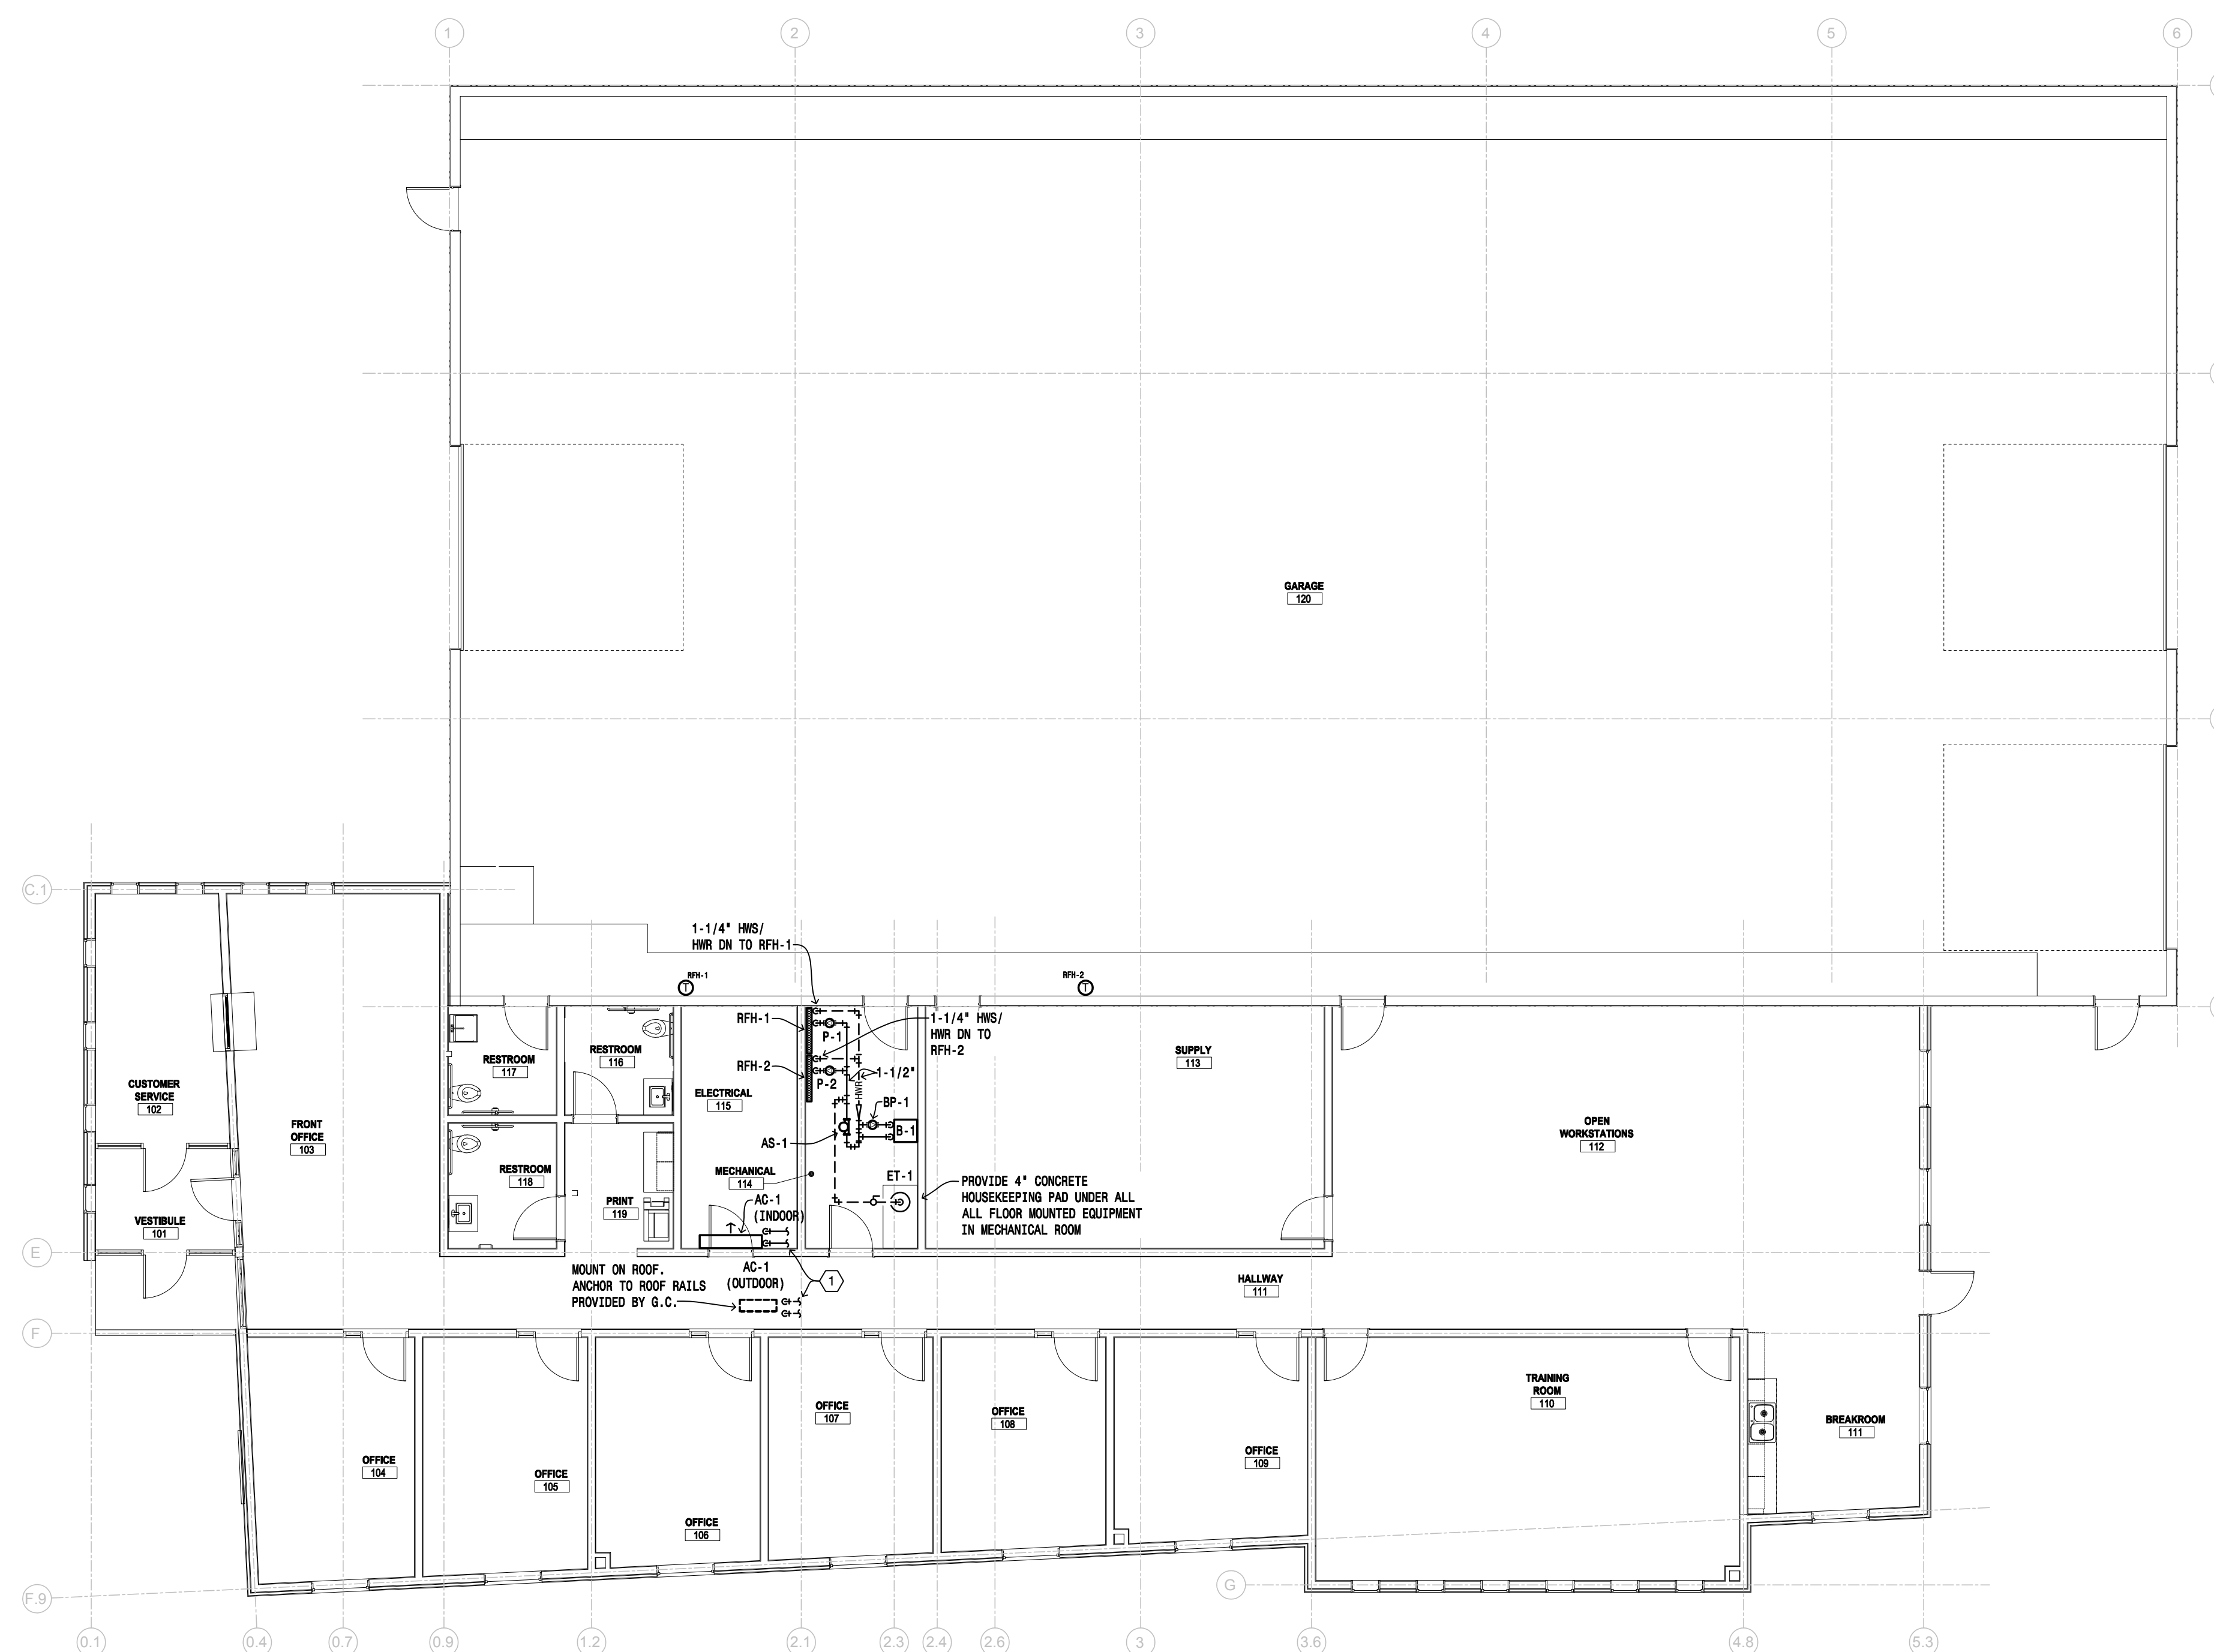

1 M301 FIRST FLOOR PLAN - HYDRONIC

1/8" = 1'-0"

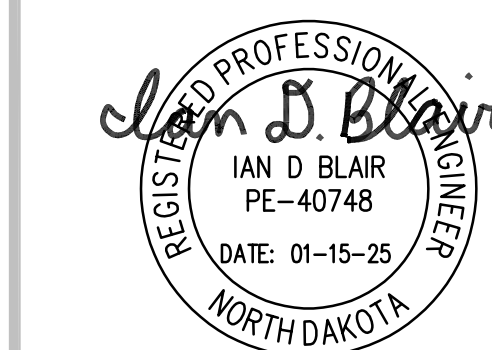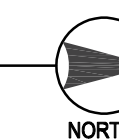

DRAWING HISTORY

NO.	DESCRIPTION	DATE
1	DESIGN DOCUMENTS	01/15/25

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FIRST FLOOR PLAN - HYDRONIC

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M301



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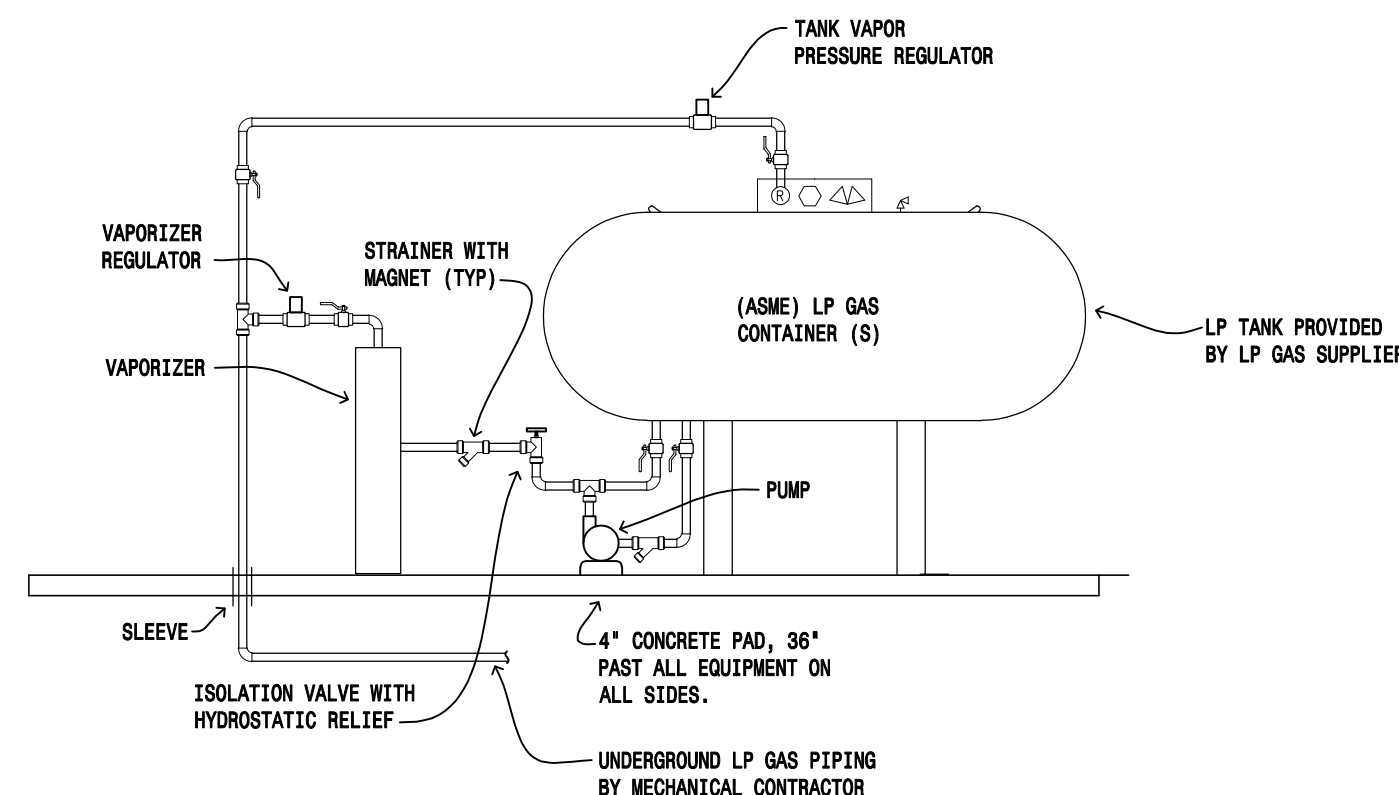
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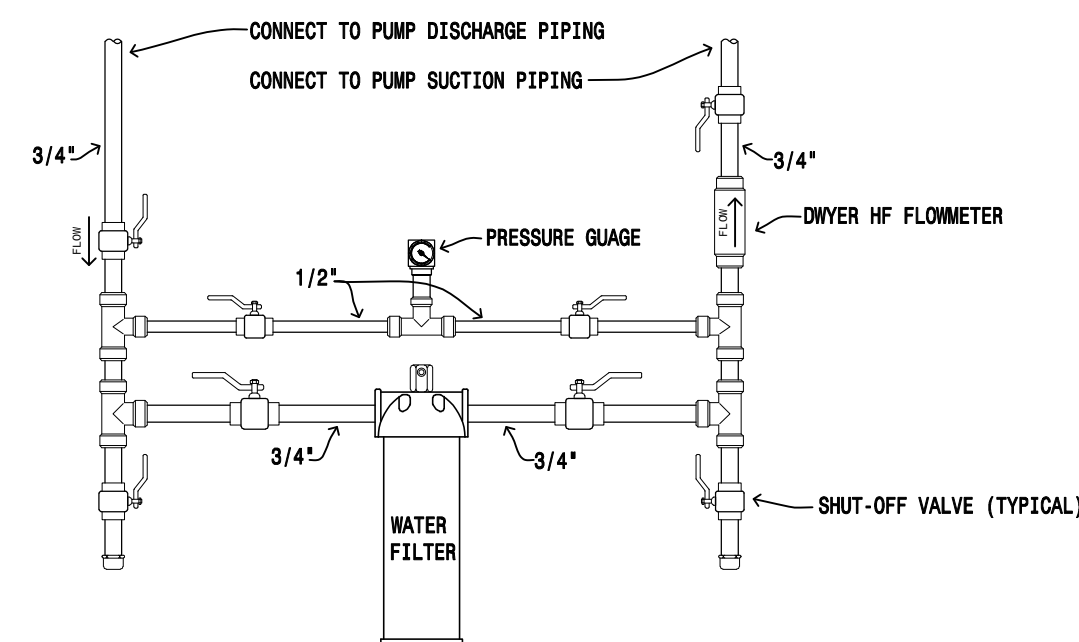
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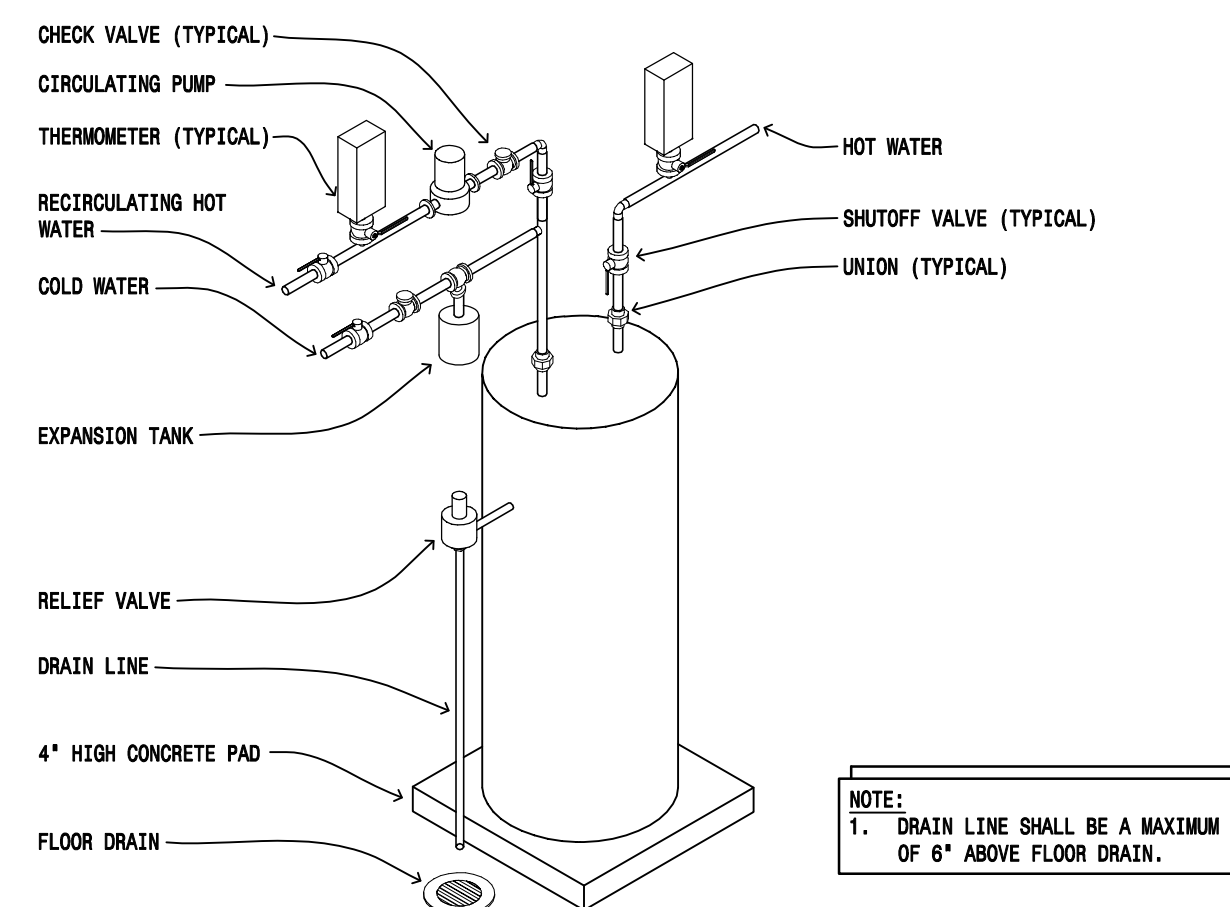
16 M400 VAPORIZER PIPING DIAGRAM

SCALE: NOT-TO-SCALE




15 M400 SIDESTREAM FILTER DETAIL

SCALE: NOT-TO-SCALE




14 M400 ELECTRIC WATER HEATER DETAIL

SCALE: NOT-TO-SCALE

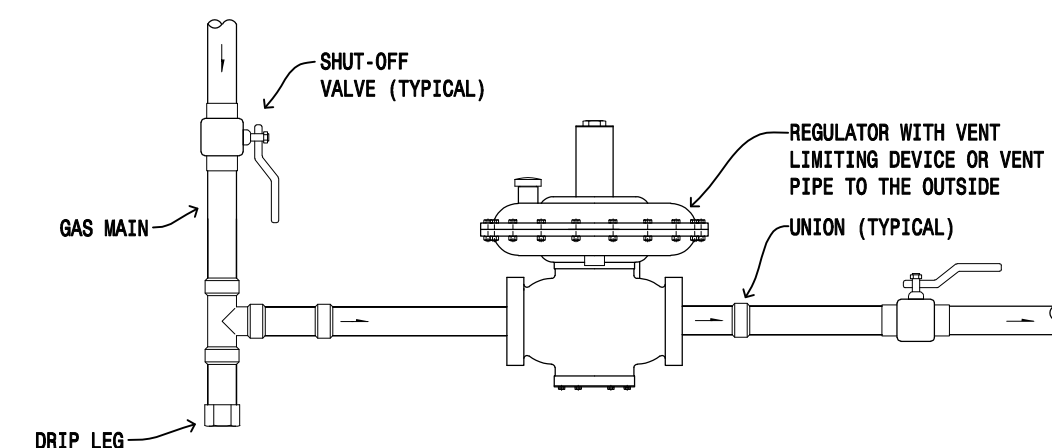


13 M400 GAS REGULATOR DETAIL

SCALE: NOT-TO-SCALE

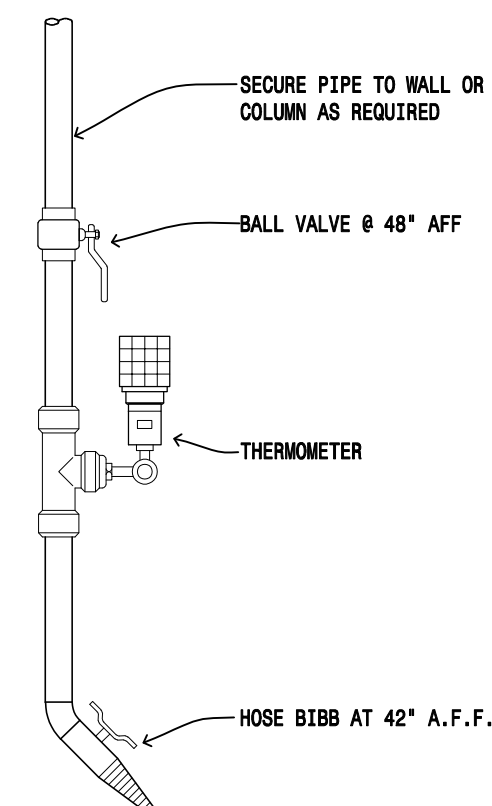


12 M400 HOSE BIBB DETAIL

SCALE: NOT-TO-SCALE

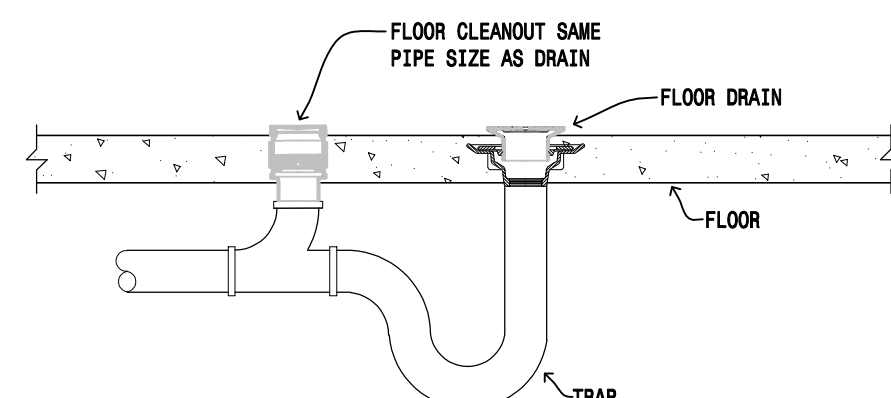

11 M400 FLOOR DRAIN DETAIL


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10 M400 SAND/OIL INTERCEPTOR DETAIL

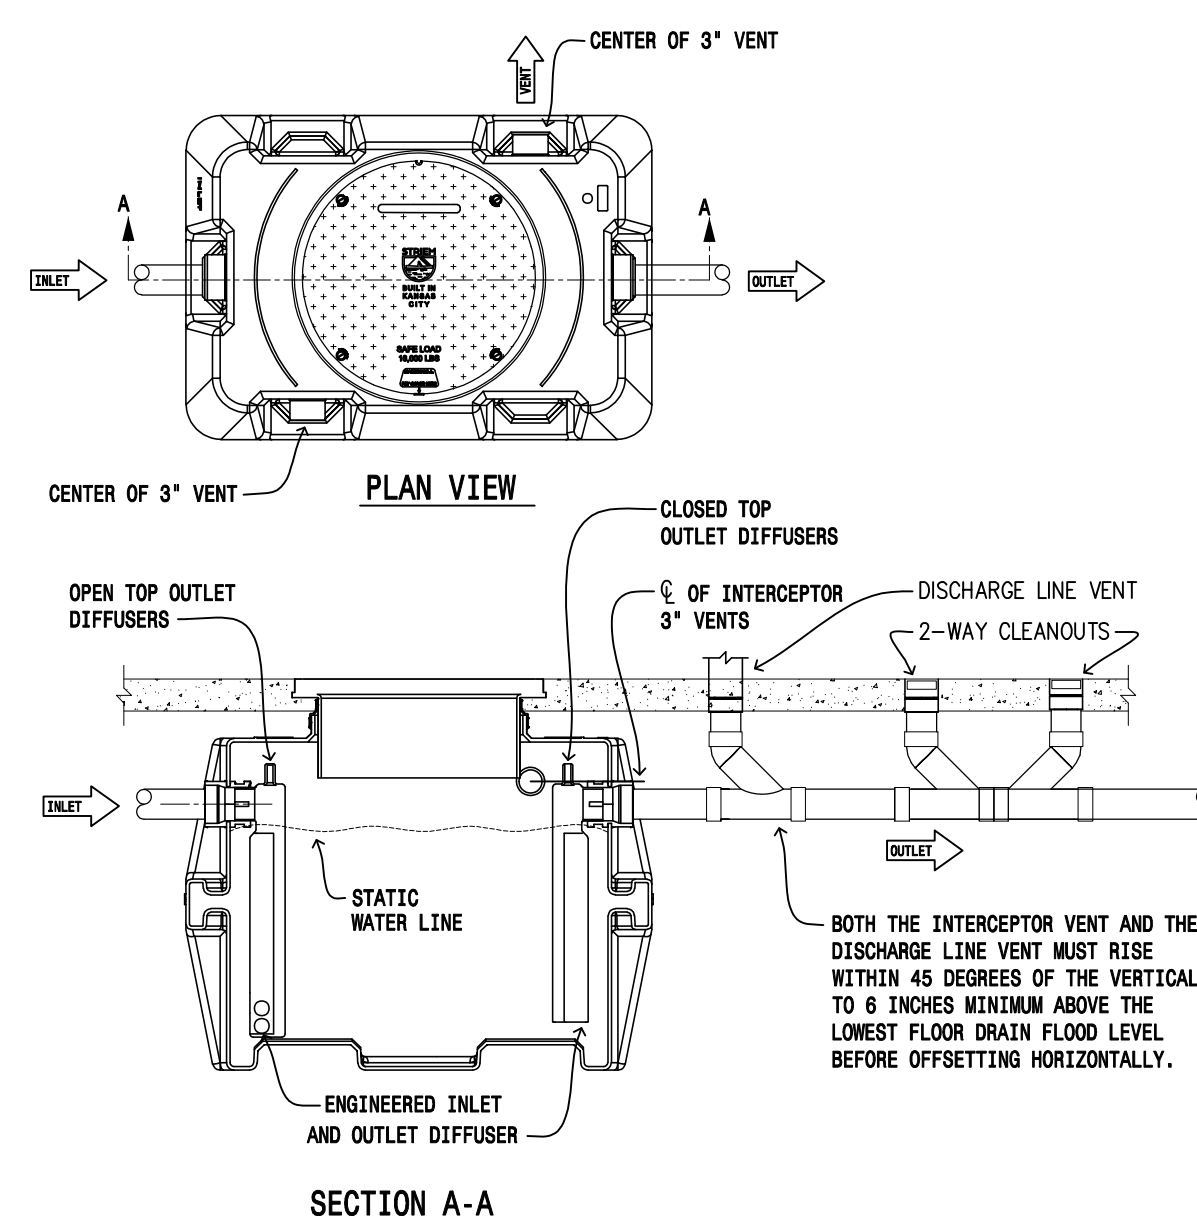
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- NOTES:
- CAREFULLY BORE CLEAN NEAT HOLE APPROXIMATELY 24" ABOVE GRADE. FILL VOID WITH GROUT. SEE MECHANICAL DRAWINGS FOR APPROPRIATE LEADER SIZE.
 - SECURE NEW LEADER TO WALL AS NECESSARY (SEE MECHANICAL).
 - PROVIDE FINISH TRIM AT WALL, CEILING AND FLOOR INTERSECTIONS TO MATCH EXISTING.
 - PROVIDE 2"x4" CONCRETE SPLASH BLOCK AT DISCHARGE LOCATION.
 - NEW FINISHED CHASE APPROXIMATELY 12" x 16".
 - EXISTING WALL CONDITIONS VARY. (FIELD VERIFY).




9 M400 DOWNSPOUT NOZZLE DETAIL

SCALE: NOT-TO-SCALE

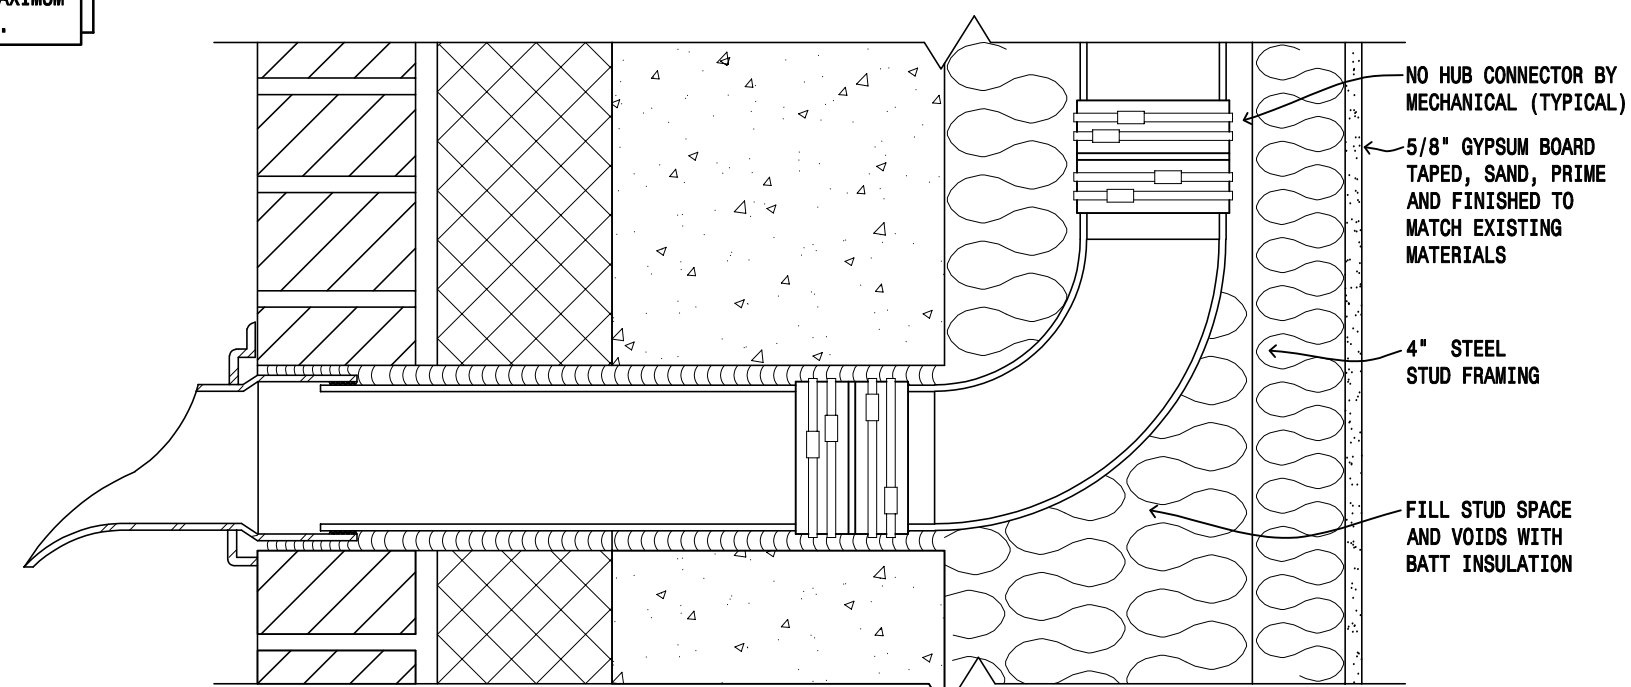

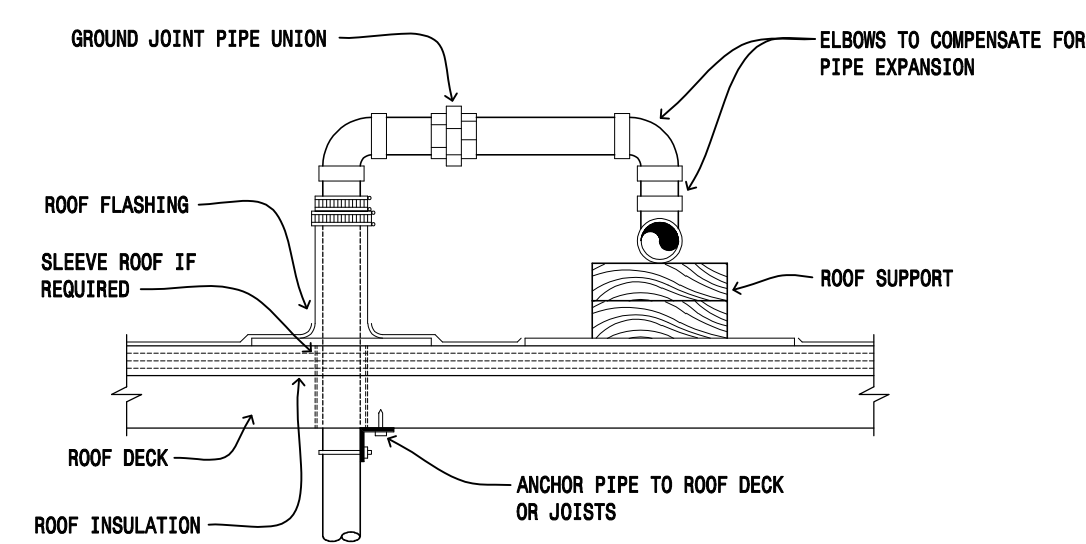
8 M400 GAS PIPING THROUGH ROOF DETAIL

SCALE: NOT-TO-SCALE

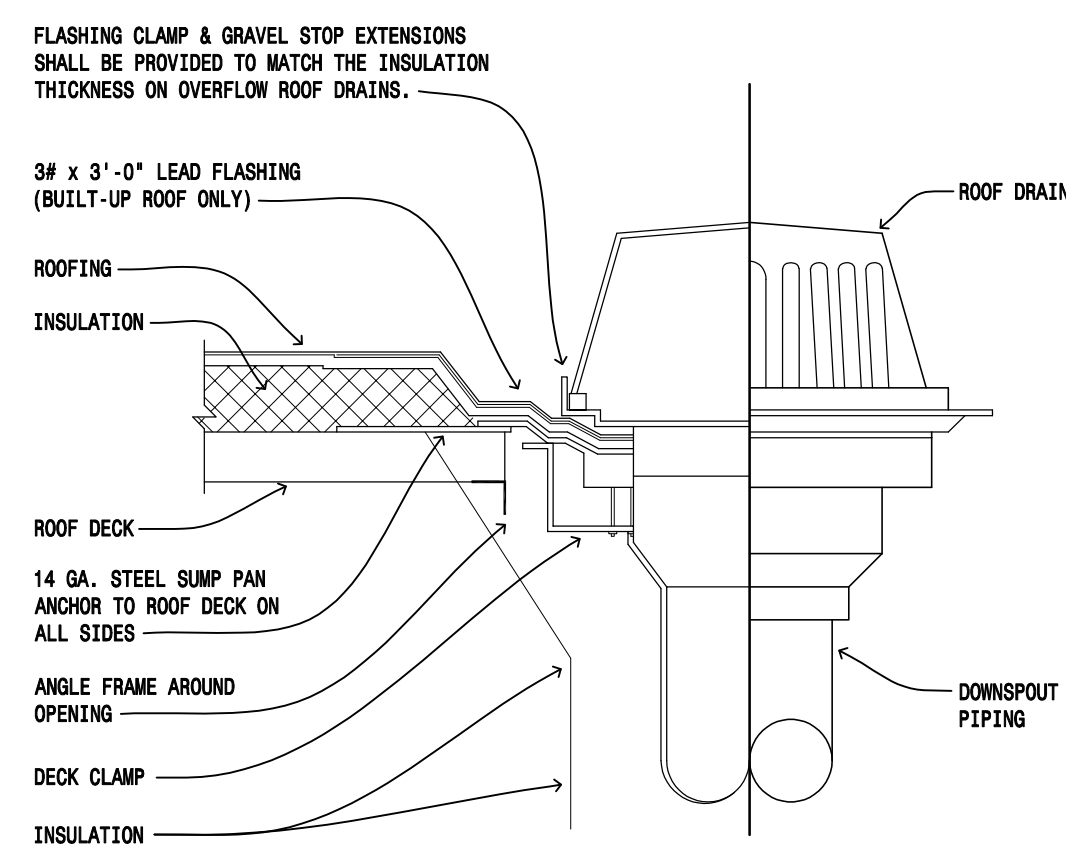


7 M400 ROOF DRAIN DETAIL

SCALE: NOT-TO-SCALE

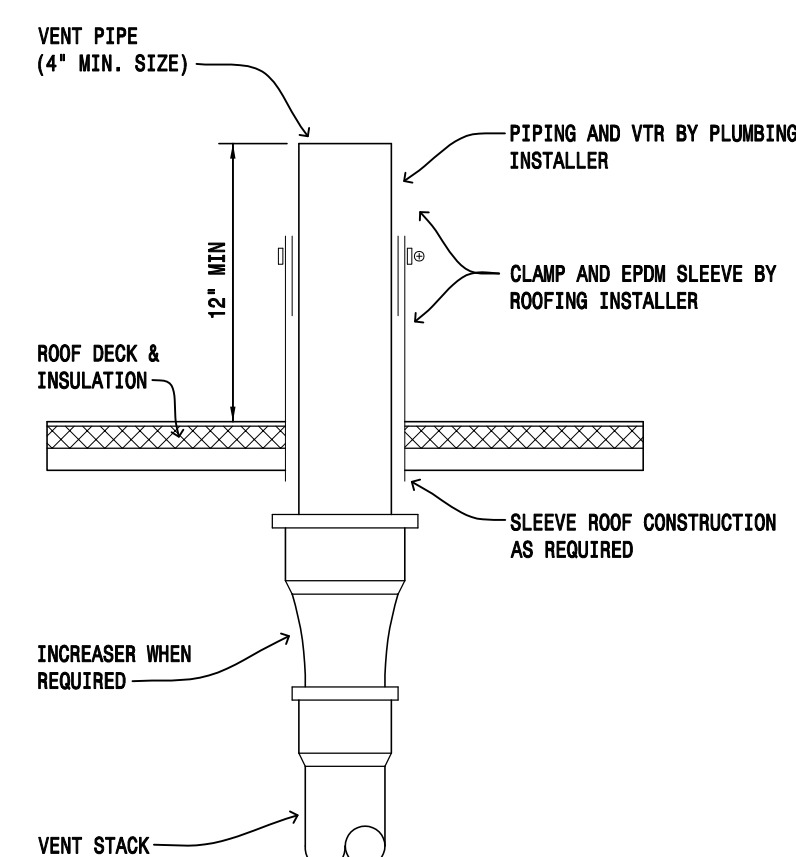


6 M400 PLUMBING VENT DETAIL

SCALE: NOT-TO-SCALE

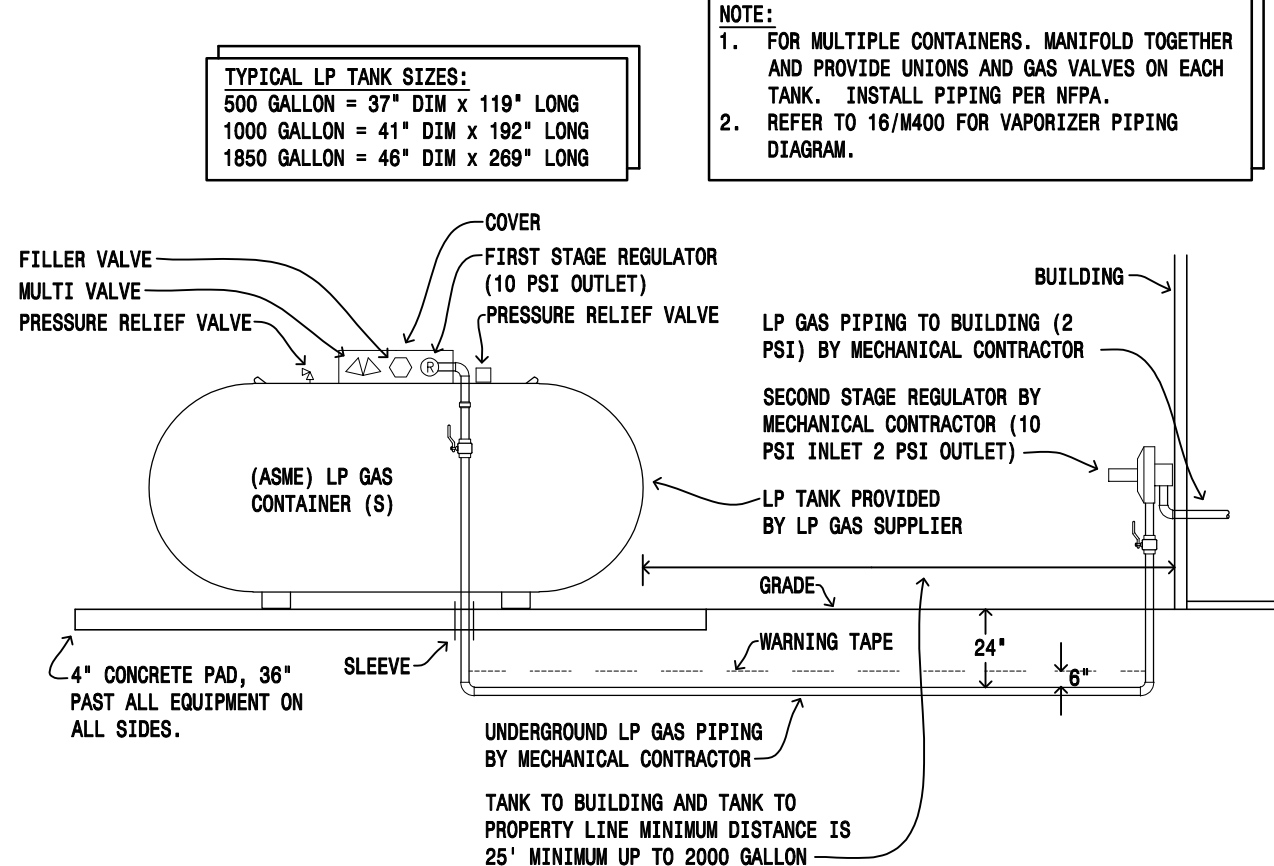


5 M400 LP TANK DETAIL

SCALE: NOT-TO-SCALE

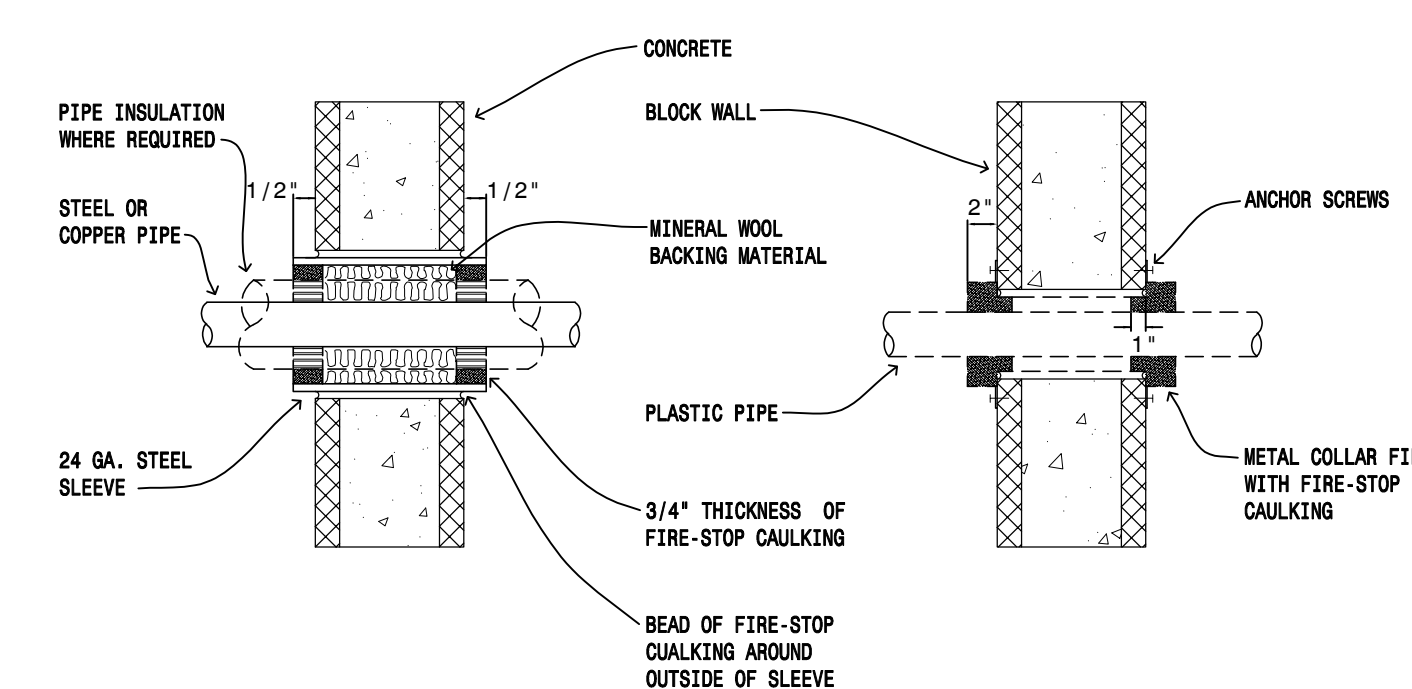


4 M400 FIRE WALL PIPE PENETRATION DETAIL

SCALE: NOT-TO-SCALE

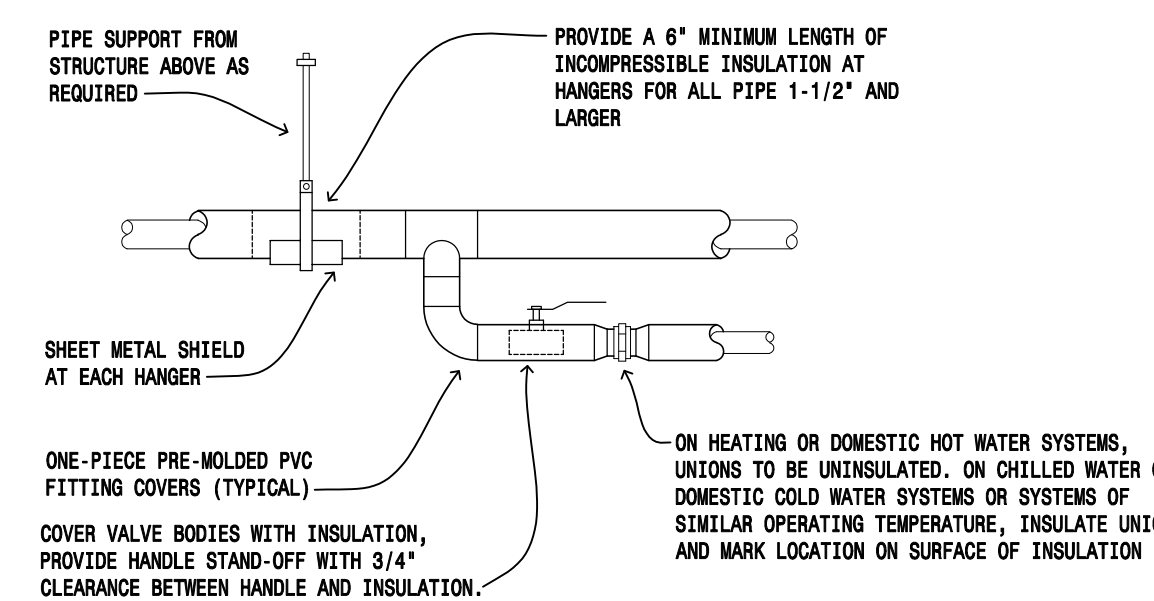


3 M400 PIPING INSULATION DETAIL

SCALE: NOT-TO-SCALE

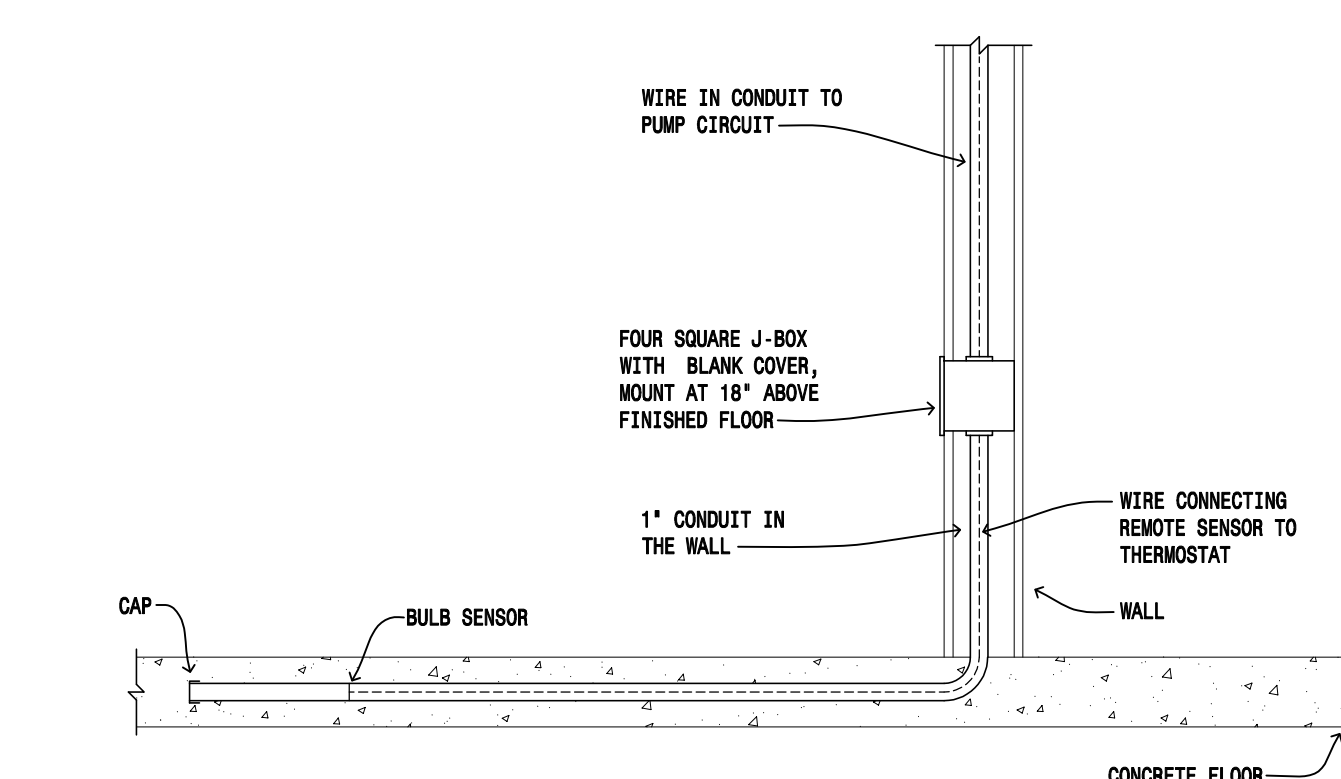


2 M400 FLOOR TEMPERATURE SENSOR

SCALE: NOT-TO-SCALE

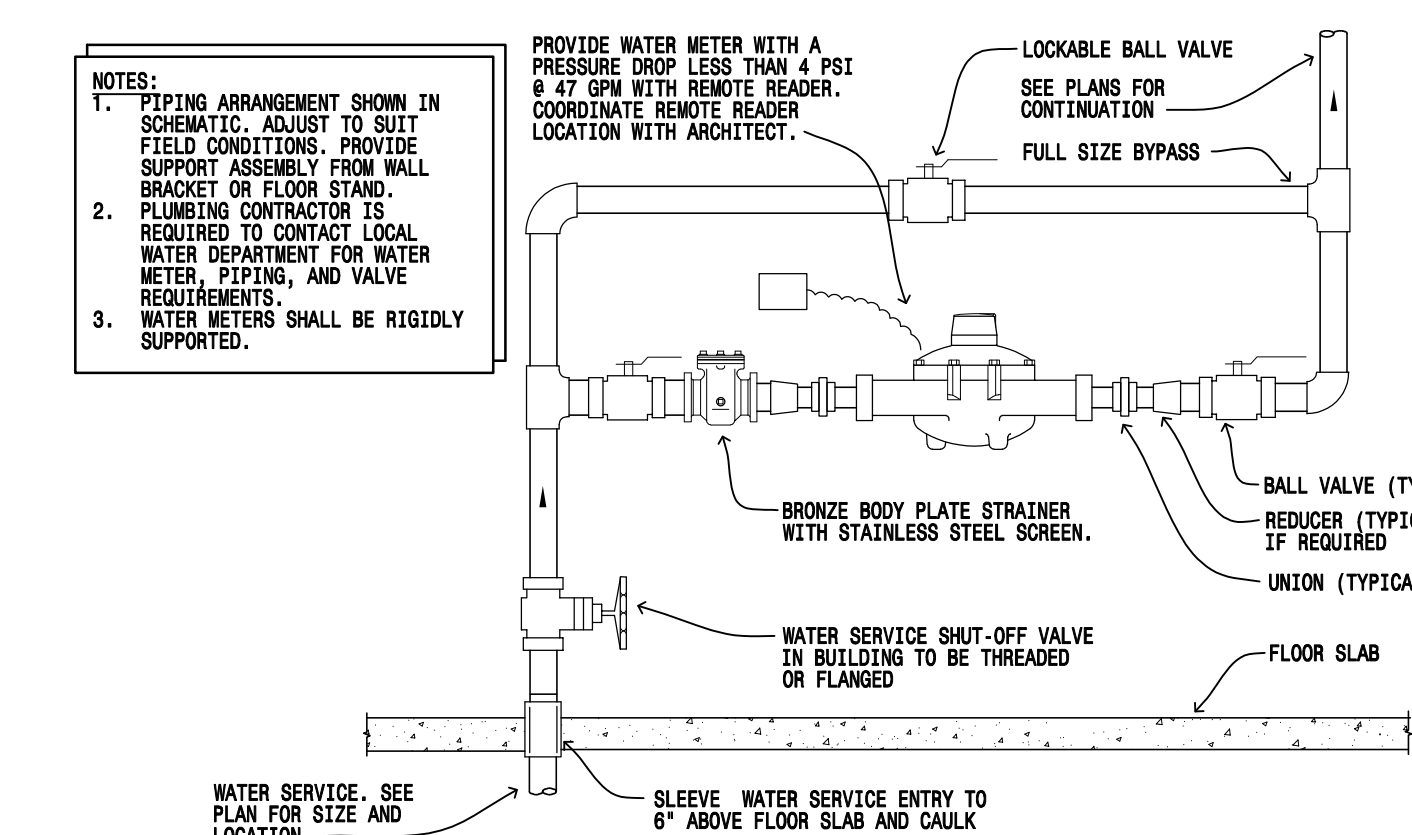

1 M400 WATER METER DETAIL

SCALE: NOT-TO-SCALE

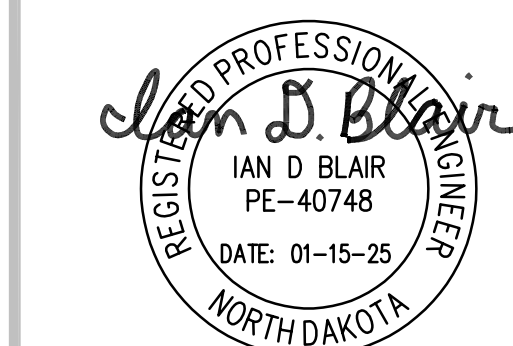

DRAWING HISTORY

NO.	DESCRIPTION	DATE
1	DESIGN DOCUMENTS	01/15/25

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MECHANICAL DETAILS

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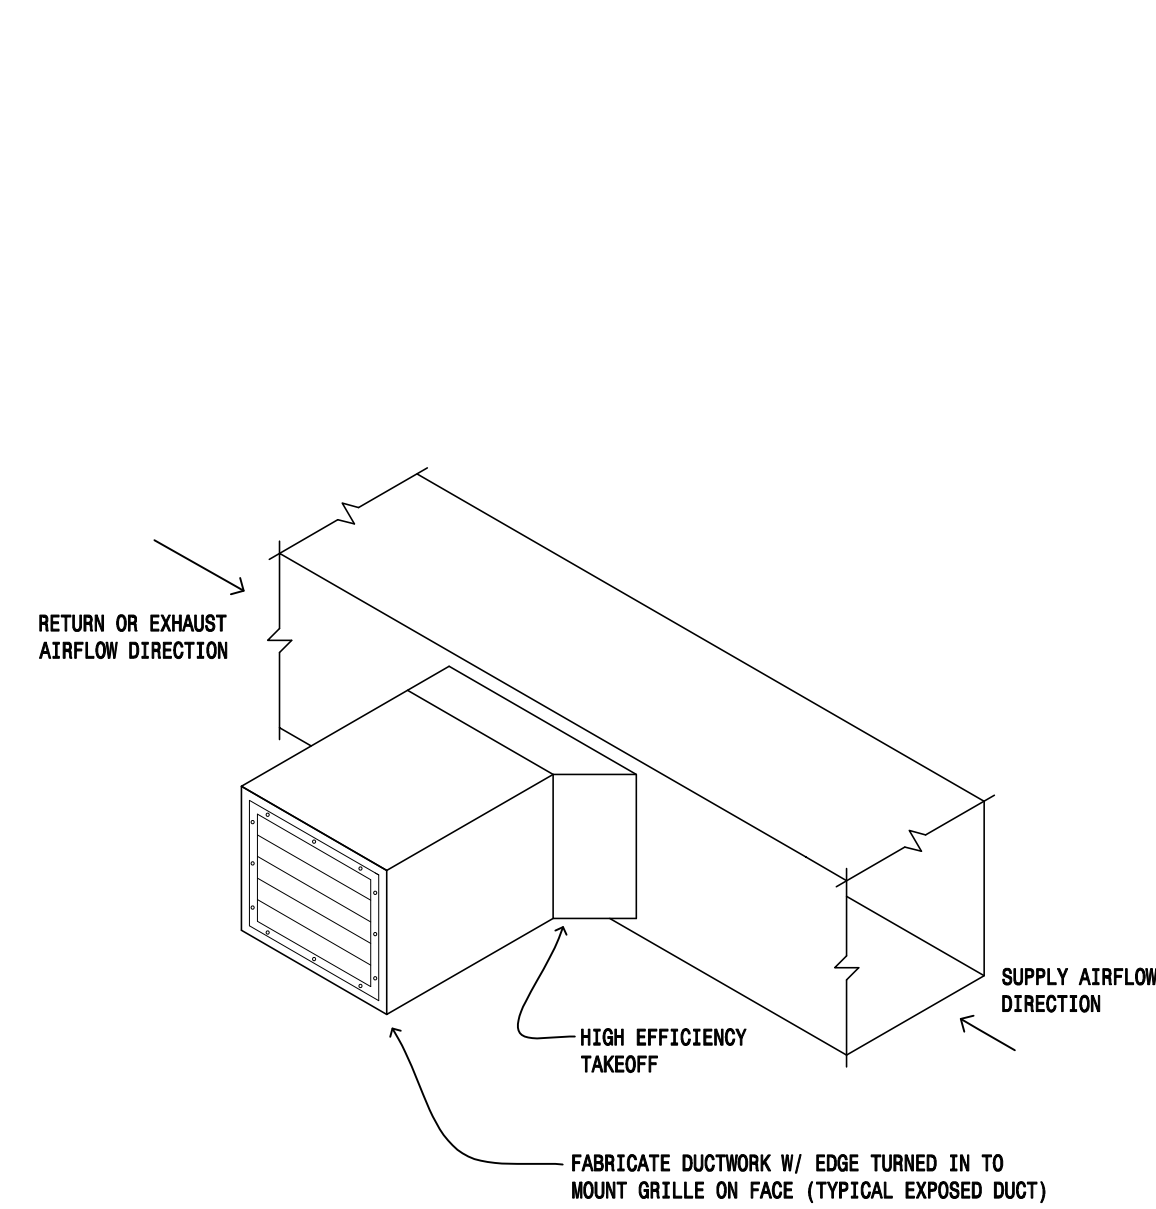
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ELECTRICAL


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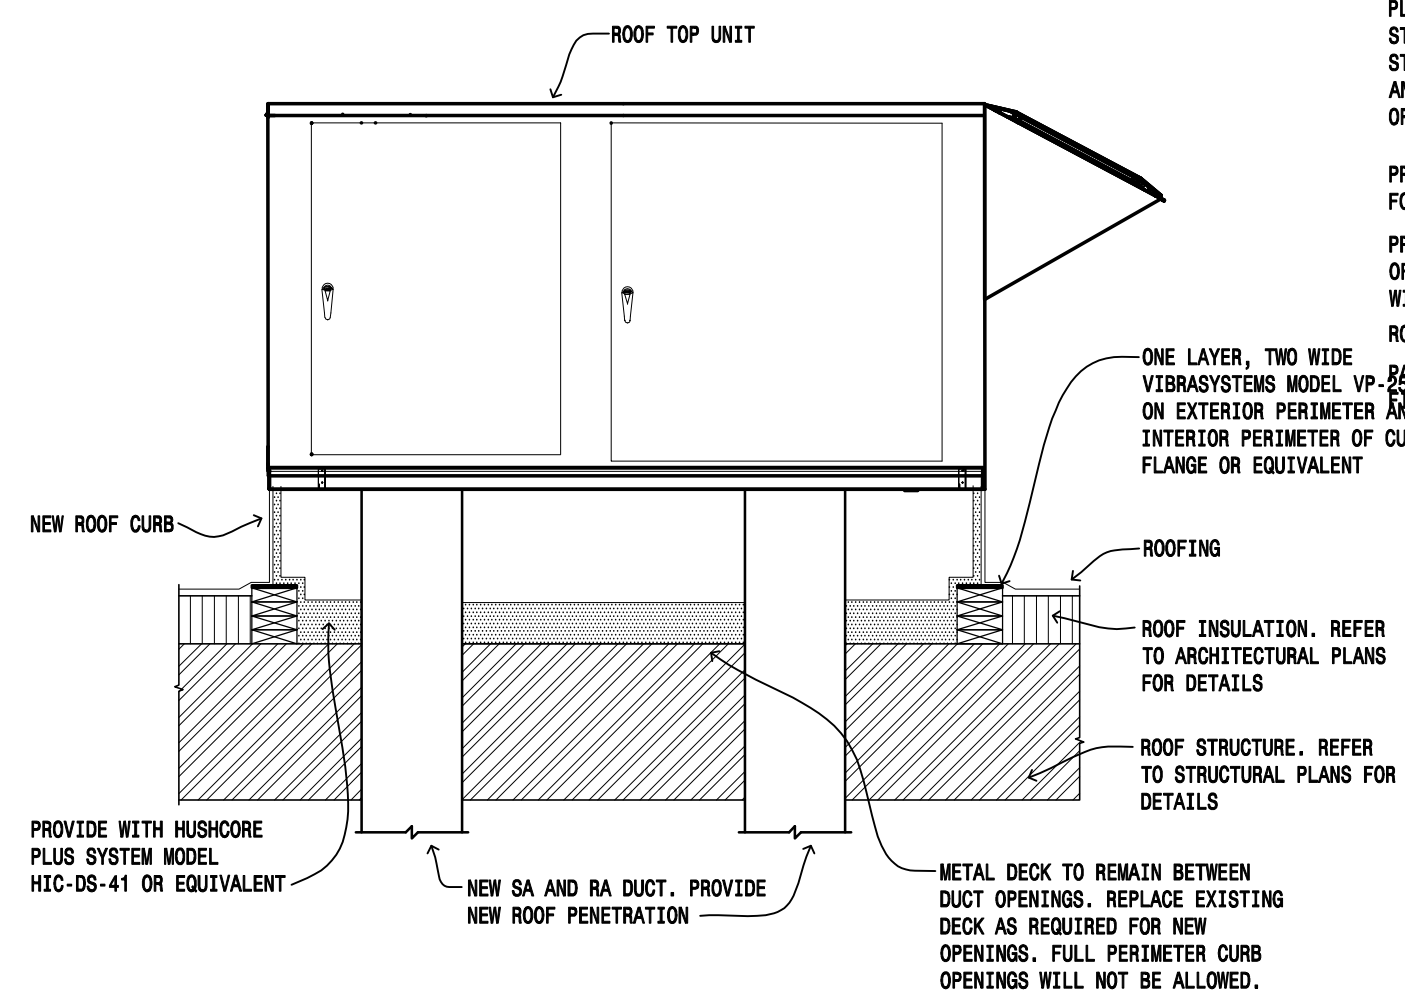
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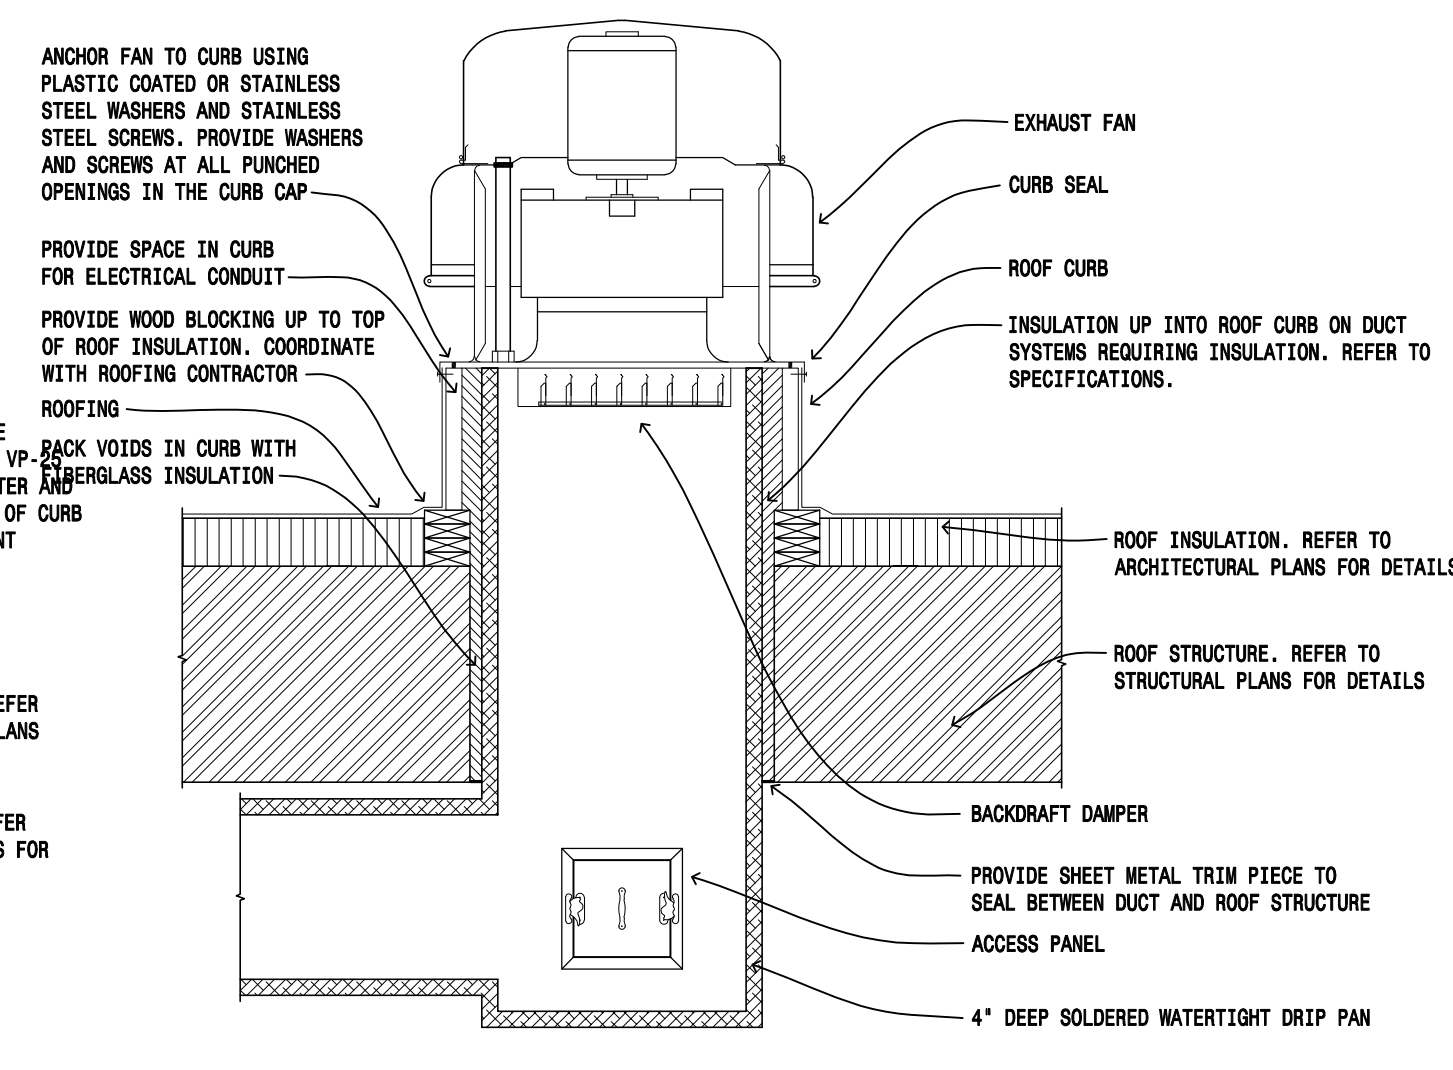
10 M401 EXPOSED GRILLE MOUNTING DETAIL
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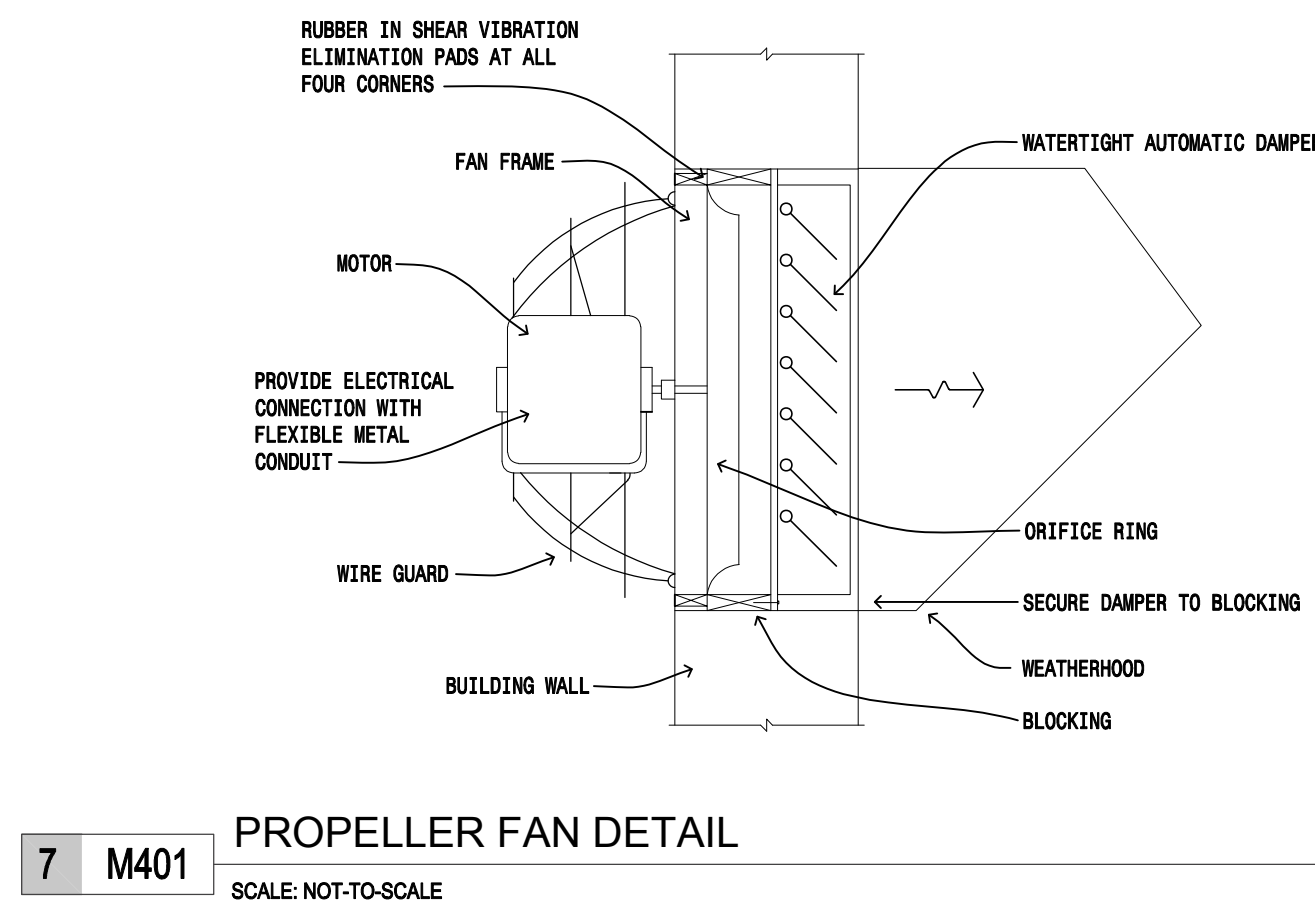
9 M401 LOUVER DETAIL
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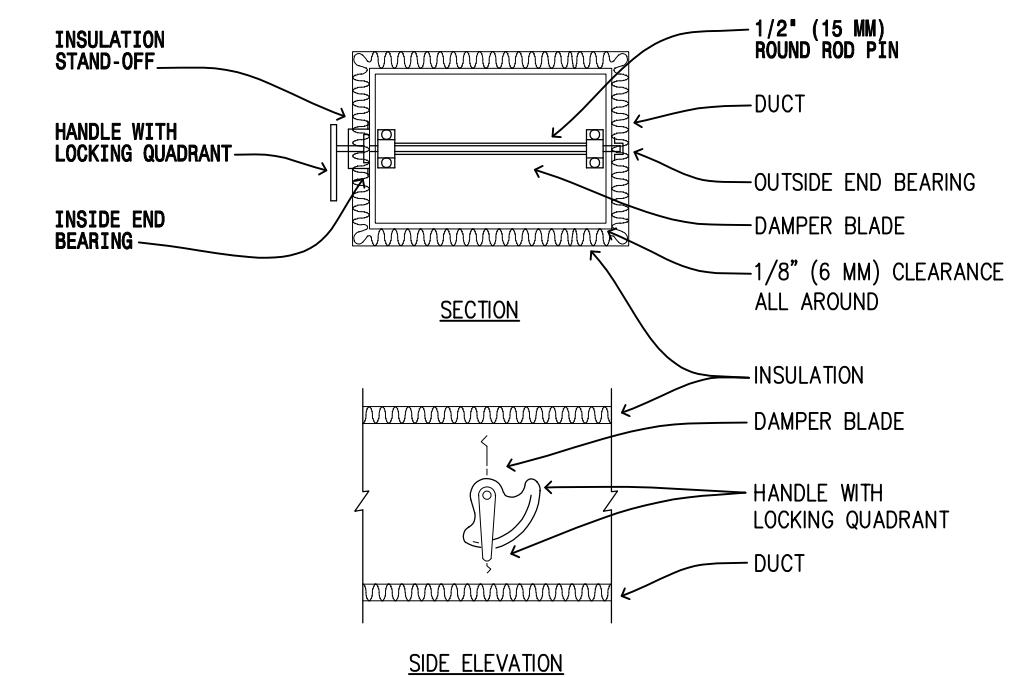
11 M401 ROOF CURB INSTALLATION DETAIL
SCALE: NOT-TO-SCALE



8 M401 POWER ROOF VENTILATOR INSTALLATION DETAIL
SCALE: NOT-TO-SCALE




7 M401 PROPELLER FAN DETAIL
SCALE: NOT-TO-SCALE

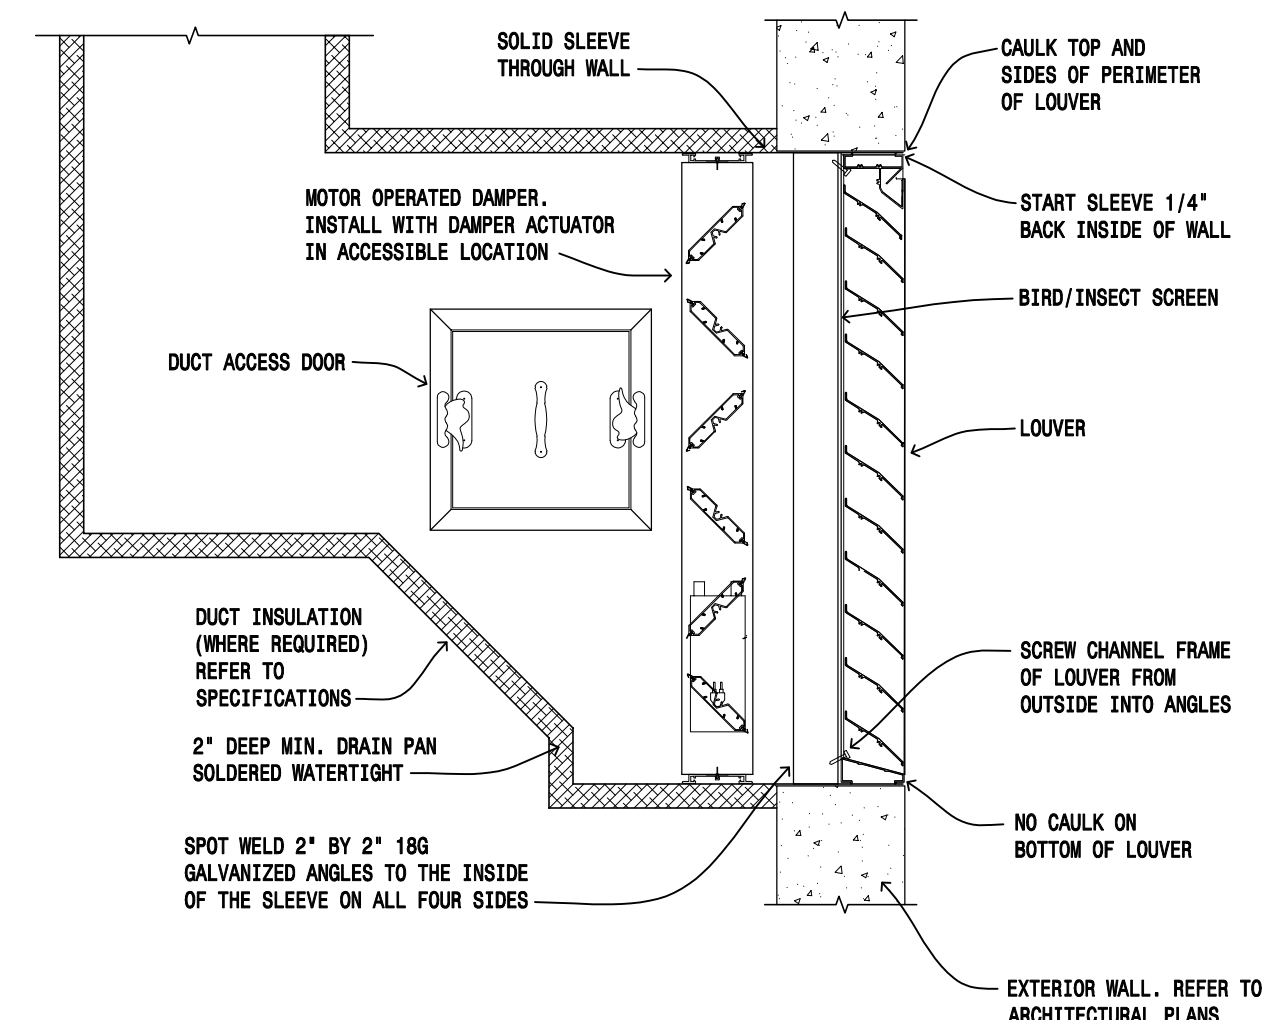


NOTES:
1. DELETE INSULATION STAND-OFF ON DUCTWORK WITHOUT EXTERIOR INSULATION.
2. DETAIL SHOWS SINGLE BLADE DAMPER. DAMPER INSTALLATION SHALL BE SIMILAR FOR MULTI-BLADE DAMPERS & ROUND DAMPERS.
3. DAMPER ARM SHALL BE LONG ENOUGH TO PROTRUDE PAST ANY INSULATION. ANY SHORT ARM VOLUME DAMPERS THAT ARE INSTALLED WILL BE REMOVED & REPLACED WITH LONG ARM DAMPERS.

6 M401 VOLUME DAMPER DETAIL
SCALE: NOT-TO-SCALE

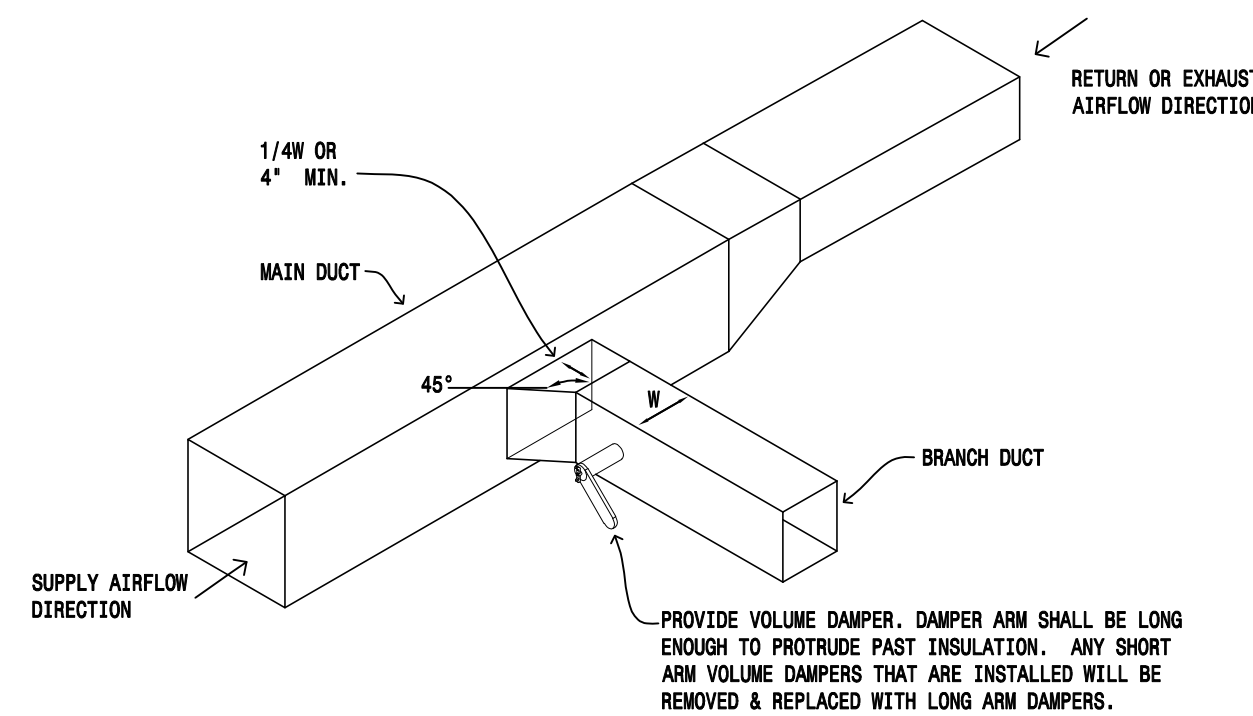


5 M401 BRANCH DUCTWORK
SCALE: NOT-TO-SCALE

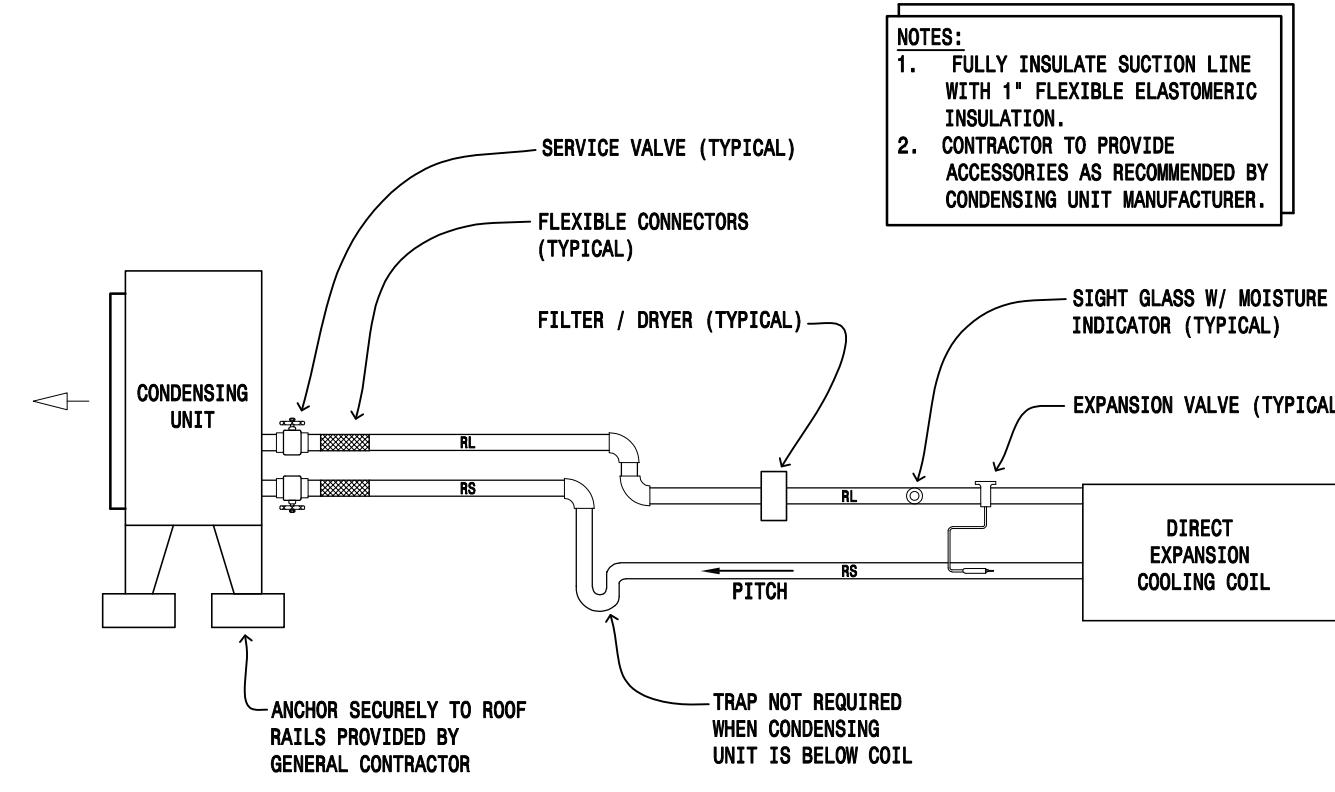


NOTES:
1. FULLY INSULATE SUCTION LINE WITH 1" FLEXIBLE ELASTOMERIC INSULATION.
2. CONTRACTOR TO PROVIDE ACCESSORIES AS RECOMMENDED BY CONDENSING UNIT MANUFACTURER.

4 M401 REFRIGERANT PIPING DETAIL
SCALE: NOT-TO-SCALE

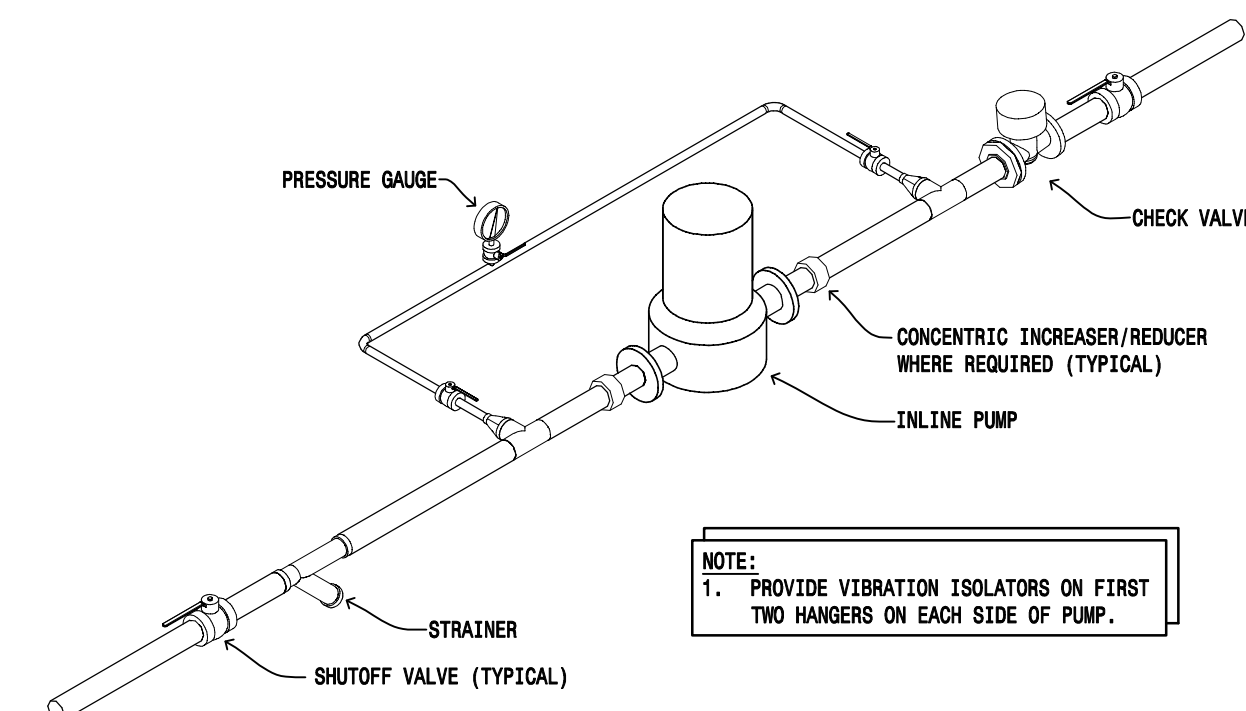


NOTE:
1. PROVIDE VIBRATION ISOLATORS ON FIRST TWO HANGERS ON EACH SIDE OF PUMP.

3 M401 INLINE PUMP DETAIL
SCALE: NOT-TO-SCALE

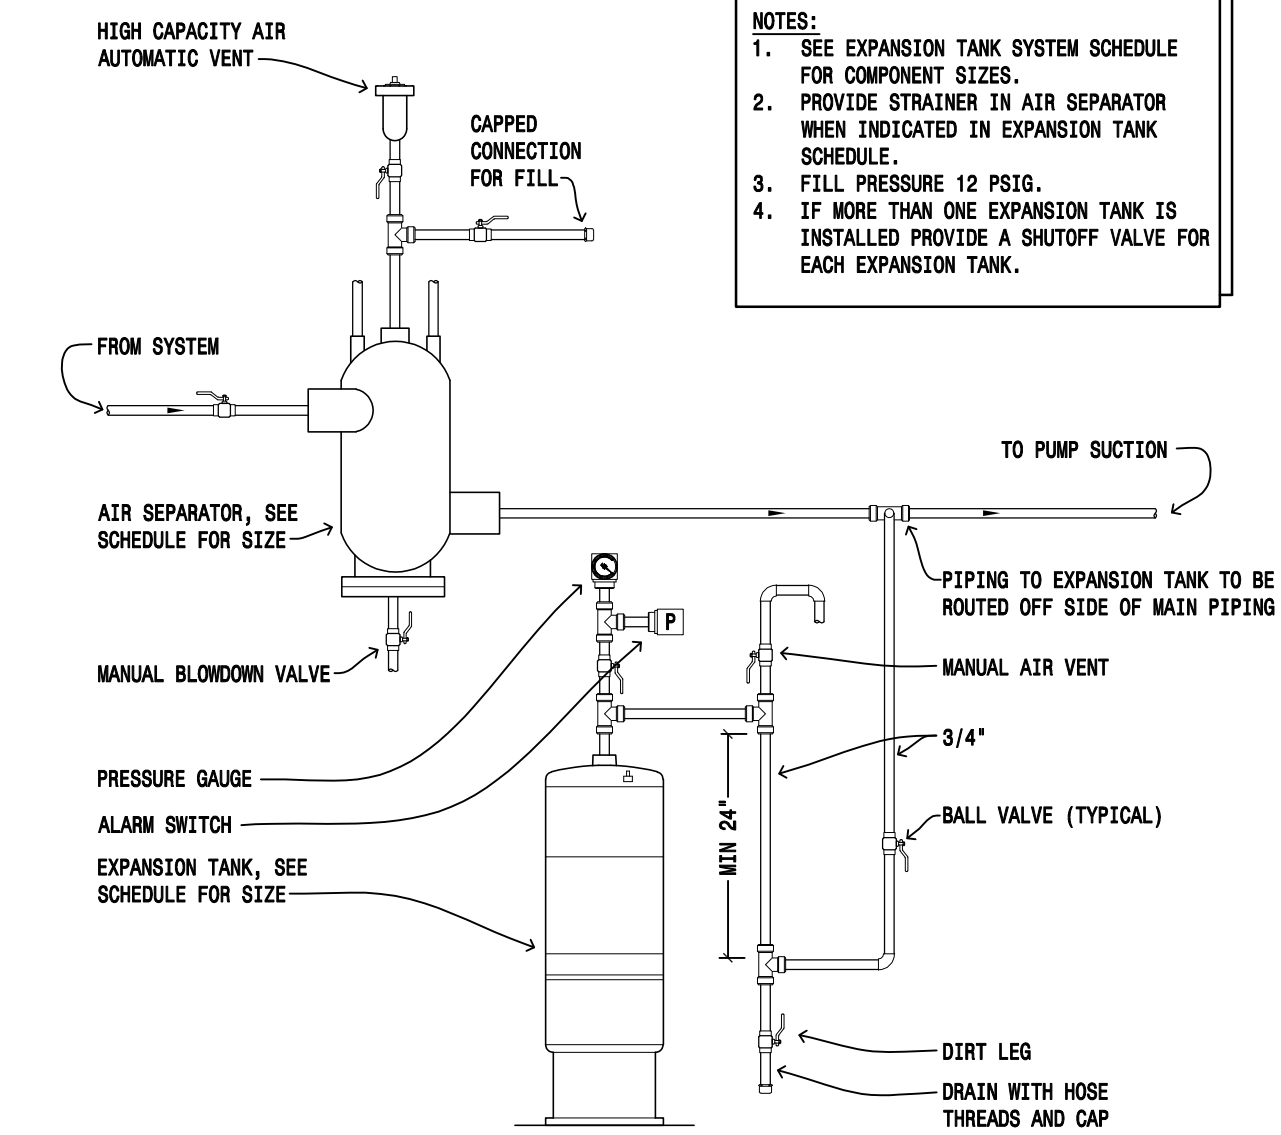


NOTES:
1. SEE EXPANSION TANK SYSTEM SCHEDULE FOR COMPONENT SIZES.
2. PROVIDE STRAINER IN AIR SEPARATOR WHEN INDICATED IN EXPANSION TANK SCHEDULE.
3. FILL PRESSURE 12 PSIG.
4. IF MORE THAN ONE EXPANSION TANK IS INSTALLED PROVIDE A SHUTOFF VALVE FOR EACH EXPANSION TANK.

2 M401 AIR CONTROL PIPING DETAIL
SCALE: NOT-TO-SCALE

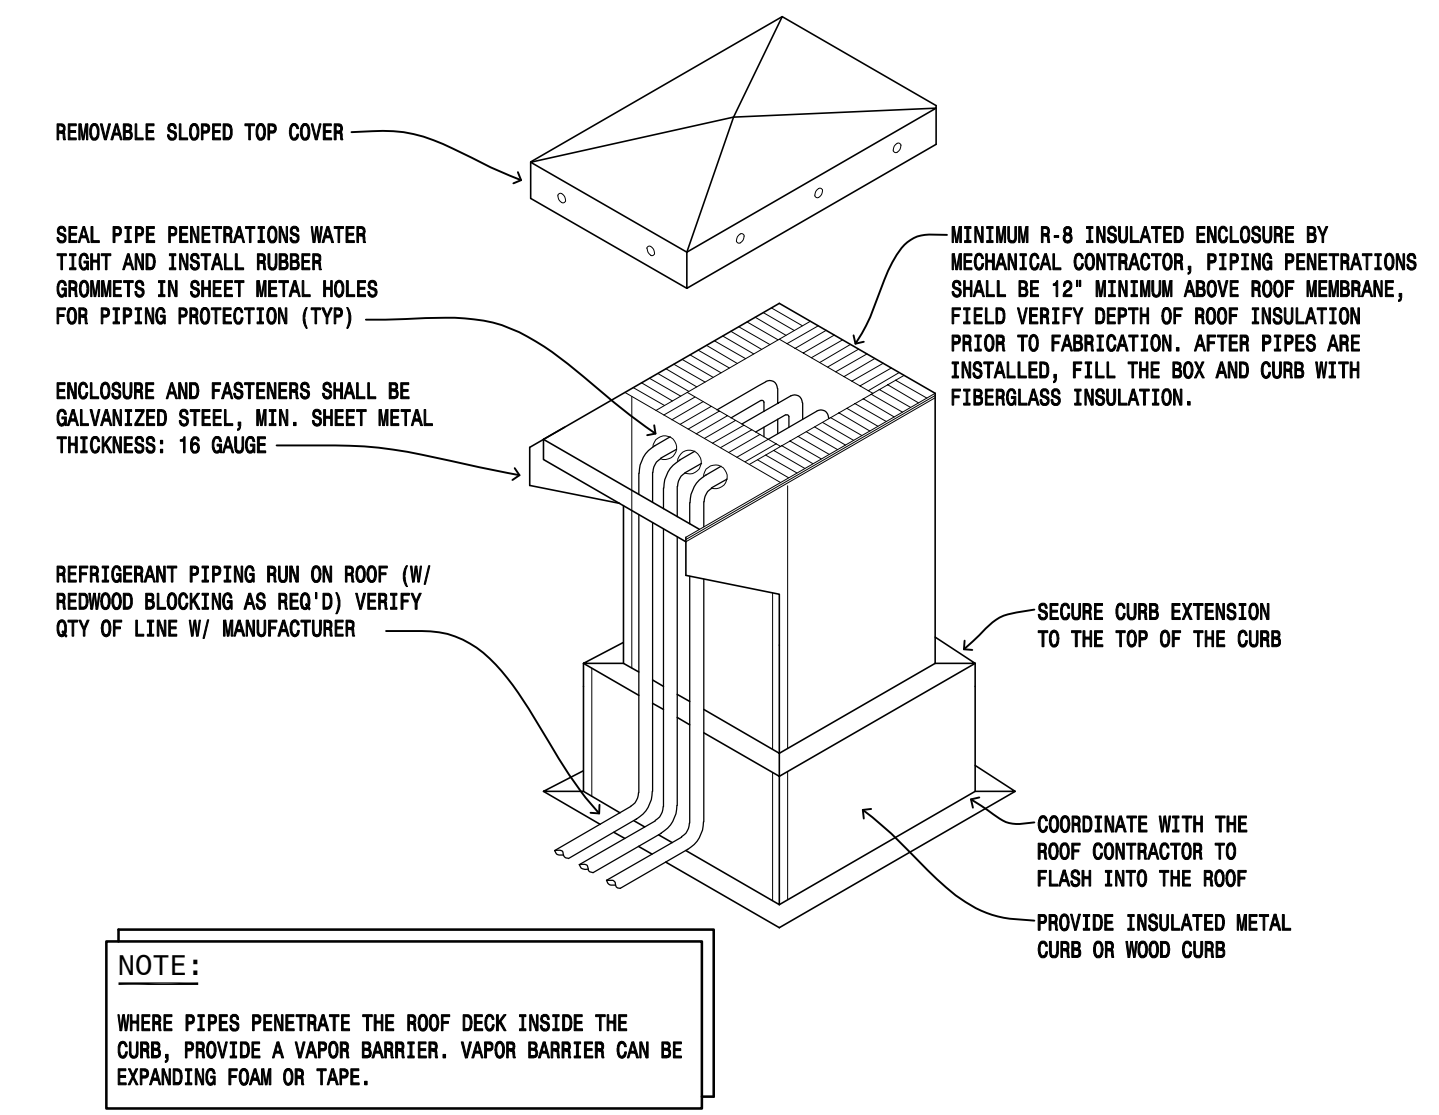

NOTE:
WHERE PIPES PENETRATE THE ROOF DECK INSIDE THE CURB, PROVIDE A VAPOR BARRIER. VAPOR BARRIER CAN BE EXPANDING FOAM OR TAPE.

1 M401 PIPING WEATHER ENCLOSURE DETAIL
SCALE: NOT-TO-SCALE

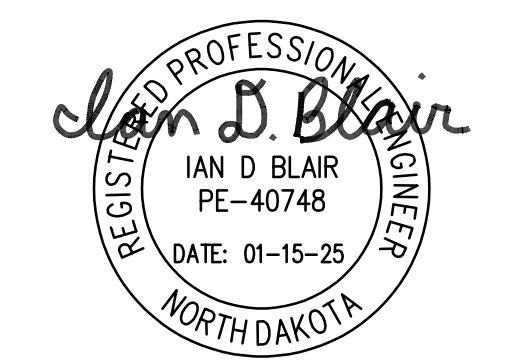

DRAWING HISTORY

NO.	DESCRIPTION	DATE
1	DESIGN DOCUMENTS	01/15/25

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JN: 24-054

MECHANICAL DETAILS

SHEET

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UNITED AND TURTLE
MOUNTAIN
COMMUNICATIONS
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MECHANICAL


MBN ENGINEERING, INC.
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ELECTRICAL

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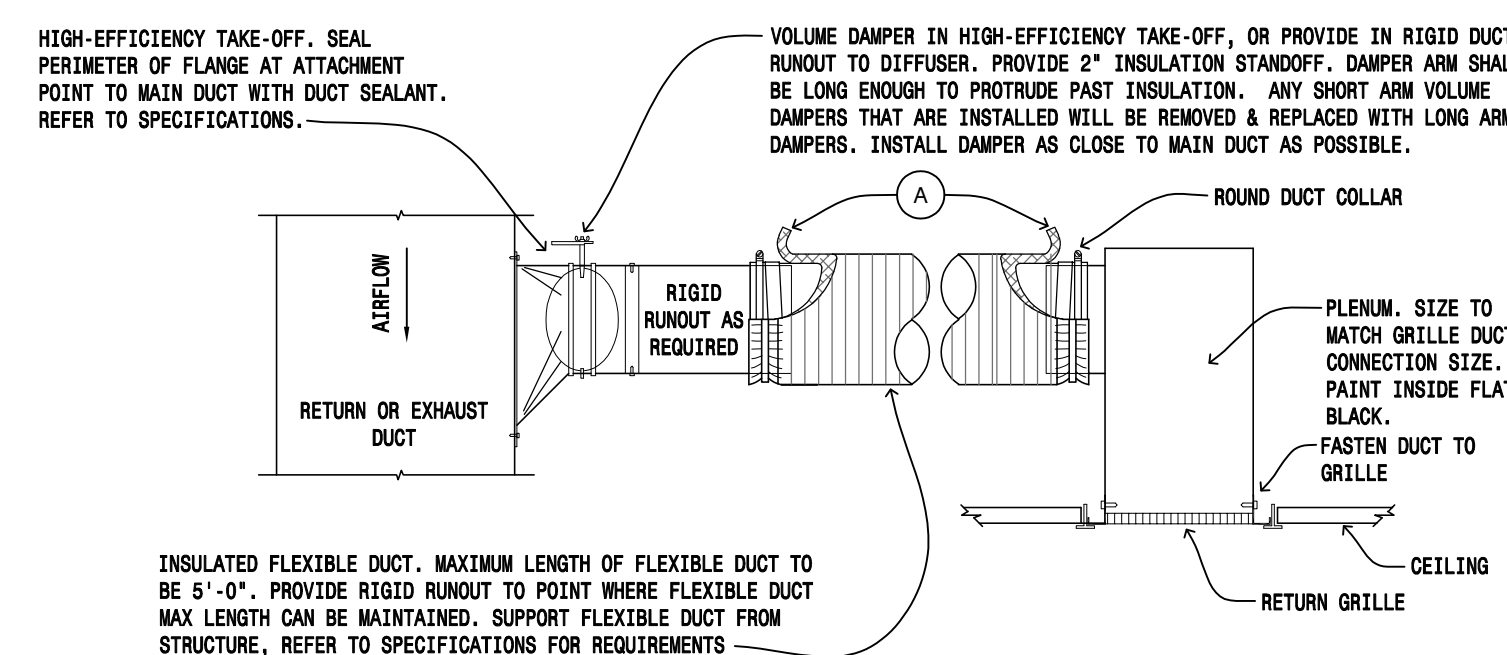
CIVIL

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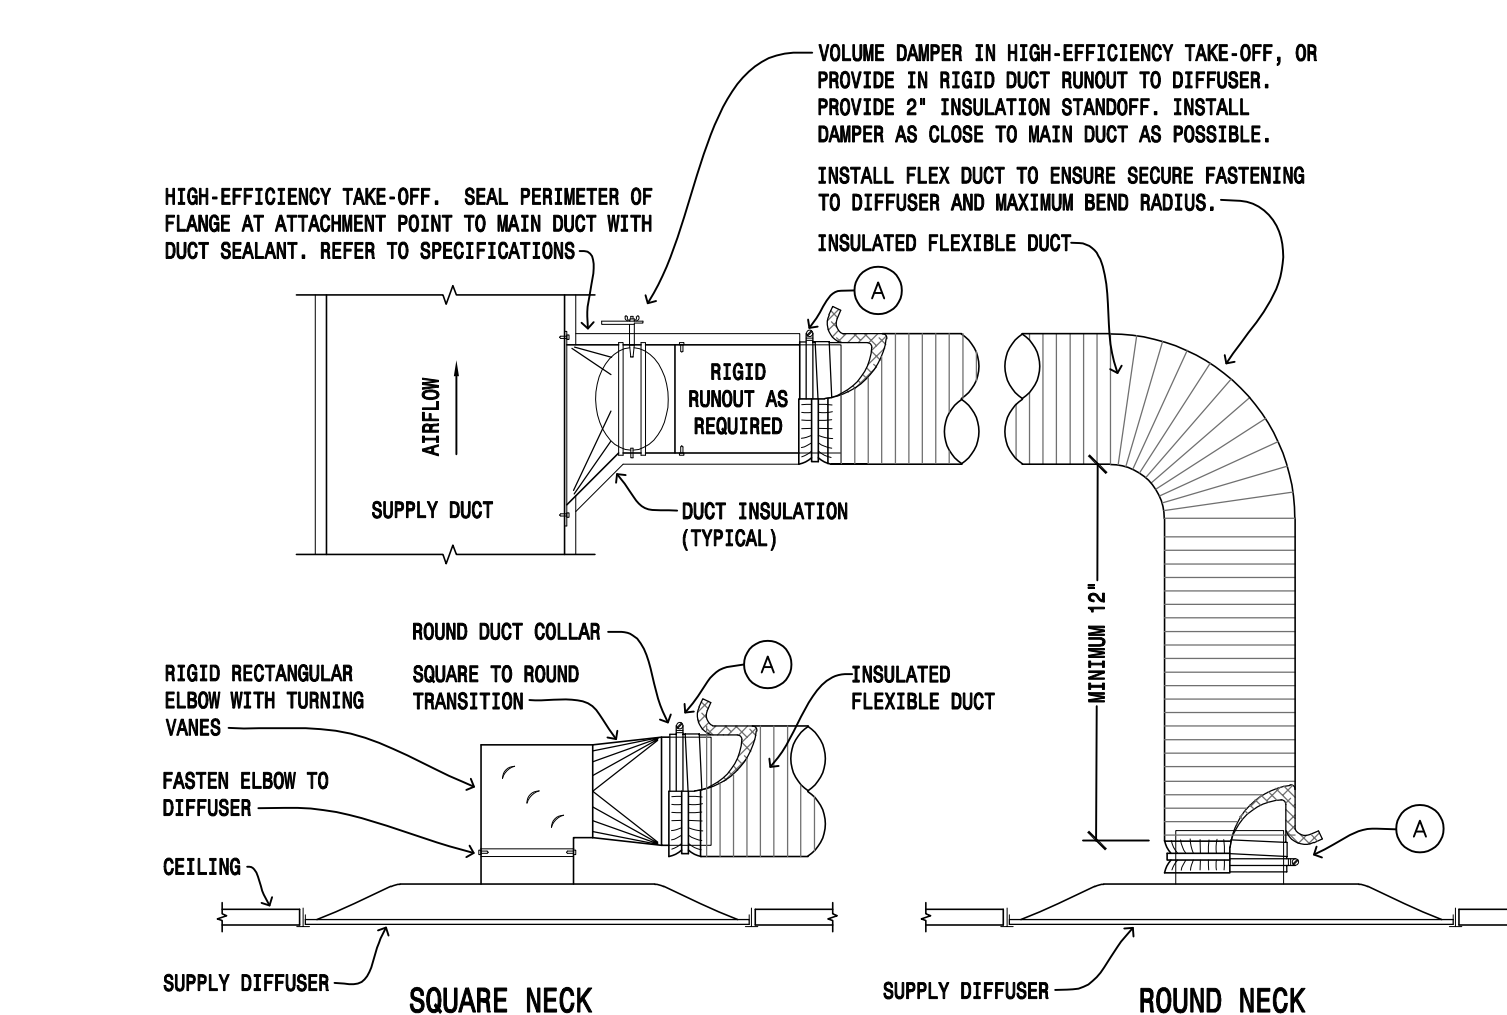
6 M402 FIRE DAMPER DETAIL

SCALE: NOT-TO-SCALE

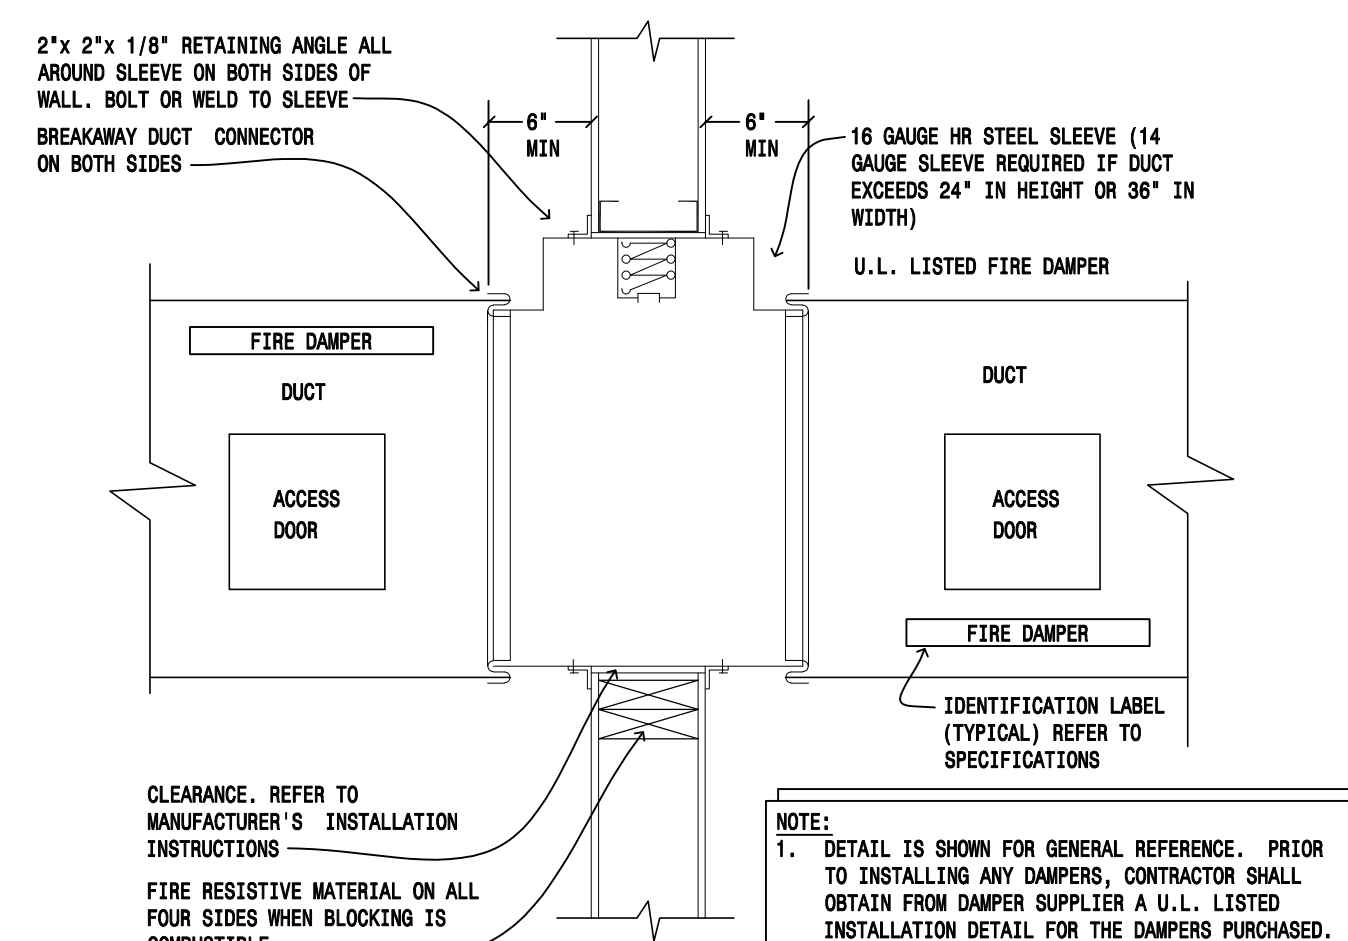


5 M402 DUCTED RETURN OR EXHAUST GRILLE DETAIL

SCALE: NOT-TO-SCALE




4 M402 DIFFUSER INSTALLATION DETAIL

SCALE: NOT-TO-SCALE

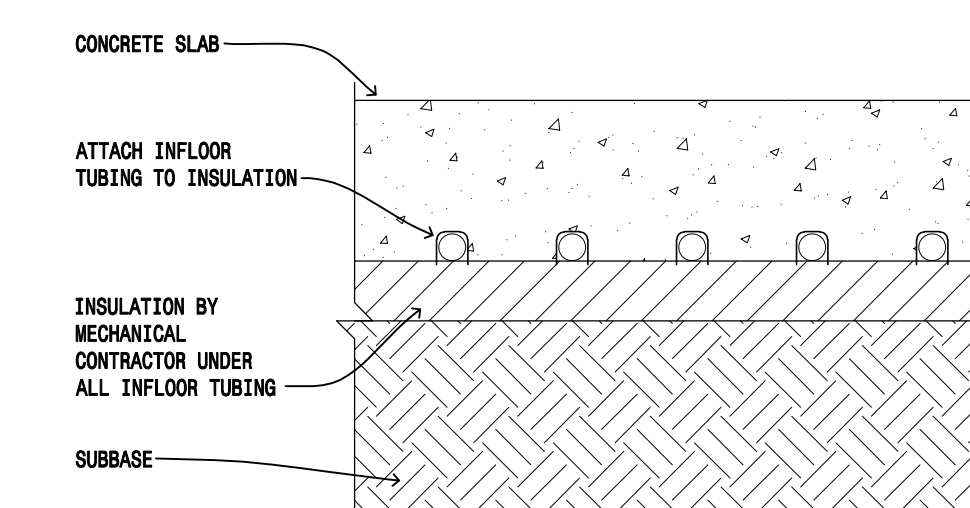


3 M402 INFLOOR TUBING INSTALLATION DETAIL

SCALE: NOT-TO-SCALE

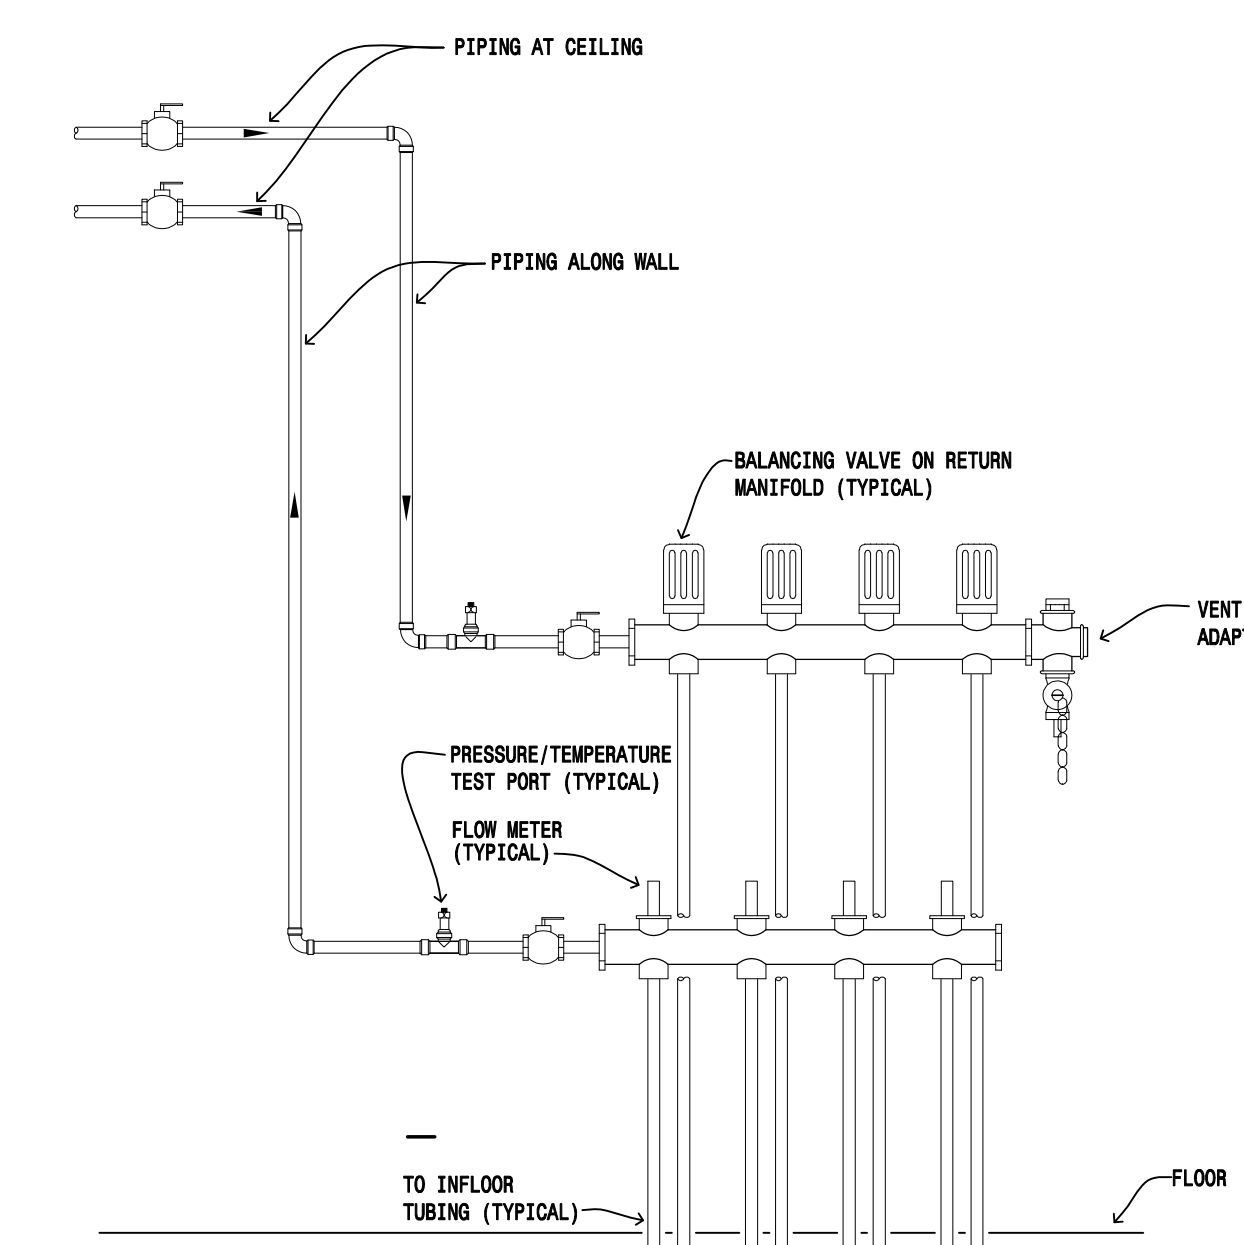

2 M402 INFLOOR HEAT MANIFOLD DETAIL

SCALE: NOT-TO-SCALE

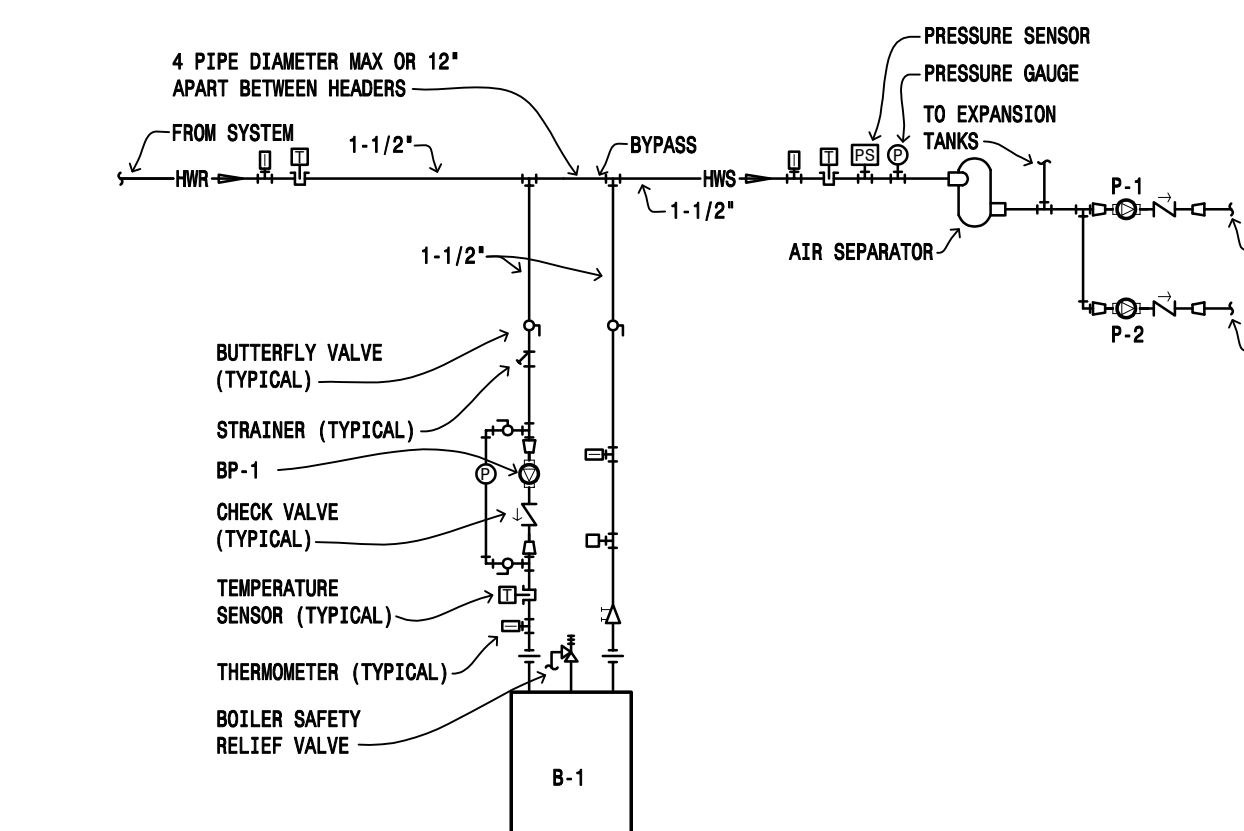

1 M402 MODULAR BOILER FLOW DIAGRAM


SCALE: NOT-TO-SCALE

- GENERAL NOTES:
1. DUCT TAPES SHALL BE LISTED AND LABELED IN ACCORDANCE WITH STANDARD UL 181B AND MARKED "181B-FX"
 2. HIGH EFFICIENCY TAKE-OFF AND RUNOUT MAY BE ROUND OR RECTANGULAR PROFILE, SEE PLANS FOR SIZE. PROVIDE SQUARE TO ROUND TRANSITION WHERE RECTANGULAR RUNOUT DUCTS ARE INDICATED.
 3. MAXIMUM LENGTH OF FLEXIBLE DUCT TO BE 5'-0". PROVIDE RIGID RUNOUT TO POINT WHERE FLEXIBLE DUCT MAX LENGTH CAN BE MAINTAINED. SUPPORT FLEXIBLE DUCT FROM STRUCTURE, REFER TO SPECIFICATIONS FOR REQUIREMENTS.
 4. REFER TO SPECIFICATIONS FOR DUCT SYSTEMS TO BE INSULATED. OMIT INSULATION WHERE NOT REQUIRED.

- KEY NOTES:
1. PEEL BACK OUTER INSULATION OF FLEX DUCT AND SECURE INNER CORE TO RIGID DUCT OR DUCT COLLAR WITH 2 FULL WRAPS OF TAPE AND METAL SCREW BAND CLAMP OVER TAPE. PULL INSULATION AND JACKET BACK INTO POSITION AND SEAL ENDS WITH 2 FULL WRAPS OF TAPE AND METAL OR NONMETALLIC BAND CLAMP.

- GENERAL NOTES:
1. DUCT TAPES SHALL BE LISTED AND LABELED IN ACCORDANCE WITH STANDARD UL 181B AND MARKED "181B-FX"
 2. HIGH EFFICIENCY TAKE-OFF AND RUNOUT MAY BE ROUND OR RECTANGULAR PROFILE, SEE PLANS FOR SIZE. PROVIDE SQUARE TO ROUND TRANSITION WHERE RECTANGULAR RUNOUT DUCTS ARE INDICATED.
 3. MAXIMUM LENGTH OF FLEXIBLE DUCT TO BE 5'-0". PROVIDE RIGID RUNOUT TO POINT WHERE FLEXIBLE DUCT MAX LENGTH CAN BE MAINTAINED. SUPPORT FLEXIBLE DUCT FROM STRUCTURE, REFER TO SPECIFICATIONS FOR REQUIREMENTS

- KEY NOTES:
1. PEEL BACK OUTER INSULATION OF FLEX DUCT AND SECURE INNER CORE TO RIGID DUCT OR DUCT COLLAR WITH 2 FULL WRAPS OF TAPE AND METAL SCREW BAND CLAMP OVER TAPE. PULL INSULATION AND JACKET BACK INTO POSITION AND SEAL ENDS WITH 2 FULL WRAPS OF TAPE AND METAL OR NONMETALLIC BAND CLAMP.

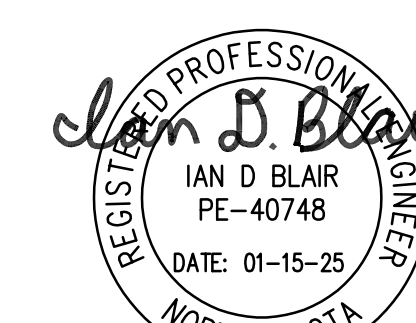

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1	DESIGN DOCUMENTS	01/15/25

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DRAWN BY: IDB JN: 24-054

MECHANICAL DETAILS

SHEET
M402

LIGHTING			POWER			SYSTEMS			MISCELLANEOUS/ABBREVIATIONS		
SYMBOLS	DESCRIPTION	MOUNTING HEIGHT	SYMBOLS	DESCRIPTION	MOUNTING HEIGHT	SYMBOLS	DESCRIPTION	MOUNTING HEIGHT	SYMBOLS	DESCRIPTION	MOUNTING HEIGHT
	CEILING SURFACE MOUNTED LIGHT FIXTURE, CAPITAL LETTER INDICATES FIXTURE TYPE, SMALL LETTER INDICATES SWITCHING.	8 INCHES ABOVE DOOR FRAME TO BOTTOM		DUPLEX RECEPTACLE (*C* INDICATES EMERGENCY CRITICAL BRANCH POWER)	18 INCHES		CEILING MOUNTED RECESSED SPEAKER			CEILING-MOUNTED JUNCTION BOX	18 INCHES
	RECESSED CEILING MOUNTED LIGHT FIXTURE			DOUBLE DUPLEX RECEPTACLE (*C* INDICATES EMERGENCY CRITICAL BRANCH POWER)	18 INCHES		CEILING SURFACE MOUNTED SPEAKER			WALL JUNCTION BOX	
	WALL MOUNTED LIGHT FIXTURE, SURFACE OR, RECESSED MOUNTED			TYPE 14-30 RECEPTACLE	18 INCHES		WALL MOUNTED SPEAKER	90 INCHES		DASHED LINES INDICATE EXISTING FIXTURES, DEVICES, OR EQUIPMENT	
	CEILING EXIT SIGN, SHADED SIDE INDICATES LIGHTED FACE, ARROWS INSTALLED AS SHOWN			TYPE 14-50 RECEPTACLE	6 INCHES		CLOCK	90 INCHES TO BOTTOM		HASH MARKS INDICATE ITEM NOTED TO BE REMOVED	
	WALL EXIT SIGN			GFCI TYPE RECEPTACLE	18 INCHES		CLOCK/SPEAKER UNIT	90 INCHES TO BOTTOM		CONDUIT CONCEALED IN WALL OR CEILING, QUANTITY OF CONDUCTORS NOT SHOWN, PROVIDE AS REQUIRED FOR DEVICE/CIRCUIT NUMBERS SHOWN.	
	SUSPENDED LIGHT FIXTURE			MULTI-OUTLET ASSEMBLY - M.O.A., PROVIDE DEVICES AS SHOWN ON PLANS	18 INCHES		MICROPHONE OUTLET	18 INCHES		CONDUIT CONCEALED IN FLOOR	
	SURFACE LIGHT FIXTURE			DUPLEX RECEPTACLE, HALF SWITCHED	18 INCHES		MICROPHONE FLOOR OUTLET			UNDERGROUND CONDUIT AT 24 INCHES MINIMUM	
	RECESSED LIGHT FIXTURE			FLOOR OUTLET, 'R' INDICATES RECESSED, 'F' INDICATES FLUSH, 'S' INDICATES SURFACE MOUNT	18 INCHES		VOLUME CONTROL	48 INCHES		HOME RUN TO PANELBOARD, QUANTITY OF CONDUCTORS REQUIRED NOT INDICATED, PROVIDE QUANTITY AS REQUIRED FOR CIRCUIT NUMBERS SHOWN, SWITCHING ARRANGEMENT, OR NUMBER OF HOME RUNS SHOWN. '#10' INDICATES WIRE SIZE, NO NUMBERS INDICATES #12, 3/4 INCH CONDUIT MINIMUM.	
	EMERGENCY BATTERY LIGHT			TIME SWITCH			AMPLIFIER CABINET	18 INCHES		NOTE IDENTIFICATION	
	EMERGENCY REMOTE LAMP			DRY TYPE TRANSFORMER			AUXILIARY INPUT OUTLET	18 INCHES		WIRE BASKET TYPE CABLE TRAY	
	PHOTO CELL		PUSH BUTTON			DATA OUTLET ROUGH-IN (NUMBER INDICATES QUANTITY OF CABLES, NO NUMBER INDICATES ONE) ROUGH IN OF CONDUIT AND BOX WITH CAT 6 CABLES. CAT 6 CABLES BY OWNER, INSTALLATION BY EC. DATA OUTLET BY OWNER.	18 INCHES		COMMUNICATIONS CABLE SUPPORT HANGER		
	CEILING MOUNTED MOTION SENSOR SWITCH		POWER DOOR HANDICAP PUSH PAD	42 INCHES		COMBINATION COMPUTER/TELEPHONE OUTLET IN SINGLE GANG OPENING (NUMBER INDICATES QUANTITY OF CABLES AND JACKS, NO NUMBER INDICATES ONE)	18 INCHES	A	AMPERE		
	WALL MOUNTED MOTION SENSOR SWITCH		EMERGENCY BOILER SHUTDOWN PUSH BUTTON	48 INCHES		THERMOSTAT - PROVIDE BY DIVISION 16	48 INCHES	AC	ABOVE COUNTER		
	MOTION SENSOR SWITCH POWER PACK		THERMOSTAT - FURNISHED BY DIVISION 15, INSTALLED BY DIVISION 16	48 INCHES		UNIT HEATER	48 INCHES	AF	ABOVE FINISHED FLOOR		
	CONTACTOR (NUMBER INDICATES NUMBER OF POLES)		THERMAL SWITCH (MOTOR OVERLOAD TYPE)	48 INCHES		POWER POLE	48 INCHES	AHU	AIR HANDLING UNIT		
	SINGLE POLE (HORSEPOWER RATED WHEN USED AS MOTOR DISCONNECT)		MOTOR (NUMBER REFERS TO MOTOR AND EQUIPMENT SCHEDULE SEE SCHEDULE FOR WIRING AND CONTROLLER REQUIREMENTS)	48 INCHES		LIGHTING AND APPLIANCE PANELBOARD	48 INCHES	BC	BELOW COUNTER		
	DOUBLE POLE		LIGHTING AND APPLIANCE PANELBOARD	48 INCHES		RECESSED LIGHTING AND APPLIANCE PANELBOARD	48 INCHES	C	CONDUIT		
	3-WAY		SWITCHBOARD OR MOTOR CONTROL CENTER AS NOTED	48 INCHES		SPECIAL EQUIPMENT CABINET AS NOTED	48 INCHES	CUH	CABINET UNIT HEATER		
	4-WAY		ENCLOSED MOLDED CASE CIRCUIT BREAKER	48 INCHES		VARIABLE FREQUENCY CONTROLLER WITH CONTROLLER	48 INCHES	EF	EXHAUST FAN		
	OCCUPANCY SENSOR SWITCH		NON-FUSED DISCONNECT	48 INCHES		FUSED DISCONNECT	48 INCHES	EW	ELECTRIC WATER COOLER		
	KEY OPERATED		MAGNETIC STARTER	48 INCHES		COMBINATION STARTER-DISCONNECT	48 INCHES	FA	FIRE ALARM		
	WITH PILOT LIGHT (CAN BE USED WITH OTHER SWITCH TYPES)			48 INCHES			48 INCHES	GFCI	GROUND FAULT CIRCUIT INTERRUPTER		
	MOMENTARY CONTACT			48 INCHES			48 INCHES	GR	GROUND		
	DIMMER (600 WATT UNLESS OTHERWISE NOTED)			48 INCHES			48 INCHES	PH	PHASE		
	LIGHTING INTENSITY SELECTOR PANEL			48 INCHES			48 INCHES	TV	TELEVISION		
	LOW VOLTAGE SWITCH			48 INCHES			48 INCHES	W	WIRE		
				48 INCHES			48 INCHES	WP	WEATHERPROOF		

NOTES:
1. THIS IS A COMPREHENSIVE SYMBOL SCHEDULE. NOT ALL SYMBOLS ARE APPLICABLE TO THESE DRAWINGS. 3. FOR DEVICES SHOWN AS 48 INCHES MOUNTING HEIGHT, WHEN INSTALLED IN MASONRY BLOCK WALLS, MOUNTING AT 48 INCHES TO THE TOP OF THE OUTLET BOX IS ACCEPTABLE.
2. MOUNTING HEIGHT IS TO THE CENTER OF DEVICE UNLESS OTHERWISE INDICATED.

LUMINAIRE SCHEDULE									
TYPE	MANUFACTURERS	CATALOG INFORMATION	FIXTURE DESCRIPTION	LED DATA	DRIVER DATA	VOLTAGE	INPUT WATTS	MOUNTING	REMARKS
A1	LITHONIA OR EQUAL	CPX SERIES	2 FOOT X 4 FOOT LAY-IN LED PANEL, ALUMINUM DOOR FRAME WITH MITERED CORNERS, ACRYLIC FROSTED SMOOTH LENS, BACKLIT PANEL.	6000 LUMENS 3500K	0-10V DIMMING LED DRIVER	120	42	RECESSED	
A2	METALIX OR EQUAL	CPX SERIES	2 FOOT X 4 FOOT LAY-IN LED, ALUMINUM DOOR FRAME WITH MITERED CORNERS, ACRYLIC FROSTED SMOOTH LENS, BACKLIT PANEL.	7200 LUMENS 3500K	0-10V DIMMING LED DRIVER	120	57	RECESSED	
A3	METALIX OR EQUAL	CPX SERIES	2 FOOT X 4 FOOT LAY-IN LED, ALUMINUM DOOR FRAME WITH MITERED CORNERS, ACRYLIC FROSTED SMOOTH LENS, BACKLIT PANEL.	8,500 LUMENS 3500K	0-10V DIMMING LED DRIVER	120	70.9	RECESSED	
A4	METALIX OR EQUAL	CPX SERIES	2 FOOT X 4 FOOT LAY-IN LED, ALUMINUM DOOR FRAME WITH MITERED CORNERS, ACRYLIC FROSTED SMOOTH LENS, BACKLIT PANEL.	10,000 LUMENS 3500K	0-10V DIMMING LED DRIVER	120	87.6	RECESSED	
C1	LITHONIA OR EQUAL	WF6 SERIES	6" ROUND WAFER SWITCHABLE WHITE COLOR TEMP, WITH WAFER MODULE, NET LOCATION LISTED.	1200 LUMENS 80 CRI 3500K	0-10V DIMMING	120	15W	RECESSED	PAINT TRIM WITH ARCHITECT PREFERRED COLOR.
E1	SURE-LITES OR EQUAL	APX SERIES	SINGLE FACE EXIT LIGHT, NICKEL CADMIUM BATTERY, WHITE THERMOPLASTIC HOUSING, GREEN LETTERS.	LED		120	1	UNIVERSAL	
E2	SURE-LITES OR EQUAL	APX SERIES	DOUBLE FACE EXIT LIGHT, NICKEL CADMIUM BATTERY, WHITE THERMOPLASTIC HOUSING, GREEN LETTERS.	LED		120	1	UNIVERSAL	
E3	SURE-LITES OR EQUAL	LPXC SERIES	EXIT LIGHT WITH 2 ADJUSTABLE EMERGENCY LIGHTING HEADS, NICKEL CADMIUM BATTERY, WHITE THERMOPLASTIC HOUSING, GREEN LETTERS.	LED		120	1.5	UNIVERSAL	PROVIDE WITH EXTERIOR OR 3W LED REMOTE HEADS WHERE INDICATED ON PLANS.
EM	DUAL LITE OR EQUAL	LZ SERIES	WALL MOUNTED EMERGENCY BATTERY, (2) ADJUSTABLE LED HEADS, LEAD-CALCIUM BATTERY,	LED		120	3.5	SURFACE	PROVIDE WITH EXTERIOR OR 3W LED REMOTE HEADS WHERE INDICATED ON PLANS.
EM1	ISOLITE	SEL50 SERIES	EMERGENCY BATTERY FIXTURE, WHITE POLYCARBONATE HOUSING, ROUND ADJUSTABLE LAMP HEADS, NICKEL CADMIUM BATTERY	220 LUMENS PER HEAD	INTEGRAL	120	3	SURFACE	IN PARKING GARAGES. EQUAL FIXTURES MUST MEET OR EXCEED 50 FEET SPACING OF THIS FIXTURE.
*ALL LIGHTING FIXTURES' FINISH AND MOUNTING HEIGHT TO BE VERIFIED WITH ARCHITECT/OWNER PRIOR TO PURCHASE.									
*EC TO VERIFY FIRE RATING FOR RECESSED CEILING. PROVIDE FIRE CAP FOR RECESSED FIXTURE WHERE REQUIRED PER FIRE-RATED CEILING.									

LUMINAIRE SCHEDULE									
TYPE	MANUFACTURERS	CATALOG INFORMATION	FIXTURE DESCRIPTION	LED DATA	DRIVER DATA	VOLTAGE	INPUT WATTS	MOUNTING	REMARKS
F1	COOPER OR EQUAL	SNLED SERIES	4-FOOT LED SEMI-FROSTED LENSED STRIP LIGHT. PROVIDE CHAIN MOUNTING KIT.	5200 LUMENS 3500K	0-10V DIMMING LED DRIVER	120	39	SURFACE	
N1	LITHONIA OR EQUAL	WF6 SERIES	6" ROUND WAFER SWITCHABLE WHITE COLOR TEMP, WITH WAFER MODULE, NET LOCATION LISTED.	1100 LUMENS 80 CRI 4000K	0-10V DIMMING	120	15W	RECESSED	PAINT TRIM WITH ARCHITECT PREFERRED COLOR.
W1	EXTANT-TM OR EQUAL	HUNTINGTON 3 HTG-SR-LP SERIES	6-FOOTER, 1.5 INCH APERTURE, RECESSED LED, INTEGRAL DRIVER, EXTRUDED ALUMINUM HOUSING, HIGH TRANSMITTANCE EXTRUDED POLYCARBONATE LENS, HIGH LUMEN OUTPUT. TRIM FLANGE TO BE VERIFIED WITH ARCHITECT.	6500 LUMENS 3500K	0-10V DIMMING	120	57	RECESSED	PROVIDE WOOD CEILING RECESSED MOUNTING ACCESSORIES INCLUDING BRACES. VERIFY CEILING HEIGHT AND MOUNTING WITH ARCHITECT.
W1	LITHONIA OR EQUAL	WDGE 2 SERIES	SURFACE EXTERIOR WALL FIXTURE, DIE-CAST ALUMINUM HOUSING, VISUAL COMFORT FORWARD THROW OPTIC TFM, P2 DISTRIBUTION, BRONZE FINISH. VERIFY FINISH WITH ARCHITECT. ABOVE EXTERIOR MAIN DOORS.	4000K LED 2000 LUMENS	0-10V DIMMING	120	19	WALL	VERIFY MOUNTING HEIGHT WITH ARCHITECT.
W2	LITHONIA OR EQUAL	WDGE 3 SERIES	SURFACE EXTERIOR WALL FIXTURE, DIE-CAST ALUMINUM HOUSING, VISUAL COMFORT FORWARD THROW OPTIC TFM, P4 DISTRIBUTION, BRONZE FINISH. VERIFY FINISH WITH ARCHITECT.	4000K LED 12000 LUMENS	0-10V DIMMING	120	88	WALL	VERIFY MOUNTING HEIGHT WITH ARCHITECT.
P1	EMER LIGHTING OR EQUAL	CPLED SERIES	14" x 14" LED GARAGE FIXTURE, VANDAL RESISTANT FROSTED POLYCARBONATE LENS, IP 66 RATED, DIE CAST ALUMINUM HOUSING, BRONZE FINISH. WITH IN BUILT OCCUPANCY SENSOR. WHEN ONE SENSOR TURNS ON ALL LIGHTS IN THE GARAGE TURN ON.	LED LUMENS 7000 4000K	0-10V DIMMING	120	56	SURFACE	GARAGE
*ALL LIGHTING FIXTURES' FINISH AND MOUNTING HEIGHT TO BE VERIFIED WITH ARCHITECT/OWNER PRIOR TO PURCHASE.									

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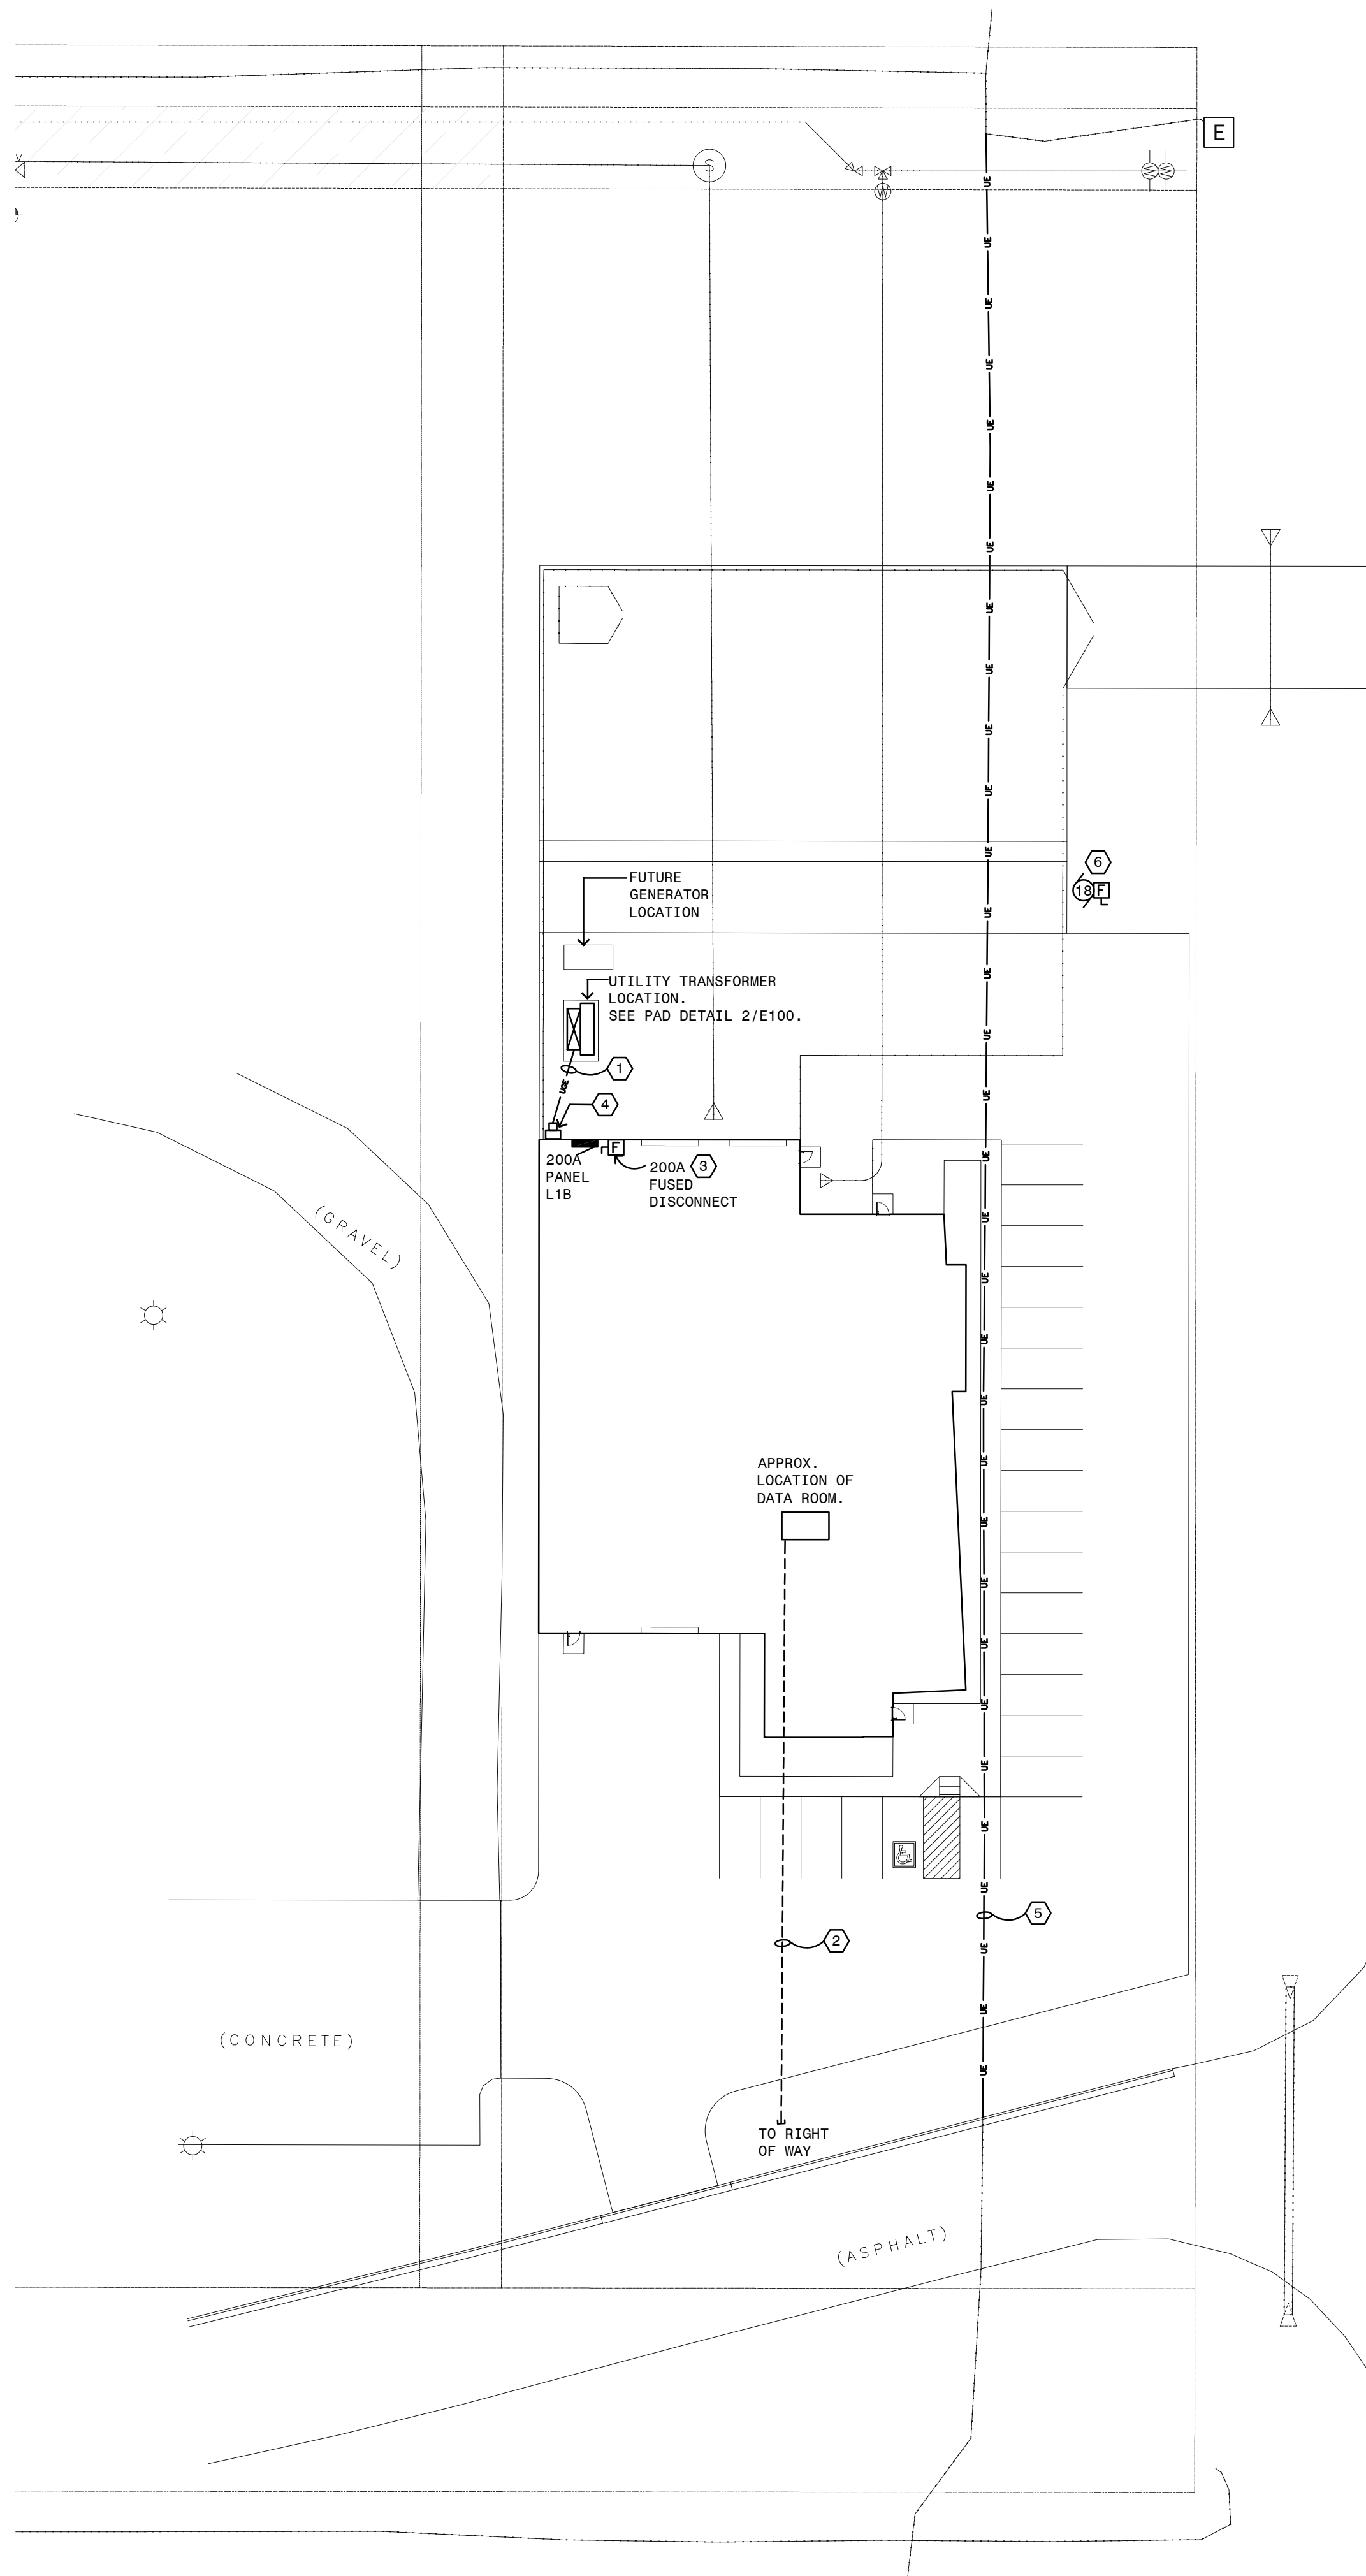
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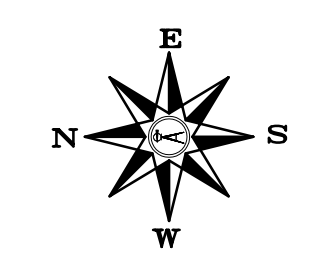
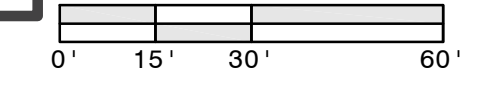
ELECTRICAL SITE PLAN

SHEET

E100



1 E100 FIRST FLOOR LIGHTING PLAN - ELECTRICAL




GENERAL NOTES:


1. VERIFY ALL REQUIREMENTS OF UTILITY TRANSFORMER WITH UTILITY COMPANY NORTH CENTRAL ELECTRIC COOP (NCECI).
2. COORDINATE LOCATION AND ROUTING OF SITE CONDUITS WITH OTHER SITE UTILITIES.
3. ALL SITE CONDUITS SHALL BE AT LEAST 24 INCHES BELOW GRADE.
4. SEE DETAIL 3/E100 FOR EXTERIOR LIGHTING CONTROLS.
5. ELECTRICAL CONTRACTOR TO COORDINATE AND VERIFY WITH UTILITY COMPANY FOR TELECOM EASEMENT REQUIREMENTS PRIOR TO ROUGH-IN.
6. SEE TRANSFORMER PAD DETAIL ON THIS SHEET.

PLAN NOTES:


1. SEE RISER DIAGRAM ON SHEET E500 FOR FEEDER SCHEDULE.
2. PROVIDE (2) 3 INCH CONDUITS FROM DATA ROOM TO PROPERTY LINE AND EXTEND CONDUITS AS NEEDED FOR TELECOMMUNICATIONS SERVICE ENTRANCE. VERIFY SERVICE POINT WITH TELECOM PROVIDER.
3. FUSED DISCONNECT FOR ELECTRICAL PANEL L1A LOCATED IN ELECTRICAL ROOM #115. SEE SHEET E300 FOR DETAILS.
4. 320A METER SOCKET PER UTILITY COMPANY REQUIREMENTS. SEE RISER DIAGRAM ON SHEET E500.
5. COORDINATE WITH THE UTILITY COMPANY FOR RELOCATING THE UNDER GROUND ELECTRICAL UTILITY SERVICE PRIOR TO FOUNDATION WORK. EC RESPONSIBLE TO INCLUDE UTILITY COMPANY FEES IN THE BIDS FOR RELOCATING THE SERVICE. ANY DISCREPANCIES NEED TO BE BROUGHT TO ENGINEER'S ATTENTION PRIOR TO BIDDING.
6. PROVIDE 208V, THREE PHASE CONNECTION TO ELECTRIC VAPORIZER SUPPLIED BY MECHANICAL CONTRACTOR. VERIFY EXACT LOCATION AND REQUIREMENTS WITH MC. PROVIDE 30A DISCONNECT FUSED AT 30A. THE DISCONNECT IS TO BE RATED FOR CLASS 1, DIVISION 2 LOCATION. PROVIDE SEAL OFF AT THE BUILDING PRIOR TO ENTERING THE GROUND. CONNECT TO ELECTRICAL PANEL L1B CIRCUIT NUMBERS 19, 21, 23. SEE MOTOR AND EQUIPMENT SCHEDULE ON SHEET E500.

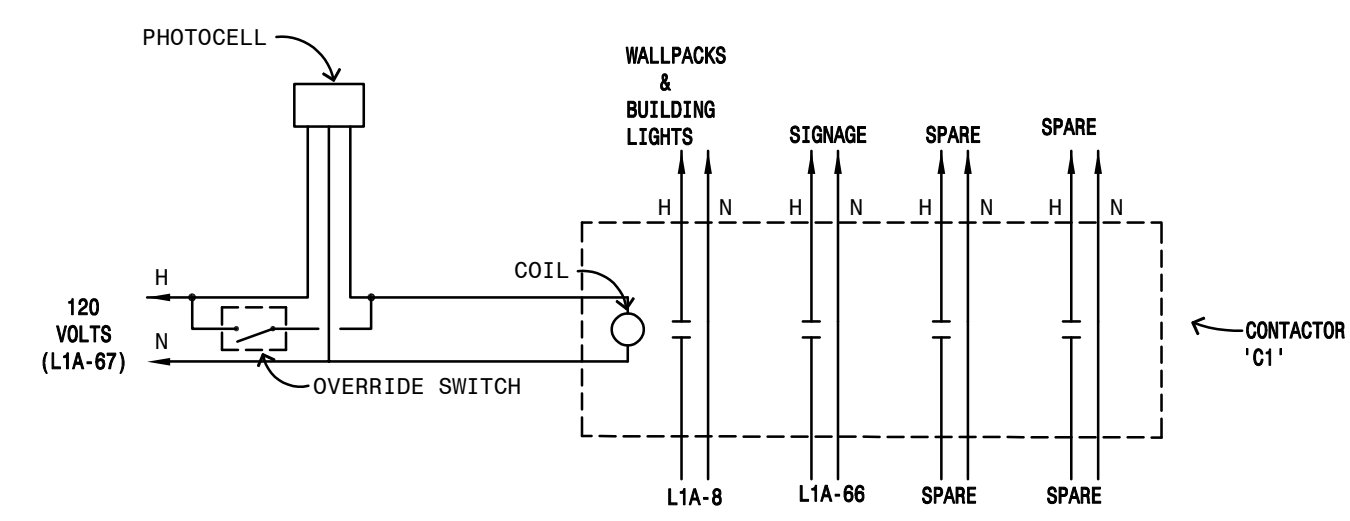

3 E100 EXTERIOR LIGHTING/CONTACTOR DETAIL
NO SCALE

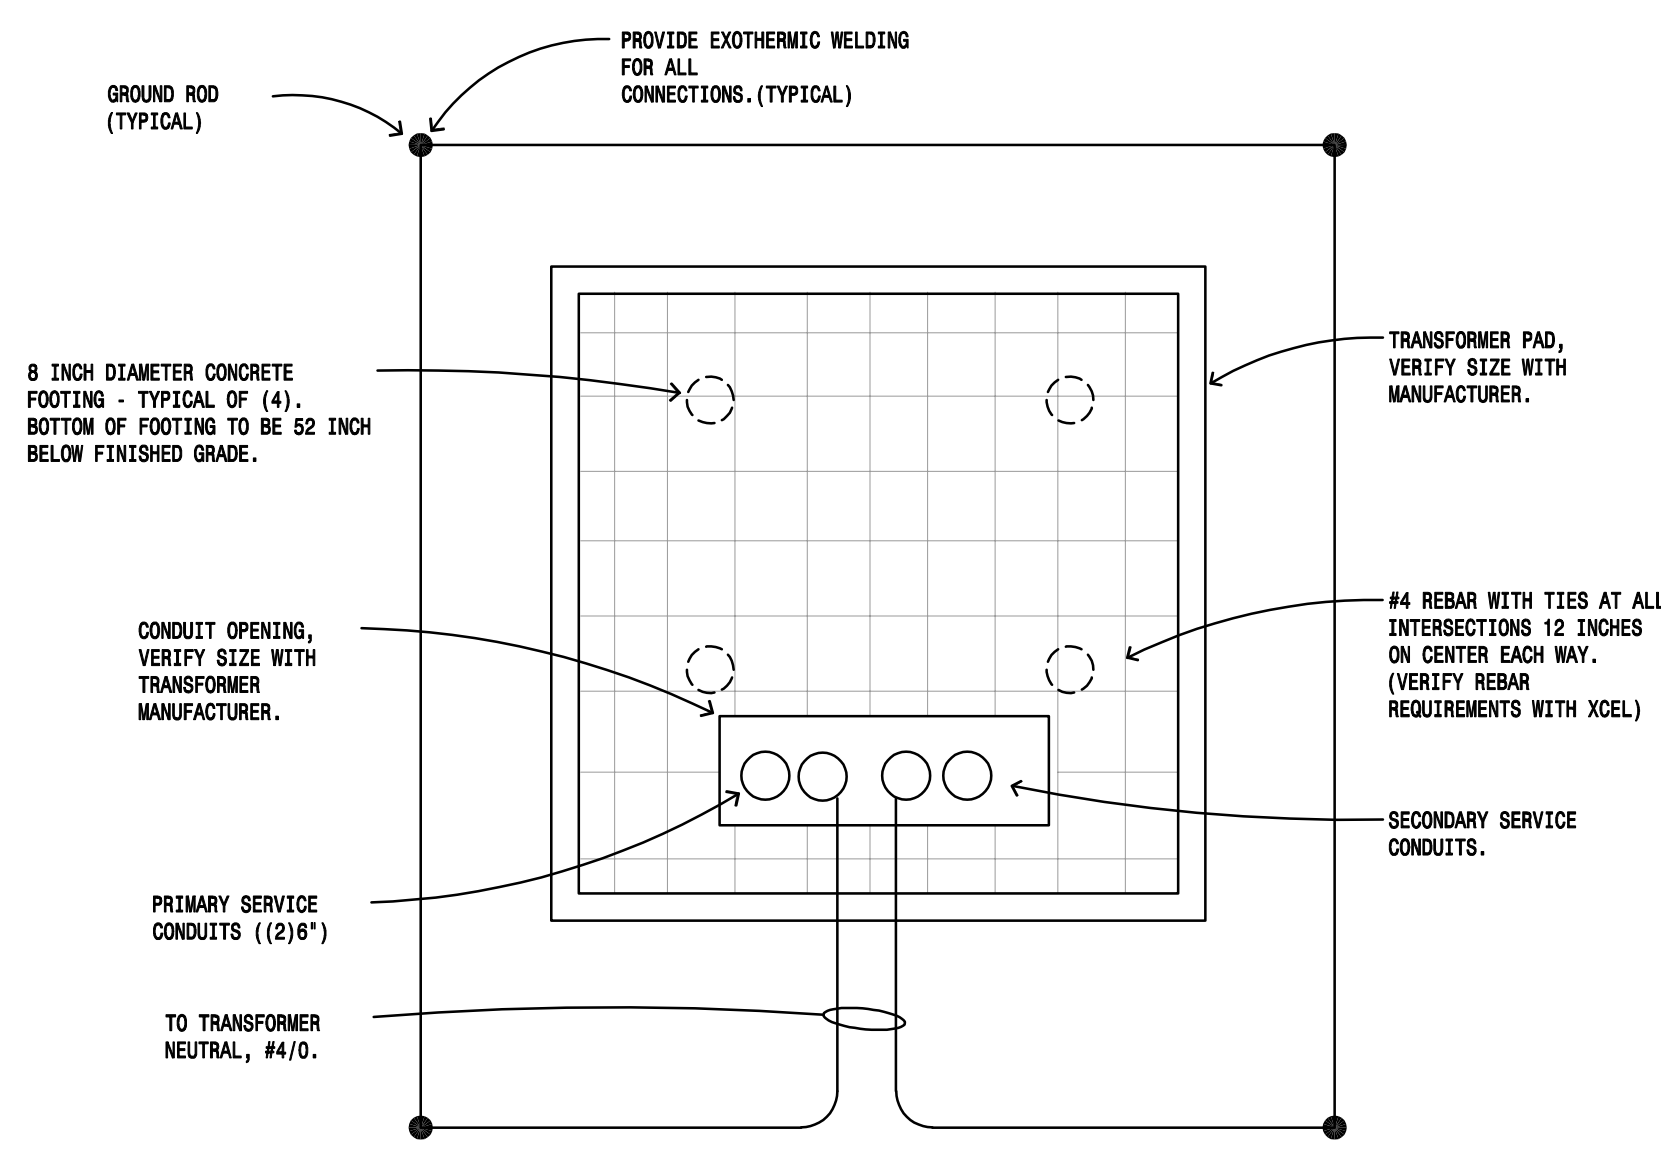

2 E100 TRANSFORMER PAD DETAIL
NO SCALE

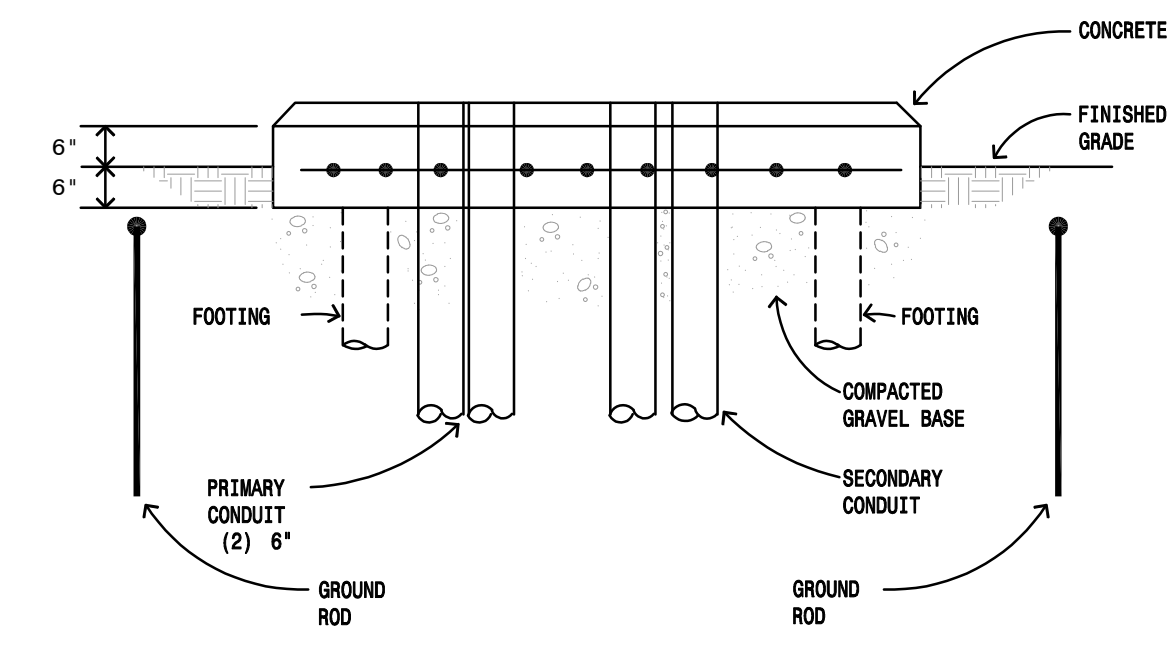

1. EC TO COORDINATE AND VERIFY EXACT PAD REQUIREMENTS FROM NORTH CENTRAL ELECTRIC COOP (NCECI) PRIOR TO BEGINNING OF CONSTRUCTION.
2. EC TO CONTACT NORTH CENTRAL ELECTRIC COOP (NCECI) AFTER THE PAD HAS BEEN FORMED AND PRIOR TO CONCRETE POURING.


OCCUPANCY SENSOR SCHEDULE			
TYPE/SYMBOL	MANUFACTURER	MODEL #	DESCRIPTION
Ⓜ _A	WATTSTOPPER	CI-355	LINE VOLTAGE PASSIVE INFRARED CEILING SENSOR
Ⓜ _B	WATTSTOPPER	LMDC-100	LOW VOLTAGE DIGITAL DUAL TECH CEILING SENSOR
RC	WATTSTOPPER	LMRC-212	2-ZONE 0-10V DIMMING ROOM CONTROLLER. SEE PLAN NOTES.
Ⓢ _{IV}	WATTSTOPPER	CS-50	PASSIVE INFRARED WALL VACANCY SWITCH.
Ⓢ _{LV}	WATTSTOPPER	LMSW-105	4 BUTTON LOW VOLTAGE CONTROL SWITCH WITH DIMMING
Ⓢ _{DM}	WATTSTOPPER	DW-311	DUAL TECH WALL VACANCY SWITCH WITH DIMMING.
Ⓢ _{DV}	WATTSTOPPER	LMDM-101	DIGITAL DIMMING WALL SWITCH, 1PADDLE, W.I.R..
Ⓢ			TOGGLE SWITCH

GENERAL NOTES:

- ELECTRICAL CONTRACTOR RESPONSIBLE FOR ALL LOW VOLTAGE WIRING CONNECTIONS.
- COORDINATE WITH MECHANICAL DUCT WORK AND PIPING PRIOR TO INSTALLATION OF ANY LIGHTING FIXTURES.
- OCCUPANCY SENSOR LOCATION TO BE ADJUSTED ACCORDING TO MANUFACTURER RECOMMENDATION.
- MARKED WITH "NL" AND SHADED FIXTURE TO REMAIN ON UNSWITCHED CIRCUIT. FIXTURE TO BE ON AT ALL TIMES.
- GARAGE CEILING IS SLOPED CEILING. PROVIDE MOUNTING ACCESSORIES FOR FIXTURE TYPE P1 AS NEEDED TO SURFACE MOUNT FIXTURES.
- ALL EXTERIOR BUILDING MOUNTED FIXTURE MOUNTING HEIGHT TO BE VERIFIED WITH ARCHITECT PRIOR TO ROUGH-IN.
- FIXTURE P1 IN GARAGE TO HAVE IN-BUILT MOTION SENSOR EXCEPT FIXTURES WHICH ARE SHADES AND NOTED WITH "NL" ON AT ALL TIMES.

LIGHTING PLAN NOTES:


- PROVIDE LIGHTING CONTACTOR C1 TO CONTROL EXTERIOR LIGHTING. SEE DETAIL ON SHEET 3/E100.
- CONNECT TO ROOM CONTROLLER.
- PROVIDE 2-ZONE ROOM CONTROLLER LMRC-212 OR EQUAL.
- PROVIDE PHOTOCELL FOR EXTERIOR LIGHTING CONTROLS. SEE DETAIL 3/E100.
- MECHANICAL ROOM: COORDINATE FIXTURE MOUNTING WITH MECHANICAL EQUIPMENT, PIPING AND DUCTWORK PRIOR TO ROUGH-IN. PROVIDE MOUNTING ACCESSORIES AS NEEDED TO MOUNT FIXTURE UNDER DUCT WORK.
- PROVIDE 1-ZONE ROOM CONTROLLER LMRC-211 OR EQUAL.
- PROVIDE REMOTE EMERGENCY BATTERY PACK INSIDE THE BUILDING ABOVE LAY IN CEILING FOR EXTERIOR FIXTURE. PROVIDE SURE-LITES (OR EQUAL) EBPLED14W BATTERY PACK. BATTERY PACK TO POWER FIXTURE UPON LOSS OF POWER FOR 90 MINS. MOUNT ABOVE DOOR INSIDE THE FRONT OFFICE LAY IN CEILING.
- MOUNT FIXTURE 18 INCHES ABOVE DOOR. VERIFY MOUNTING HEIGHT WITH ARCHITECT/ARCHITECTURAL ELEVATIONS.
- LIGHTING CONTROL SWITCH FOR CUSTOMER SERVICE AREA.
- ROOM CONTROLLER FOR CUSTOMER SERVICE ROOM #102.

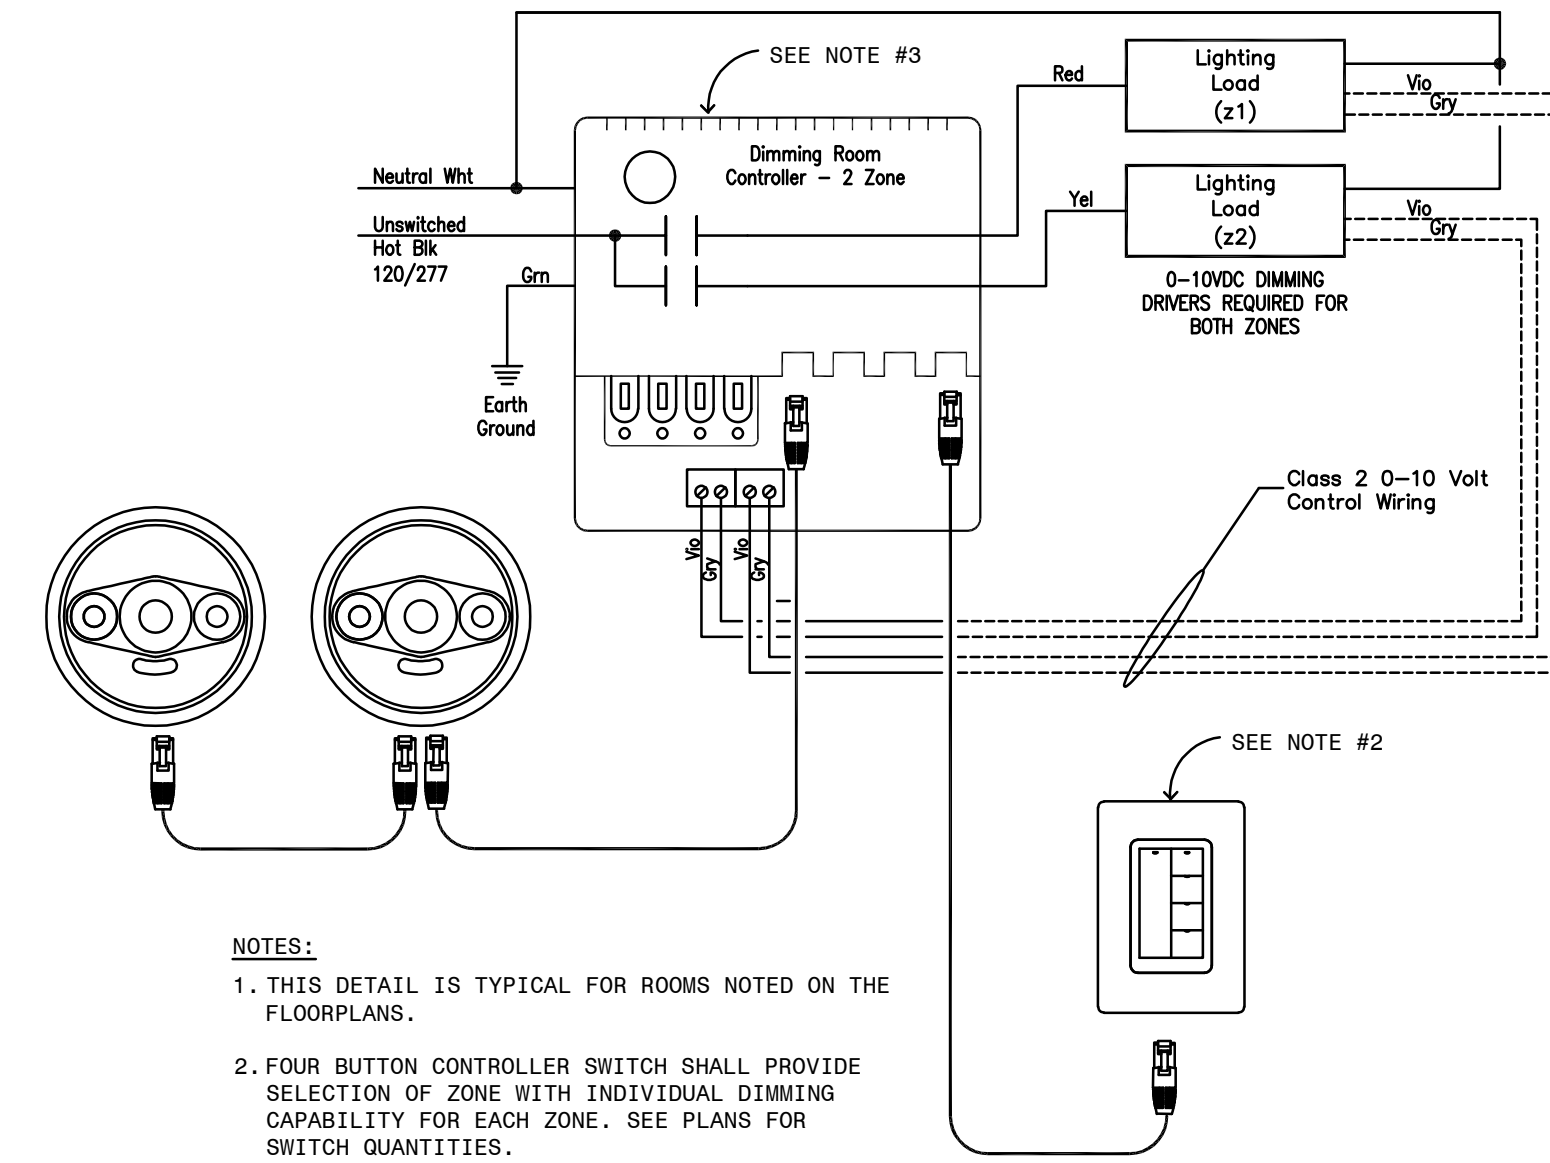

NOTES:

- THIS DETAIL IS TYPICAL FOR ROOMS NOTED ON THE FLOORPLANS.
- FOUR BUTTON CONTROLLER SWITCH SHALL PROVIDE SELECTION OF ZONE WITH INDIVIDUAL DIMMING CAPABILITY FOR EACH ZONE. SEE PLANS FOR SWITCH QUANTITIES.
- ROOM CONTROLLER TO BE 1-ZONE OR 2-ZONE CONTROLLER WITH 0-10V DIMMING.
- LIGHTS SHALL BE CONFIGURED FOR MANUAL ON AND AUTO-OFF.

2 E200 TYPICAL OFFICE/TRAINING/WORKSTATION ROOM LIGHTING CONTROL DETAIL
NOT TO SCALE

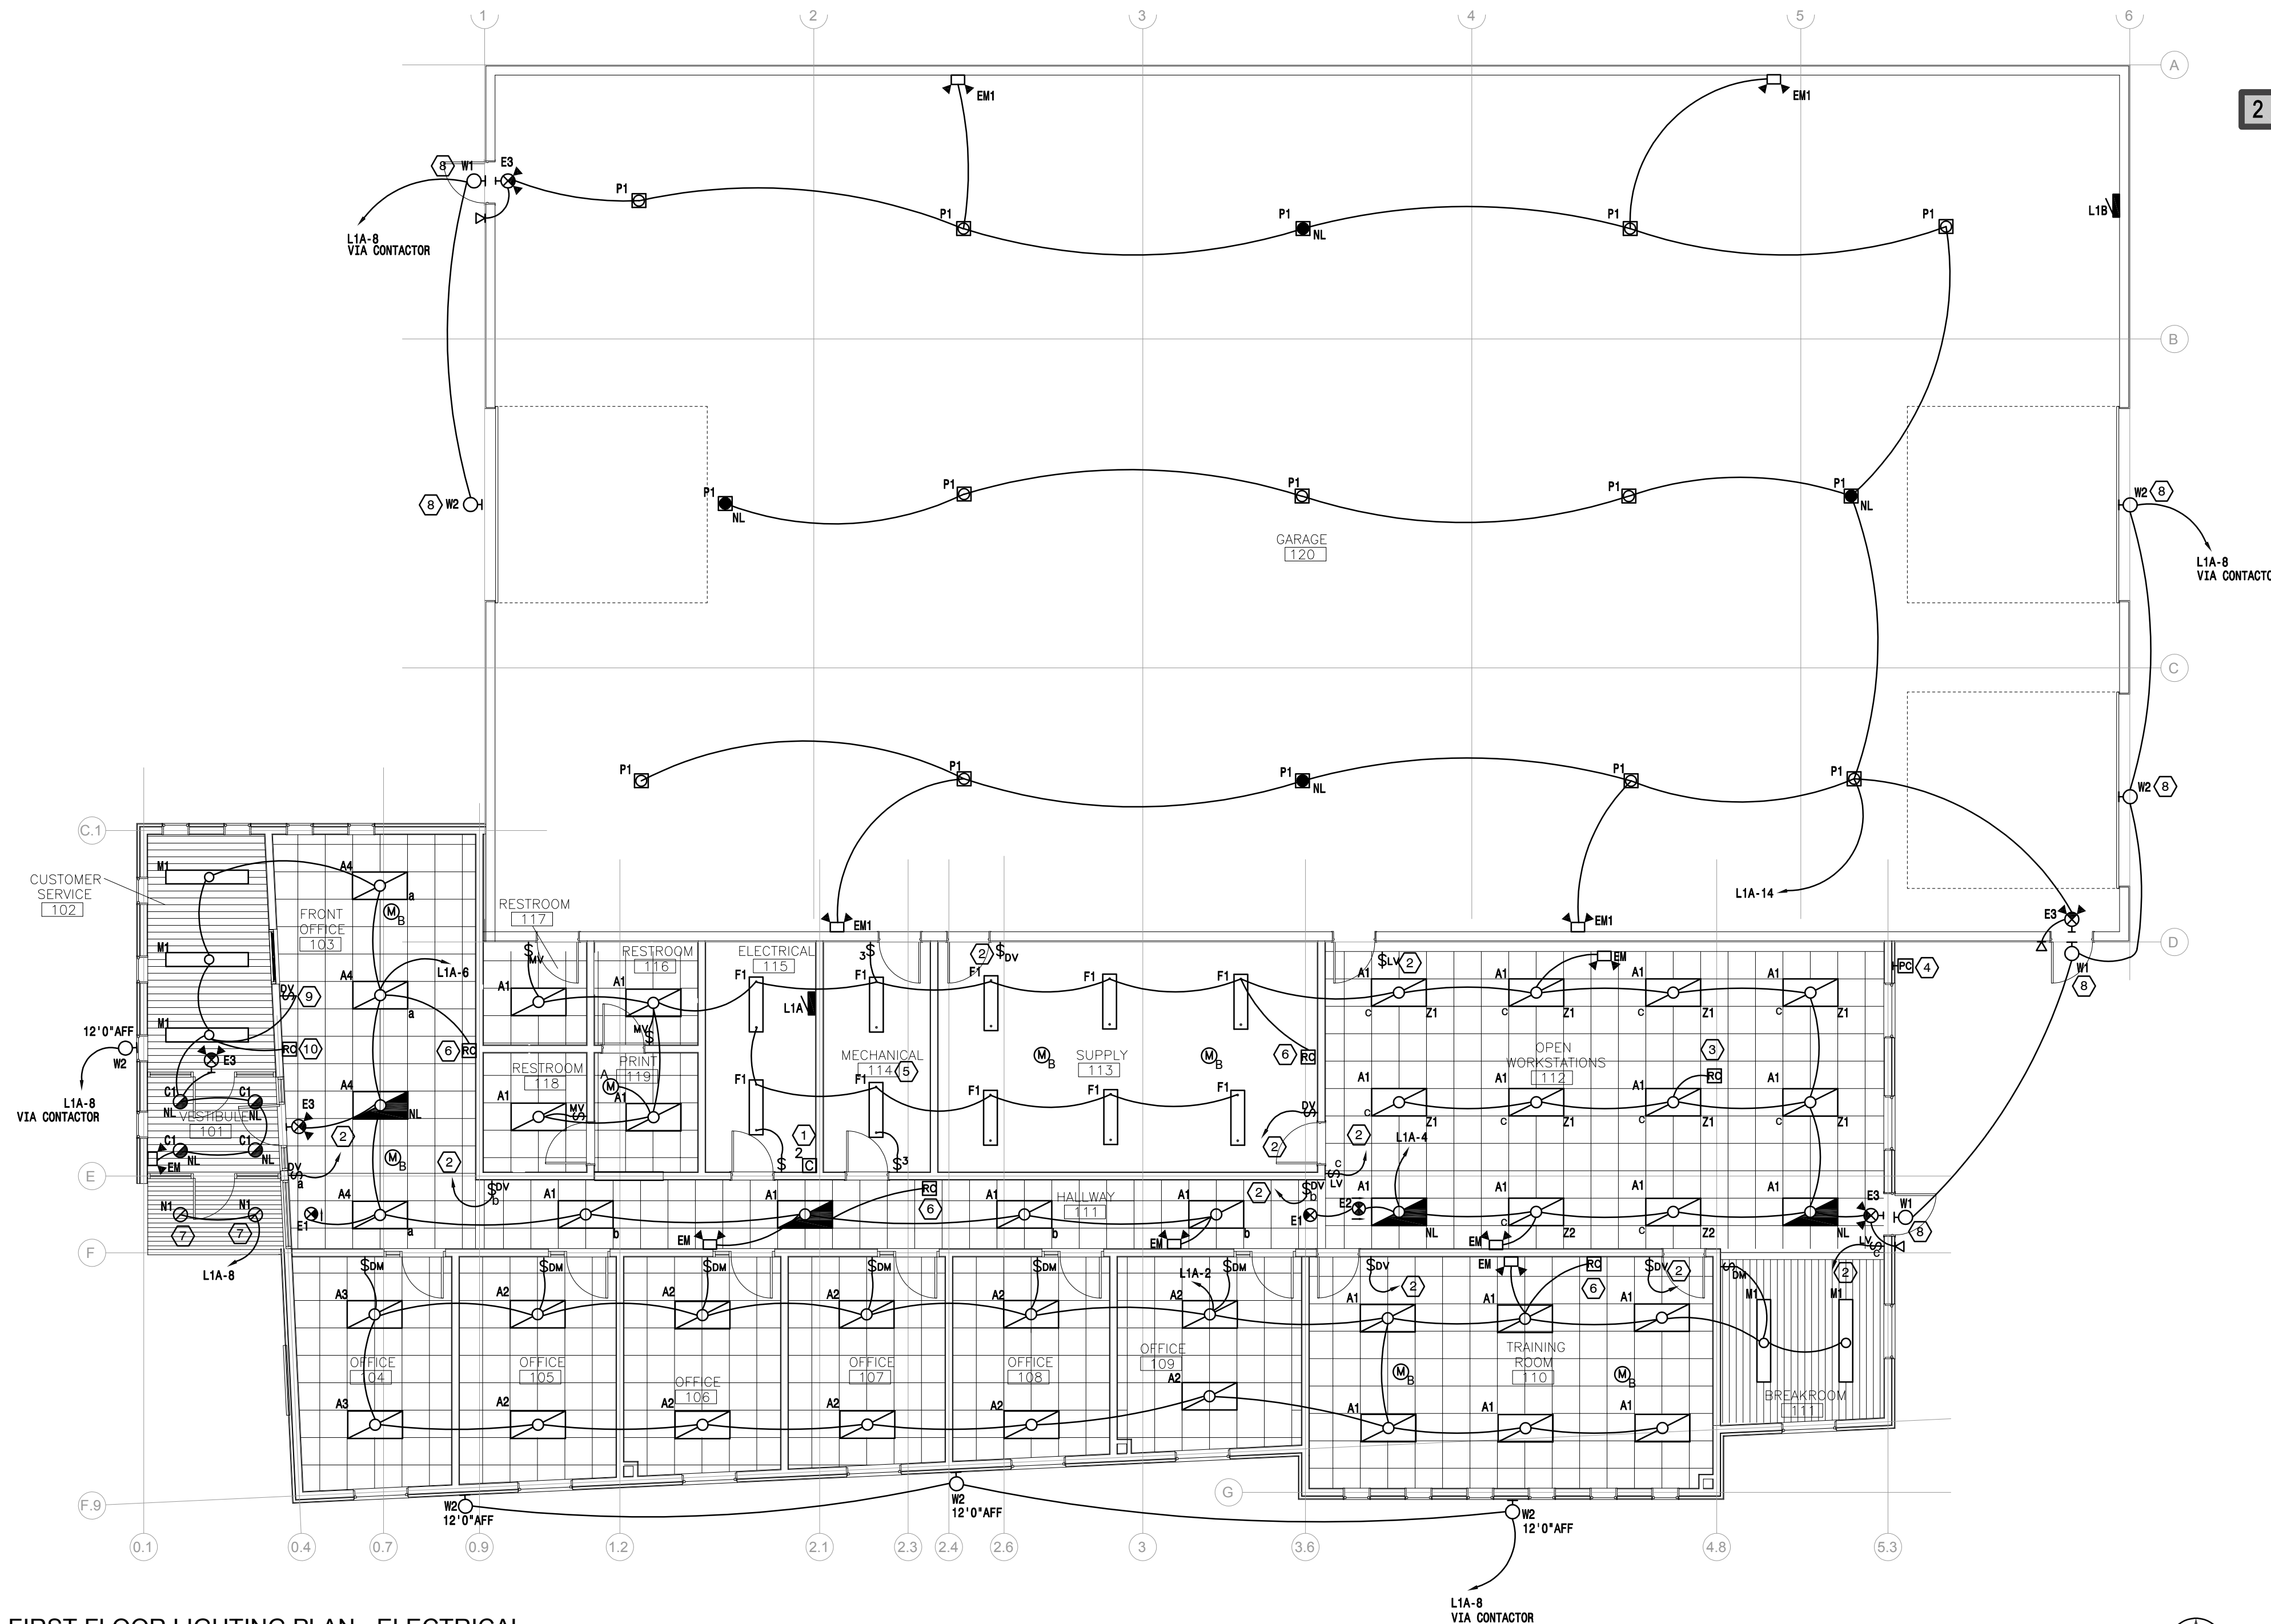

1 E200 FIRST FLOOR LIGHTING PLAN - ELECTRICAL
1/8" = 1'-0"



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FIRST FLOOR LIGHTING PLAN

SHEET

E200



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FIRST FLOOR POWER PLAN

SHEET


E300

GENERAL NOTES: (POWER)


1. ALL RECEPTACLES TO BE TAMPERPROOF AS PER NEC 406.12.
2. LABEL ALL RECEPTACLE COVER PLATES WITH CIRCUIT # AND PANEL NAME.
3. REFER TO ARCHITECTURAL ELEVATIONS FOR EXACT MOUNTING HEIGHTS AND LOCATIONS OF WALL MOUNTED DEVICES. CLOSE COORDINATION WITH THE MECHANICAL CONTRACTOR IS REQUIRED TO INSTALL MANY OF THE REQUIRED DEVICES.
4. VERIFY ALL EQUIPMENT EXACT LOCATIONS PRIOR TO INSTALLATION.
5. COORDINATE AND VERIFY EXACT LOCATIONS OF FLOOR BOXES WITH ARCHITECT AND FURNITURE INSTALLER.
6. VERIFY MOTOR EQUIPMENT LOCATIONS WITH MECHANICAL CONTRACTOR.
7. VERIFY DEVICE LOCATIONS WITH FURNITURE INSTALLER.
8. ALL BREAKROOM RECEPTACLES TO BE GFCI PROTECTED PER NEC.
9. GARAGE AREA RECEPTACLE MOUNTING HEIGHT TO BE VERIFIED WITH ARCHITECT/OWNER.
10. VERIFY POWER REQUIREMENTS FOR OWNER PROVIDED DATA RACK WITH OWNER/ARCHITECT. VERIFY DATA RACK LOCATION AND MOUNTING HEIGHT FOR RECEPTACLE.
11. ALL GARAGE RECEPTACLE TO BE GFCI RATED.
12. "M" MEANS MULLION MOUNT.

POWER & SYSTEMS PLAN NOTES:

1. PROVIDE 120V CONNECTION TO COPIER/PRINTER SUPPLIED BY OWNER. COORDINATE AND VERIFY CONNECTION TYPE, LOCATION AND MOUNTING HEIGHT WITH COPIER SUPPLIER.
2. PROVIDE RECEPTACLE AT 60" IN MILLWORK FOR OWNER SUPPLIED MICROWAVE. COORDINATE AND VERIFY EXACT MOUNTING HEIGHT AND LOCATION WITH ARCHITECT AND MILLWORK SUPPLIER PRIOR TO ROUGH-IN.
3. PROVIDE 1.5KW FAN FORCED HEATER EQUAL TO QMARK AHM3150F, 120V, SINGLE PHASE WITH INTEGRAL THERMOSTAT AND DISCONNECT. CONNECT TO 20A/1P BREAKER IN PANEL L1A. VERIFY EXACT LOCATION WITH ARCHITECT. PROVIDE SEMI RECESSED KIT. VERIFY WALL RATING AND LOCATION WITH ARCHITECT.
4. PROVIDE RECEPTACLE FOR NEW DATA RACK. DATA RACK BY OWNER. VERIFY LOCATION AND MOUNTING HEIGHT WITH ARCHITECT/OWNER PRIOR TO ROUGH-IN.
5. PROVIDE RECEPTACLE AT 30 INCHES FOR REFRIGERATOR PROVIDED BY OTHERS.
6. PROVIDE 3-GANG RECESSED WALL BOX EQUAL TO ARLINGTON TVB5507 SERIES, 1-GANG FOR POWER AND 2-GANGS FOR LOW VOLTAGE CABLING. VERIFY MOUNTING HEIGHT OF DEVICES AND BOX WITH ARCHITECTURAL DETAILS.
7. PROVIDE 120V CONNECTION TO DOOR HARDWARE POWER SUPPLY.
8. PROVIDE FLOOR BOX WITH COVER PLATE EQUAL TO EVOLUTION RFB SERIES. FLOOR BOX TO HAVE (2) DUPLEX RECEPTACLE MOUNTING PLATE, (2) COMMUNICATION MOUNTING PLATE AND PROVIDE FURNITURE FEED IN OPEN WORKSTATION AREA (ROOM #112). FLOOR BOX TO BE CAST METAL, FULLY ADJUSTABLE WITH A FLANGED DIE-CAST ALUMINUM ASSEMBLY WITH BRUSHED ALUMINUM FINISH. LID TO BE FLUSH WITH FINISHED FLOOR, NO CUTOUPS. EC TO VERIFY FLOOR TYPE WITH ARCHITECT PRIOR TO PURCHASE.
9. PROVIDE 120V/20A WHIP FOR FURNITURE CONNECTION. COORDINATE WITH FURNITURE INSTALLER. VERIFY EXACT REQUIREMENTS AND MOUNTING HEIGHT WITH FURNITURE SUPPLIER.
10. PROVIDE 120 VOLT CONNECTION TO OVERHEAD DOOR OPENER. PROVIDE CONNECTION TO ALL CONTROLS AND SAFETY DEVICES.
11. PROVIDE 120V CONNECTION WITH 20A DISCONNECT TO OWNER PROVIDED SIGNAGE. VERIFY EXACT MOUNTING HEIGHT AND LOCATION WITH OWNER/ARCHITECT.
12. PROVIDE 120 VOLT CONNECTION TO POWER DOOR OPERATOR. PROVIDE CONNECTION TO ASSOCIATED PUSH PLATES.
13. UNDERGROUND CONDUITS STUBBED UP AND CAPPED FOR FUTURE AUTO TRANSFER SWITCHES AND GENERATOR CONNECTIONS. SEE RISER DIAGRAM ON SHEET E500. VERIFY LOCATION WITH OWNER/ARCHITECT.
14. PROVIDE 4.8KW FAN FORCED HEATER EQUAL TO QMARK AHM4508F, 208V, SINGLE PHASE WITH INTEGRAL THERMOSTAT AND DISCONNECT. CONNECT TO 30A/2P BREAKER IN PANEL L1A. VERIFY EXACT LOCATION WITH ARCHITECT. PROVIDE SEMI RECESSED KIT. VERIFY WALL RATING AND LOCATION WITH ARCHITECT.
15. PROVIDE 120V CONNECTION IN CABINET BELOW FOR DISHWASHER. CONNECT TO GFCI RATED CIRCUIT BREAKER.
16. PROVIDE RECEPTACLE FOR NEW ACCESS CONTROL PANEL. ACCESS CONTROL PANEL BY OWNER. VERIFY LOCATION AND MOUNTING HEIGHT WITH ARCHITECT/OWNER PRIOR TO ROUGH-IN.
17. RECEPTACLE LOCATION AND MOUNTING HEIGHT TO BE VERIFIED WITH ARCHITECT PRIOR TO ROUGH-IN.

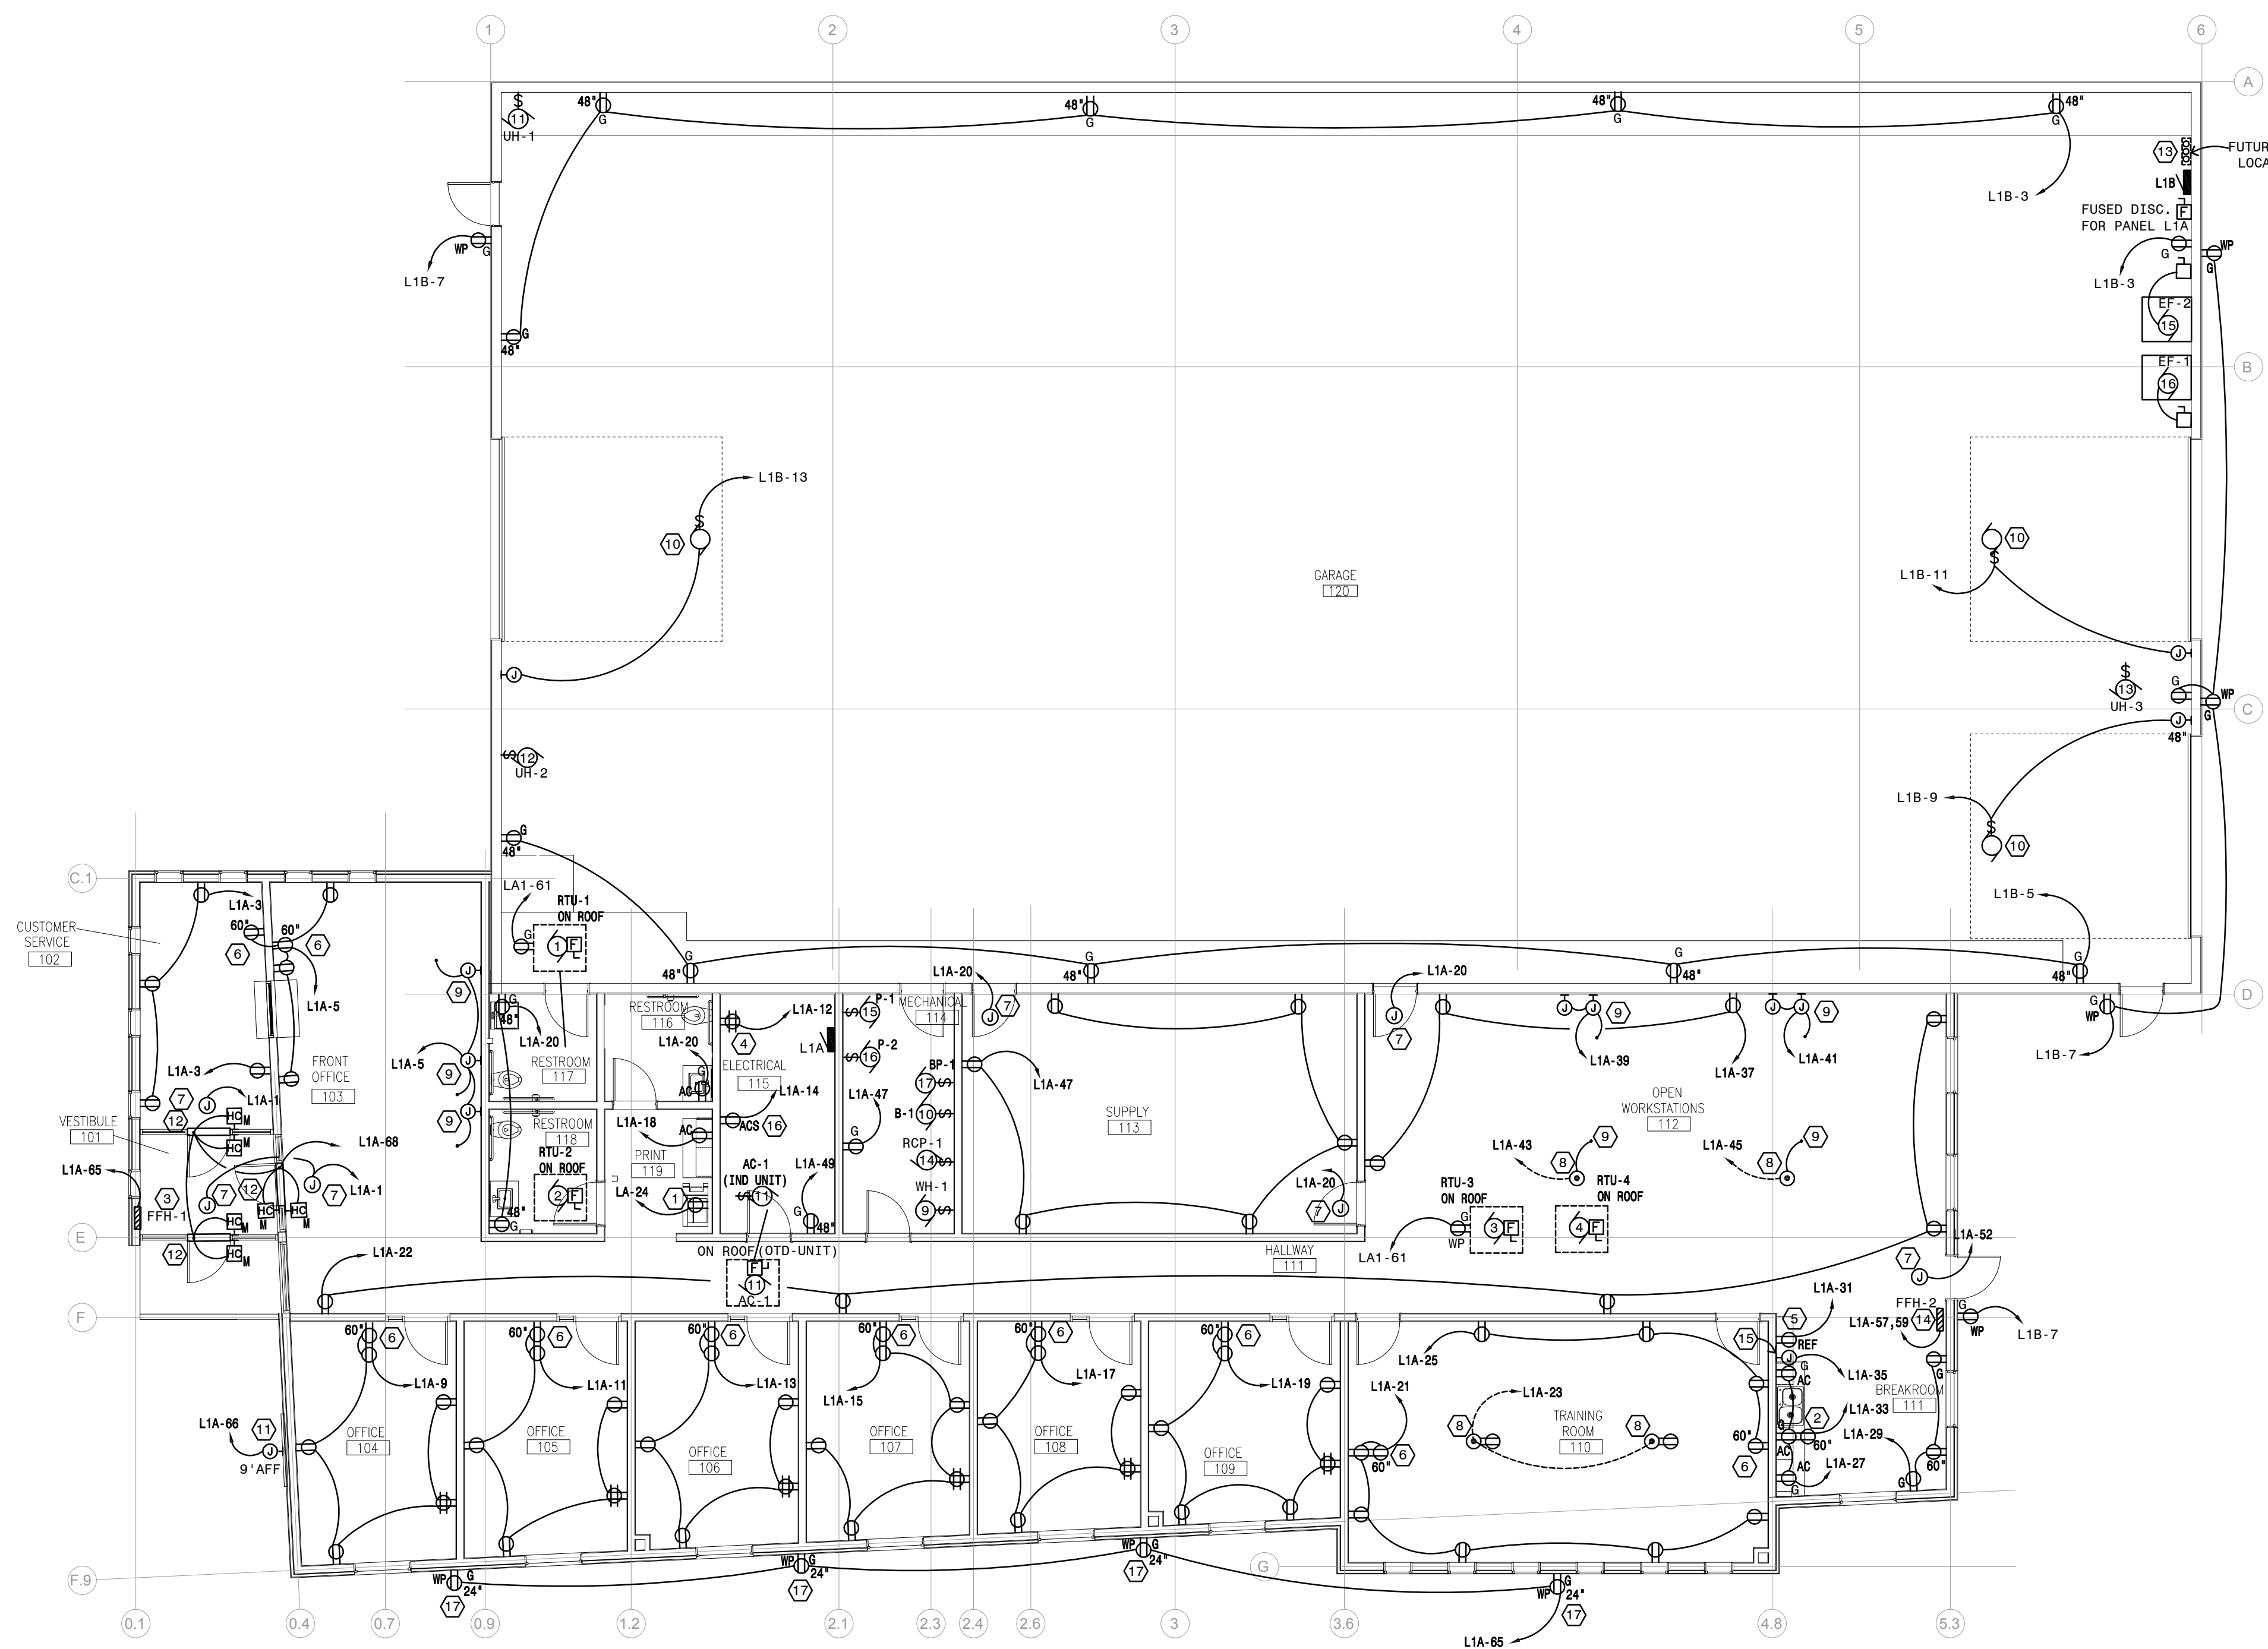

1 E300 FIRST FLOOR POWER PLAN - ELECTRICAL
1/8" = 1'-0"

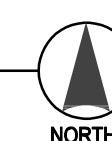



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JN: 24-054

FIRST FLOOR SYSTEMS PLAN

SHEET


E400

GENERAL NOTES:


1. PROVIDE CAT6 CABLE FROM EACH SECURITY CAMERA LOCATION BACK TO OWNER PROVIDED DATA RACK LOCATION IN ELECTRICAL ROOM #115.
2. ALL SECURITY CAMERA LOCATIONS TO BE COORDINATED WITH ARCHITECT/OWNER PRIOR TO ROUGH-IN.
3. SEE CARD ACCESS ROUGH-IN DETAILS ON SHEET ES/E600.
4. VIDEO SURVEILLANCE SYSTEM INCLUDING ALL CAMERAS BY OWNER. DATA ROUGH-IN AND INSTALLATION OF CAT 6 CABLES BY EC. CAT 6 CABLES BY OWNER. TESTING AND TERMINATION AT BOTH ENDS BY OWNER. CAT 6 CABLES WILL BE ROUTED FROM DATA ROUGH-IN LOCATION TO OWNER PROVIDED DATA RACK LOCATION IN ROOM 115.
5. ALL CAT 6 CABLES, DATA RACK AND SUPPORTING STRUCTURE, DEVICES BY OWNER. INSTALLATION OF ALL CAT 6 CABLES THROUGHOUT BY EC. TERMINATIONS AND TESTING BY OWNER.
6. DATA ROUGH-IN LOCATION IN EACH OFFICE AND WORKSTATION AREA TO BE VERIFIED WITH OWNER/ARCHITECT.
7. ALL CONDUIT RUNS INTENDED FOR VOICE/DATA CABLING WIRING SHALL BE A MINIMUM OF 3/4" EMT, RUN IN THE MOST DIRECT PATH WITH A MINIMUM AMOUNT OF BENDS TO FUTURE DATA RACK LOCATION IN ROOM #115. TELECOM CONDUITS SHALL BE ORANGE, FACTORY TINTED CONDUITS.
8. FLOORBOXES ON SYSTEM SHEET ARE SAME AS ON THE POWER SHEET.
9. VERIFY EXACT REQUIREMENTS AND LOCATION FOR DATA CABLING IN WORKSTATION AREA WITH OWNER PRIOR TO ROUGH-IN.
10. EC TO PROVIDE AND USE J-HOOKS AND SUPPORTING STRUCTURE AS NEEDED FOR ROUTING CAT 6 CABLES.

PLAN NOTES:

1. PROVIDE SINGLE GANG WALL MOUNTED JUNCTION BOX FLUSH MOUNTED WITH 3/4 INCH CONDUIT AND CAT 6 CABLE STUBBED TO ACCESSIBLE CEILING SPACE BACK TO DATA RACK LOCATION IN ROOM #115 FOR OWNER PROVIDED SECURITY CAMERA, MOUNT AT 12' ABOVE GRADE. VERIFY MOUNTING HEIGHT WITH ARCHITECT/OWNER PRIOR TO ROUGH-IN. CAT 6 CABLES PROVIDED BY OWNER AND INSTALLED BY EC. COORDINATE WITH EXTERIOR ELEVATIONS PRIOR TO ROUGH-IN.
2. PROVIDE SINGLE GANG WALL/CEILING MOUNTED JUNCTION BOX WITH 3/4 INCH CONDUIT AND CAT 6 CABLE STUBBED TO ACCESSIBLE CEILING SPACE ROUTED TO ELECTRICAL ROOM #115 FOR OWNER PROVIDED SECURITY CAMERA. VERIFY MOUNTING HEIGHT WITH ARCHITECT/OWNER. IN AREAS OF LAY-IN CEILING CAT6 CABLE CAN BE ROUTED FREE AIR. USE J-HOOKS TO SUPPORT CABLES.
3. PROVIDE ROUGH-IN FOR FUTURE CARD ACCESS, SEE DETAIL 3/E600.
4. PROVIDE BOILER EMERGENCY SHUT DOWN PUSH BUTTON. SEE SPECIFICATIONS.
5. PROVIDE (2) 1 1/4 INCH CONDUITS WITH CAT6 CABLES FROM FLOORBOX (ROOM #110 & #112) STUBBED TO ACCESSIBLE CEILING SPACE TO ELECTRICAL ROOM #115 DATA RACK LOCATION FOR DATA CABLING. COORDINATE AND VERIFY EXACT LOCATION AND REQUIREMENTS WITH FURNITURE INSTALLER. PROVIDE FURNITURE WHIP FOR DATA JACKS IN SYSTEMS FURNITURE IN ROOM #112 ONLY. IN ROOM #110, ONE CONDUIT WILL ROUTE TO EAST SIDE TV LOCATION AND THE OTHER IN WEST SIDE TV LOCATION. CAT 6 CABLES PROVIDED BY OWNER AND INSTALLED BY EC.
6. WALL MOUNTED DATA RACK BY OWNER.
7. PROVIDE GRAY PAINTED, FIRE RATED, 3/4 INCH PLYWOOD FROM FLOOR TO 8' AFF FOR FUTURE TELECOM EQUIPMENT MOUNTING.
8. PROVIDE CAT6 CABLE BACK TO ELECTRICAL ROOM #115. MOUNT TO 4 INCH SQUARE WALL BOX. VERIFY LOCATION WITH OWNER PRIOR TO ROUGH-IN.
9. PROVIDE EMPTY (2) 3" CONDUIT UNDERGROUND FOR TELECOMMUNICATION SERVICE ENTRANCE. VERIFY EXACT ROUTING AND LOCATION WITH PROVIDER.
10. PROVIDE TELECOMMUNICATION GROUNDING BAR. SEE DETAIL ON SHEET 2/E600.
11. PROVIDE FURNITURE WHIP FOR DATA JACKS IN SYSTEMS FURNITURE. COORDINATE AND VERIFY EXACT LOCATION AND REQUIREMENTS WITH FURNITURE INSTALLER. SIZE CONDUIT AS PER NUMBER OF CABLES, 1 INCH MINIMUM. DATA ROUGH-IN BY EC. INSTALLATION OF CAT 6 CABLE FROM DATA OUTLET ROUGH-IN TO DATA RACK LOCATION BY EC. DATA OUTLETS AND CAT 6 CABLES BY OWNER.

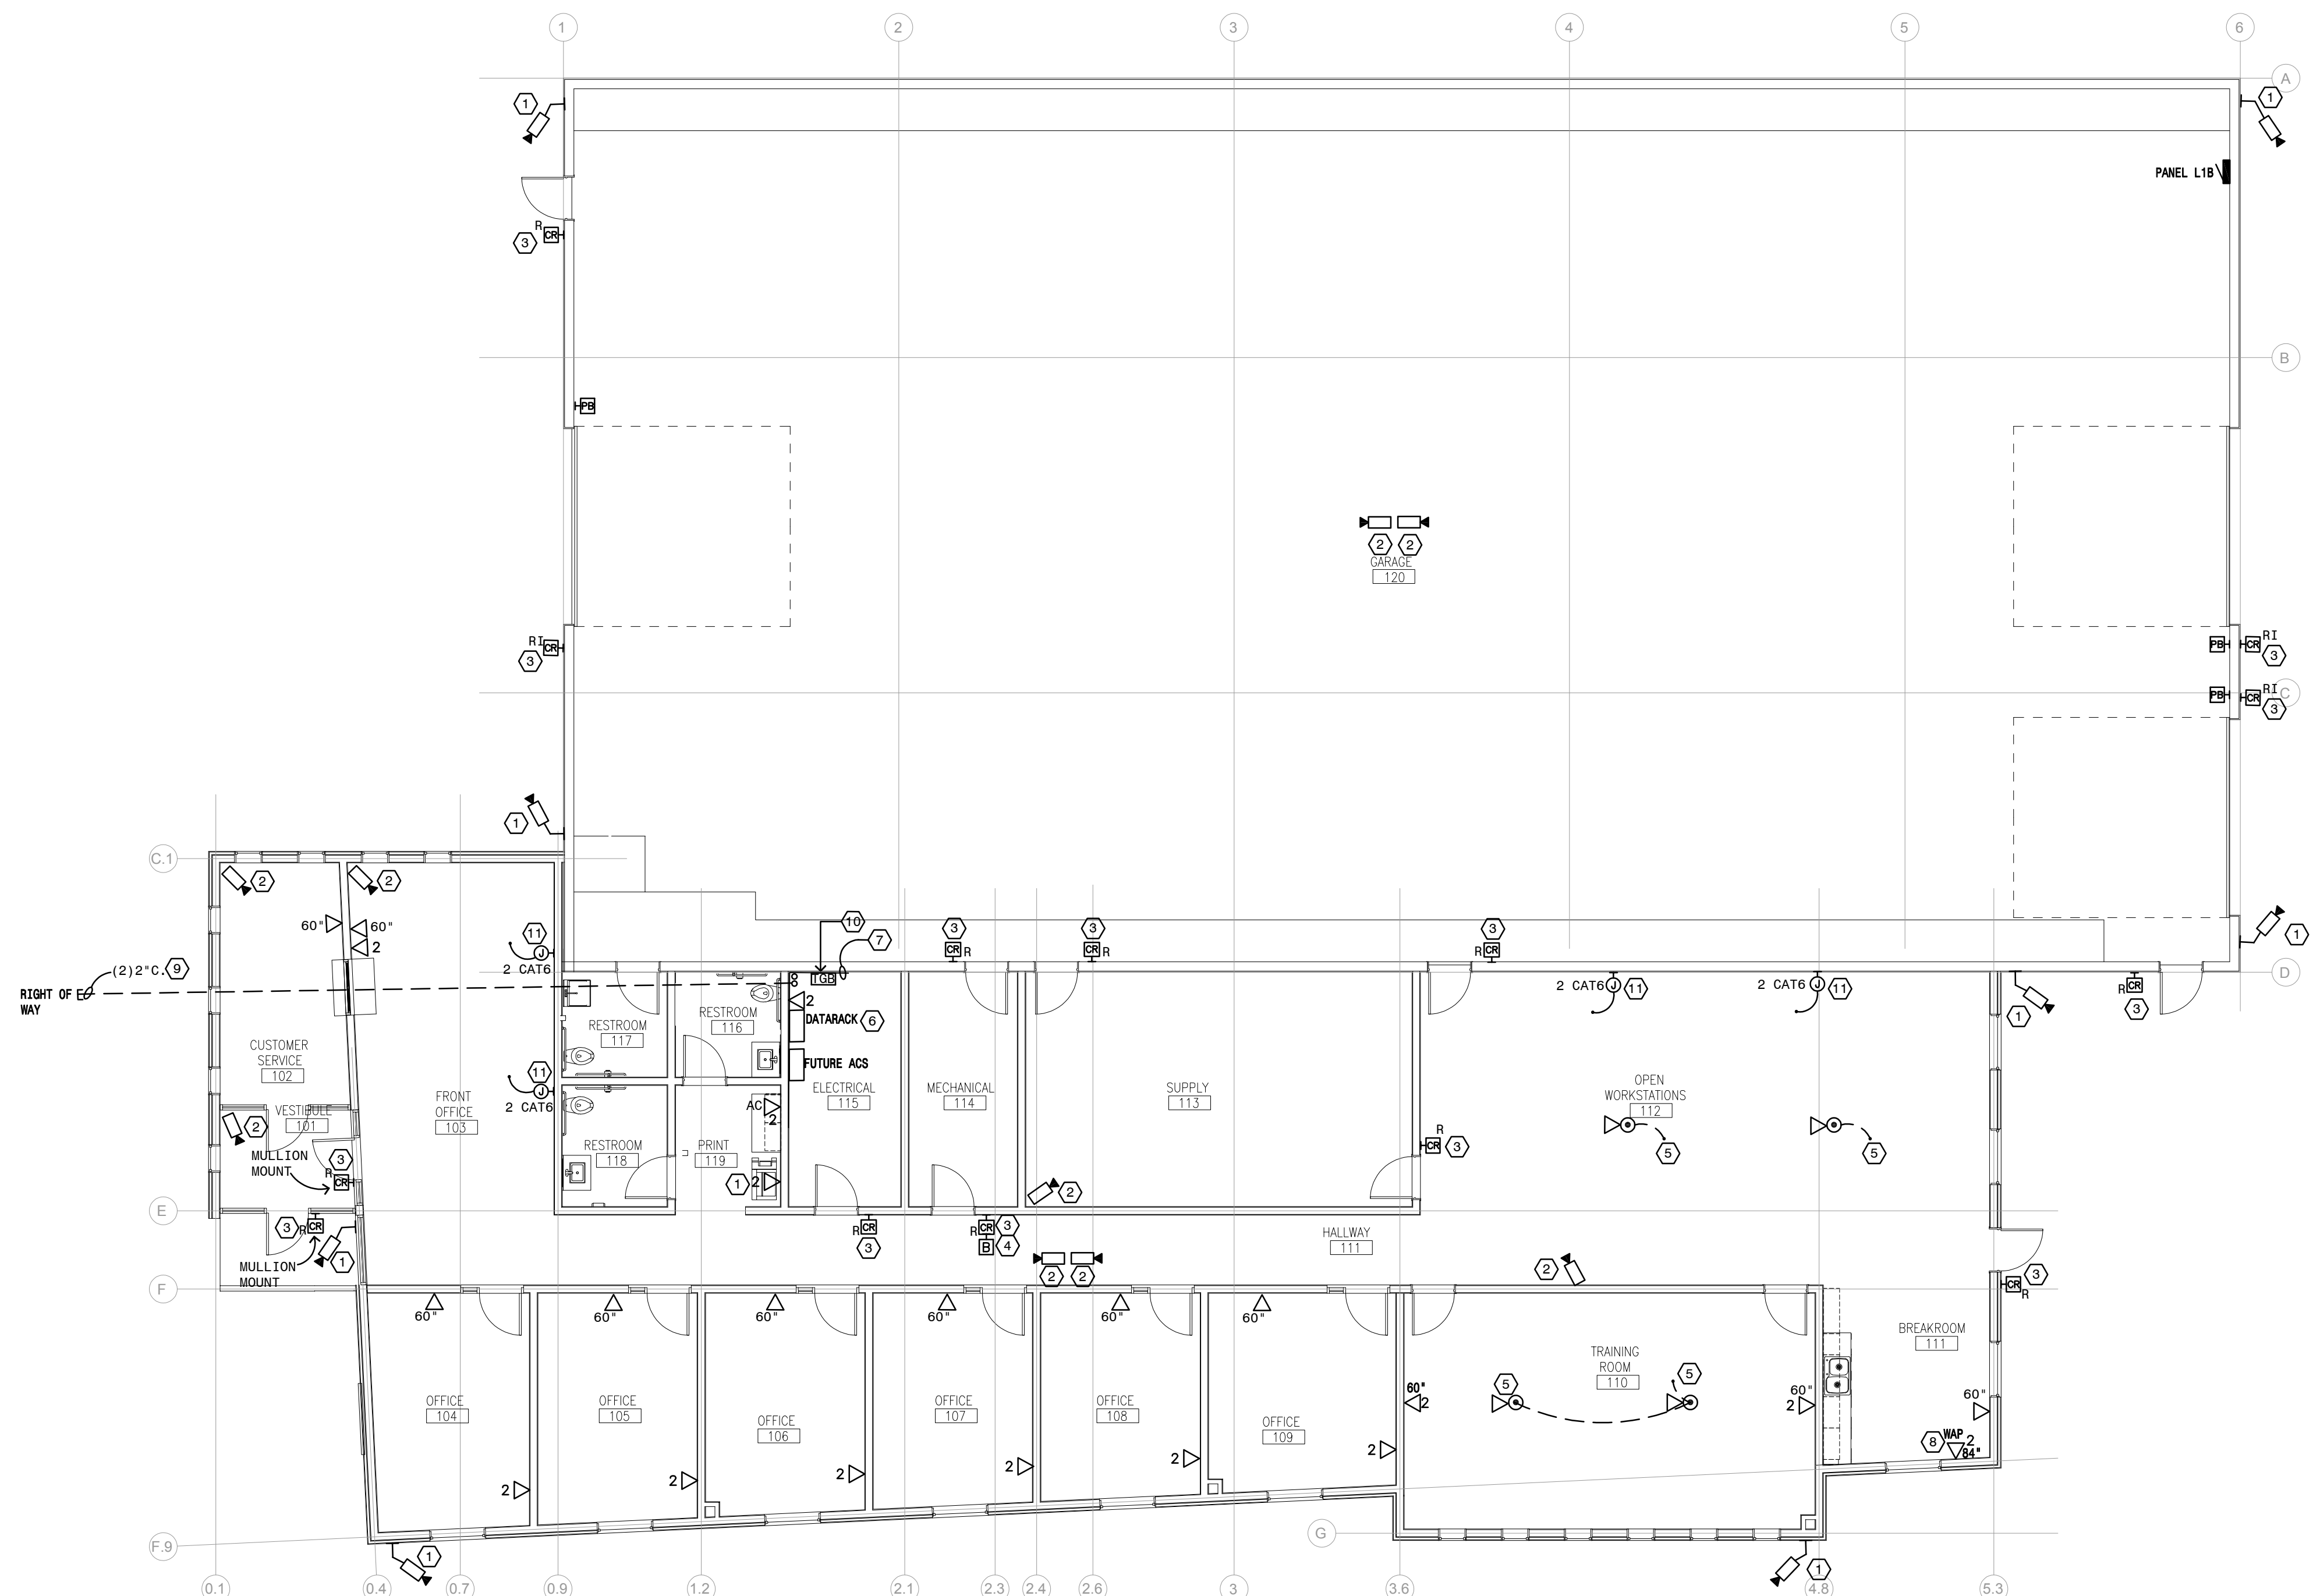

1 E400 FIRST FLOOR SYSTEMS PLAN - ELECTRICAL
1/8" = 1'-0"

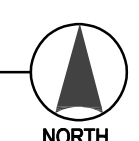



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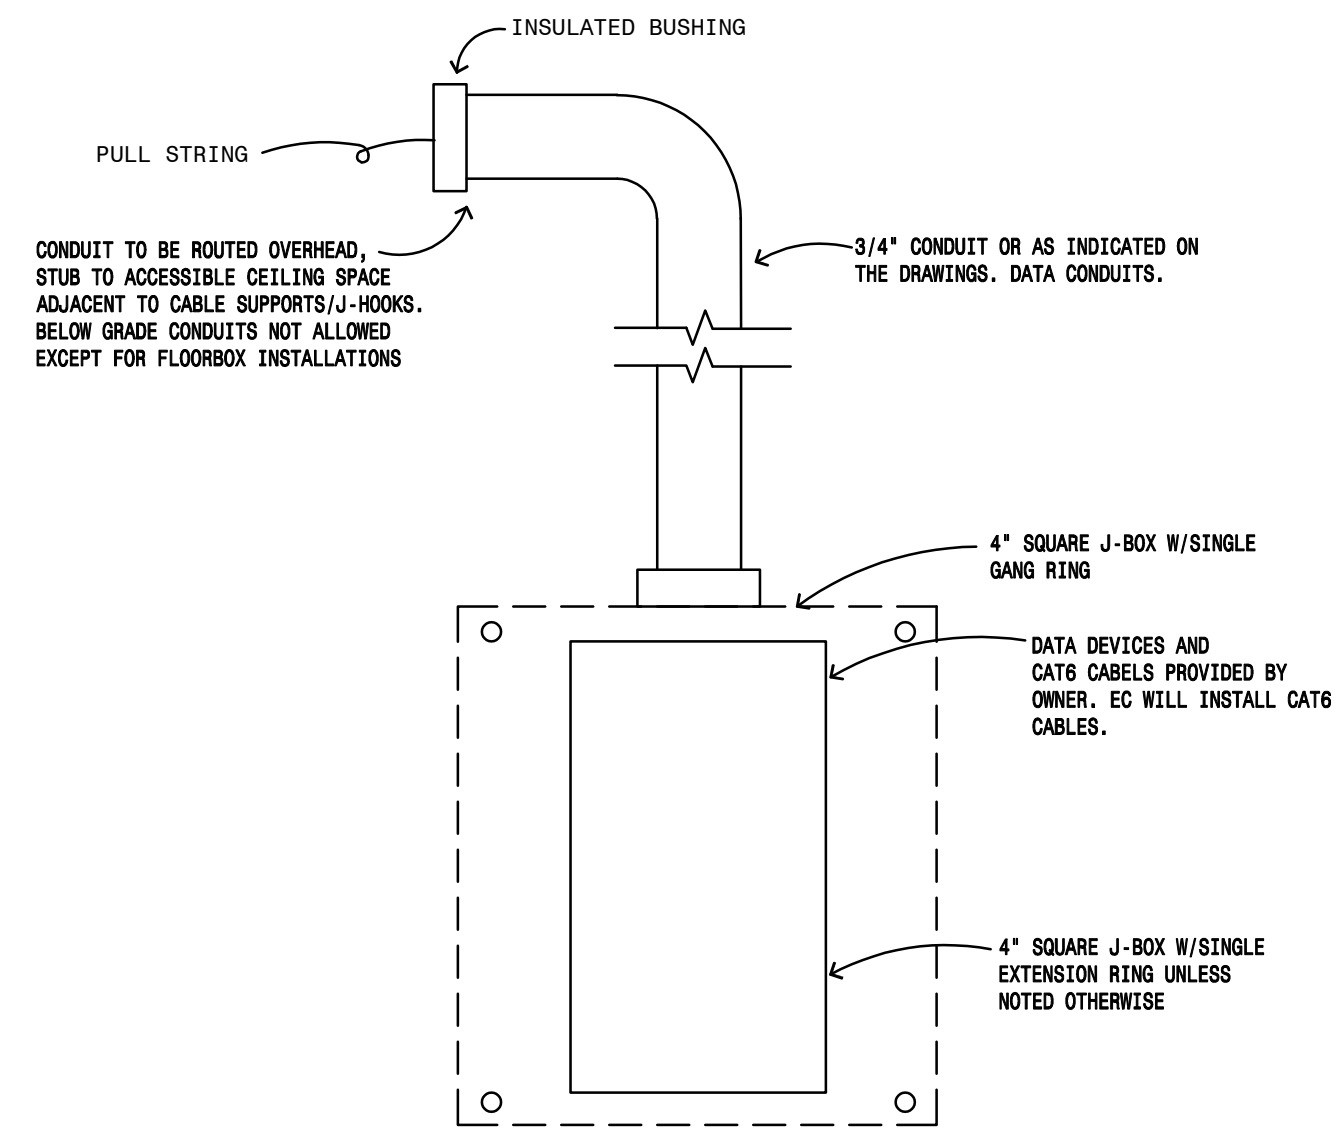
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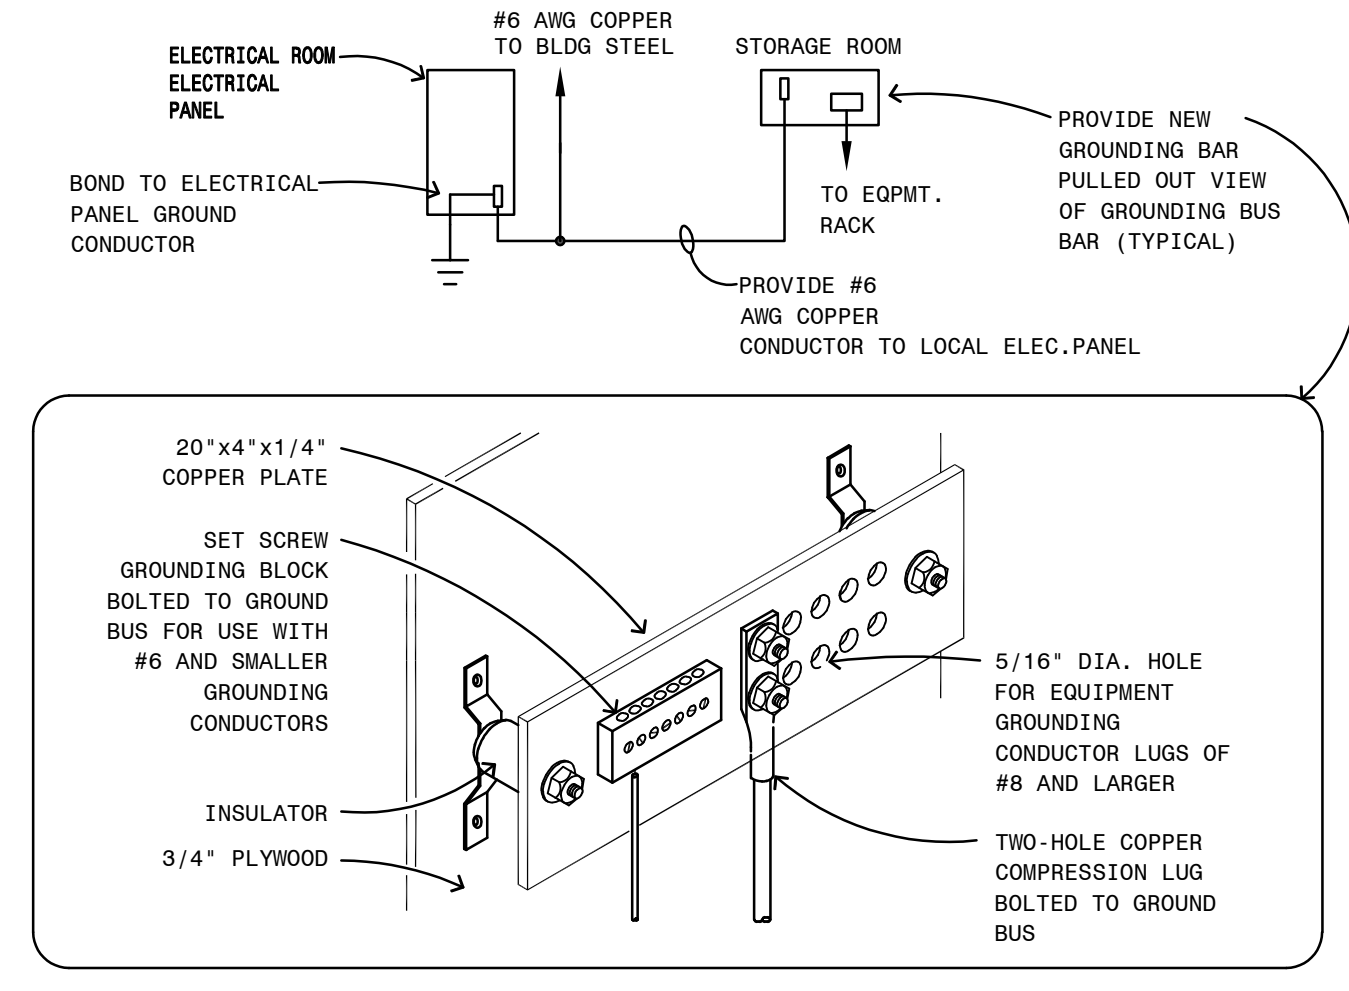
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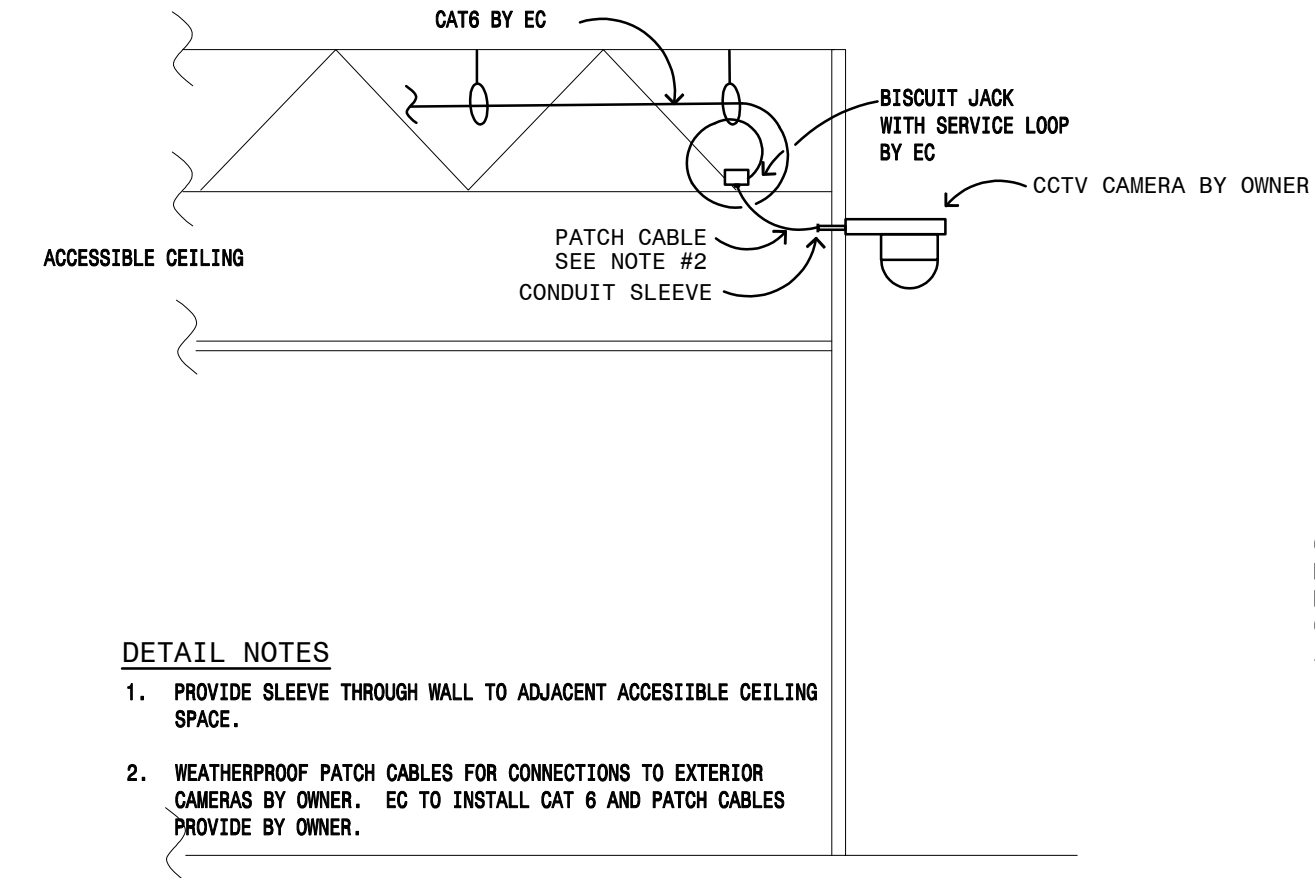
GENERAL NOTES:

- 'WAP' INDICATES A WIRELESS ACCESS POINT OUTLET WITH (2) CATEGORY 6 JACKS TYPICAL. EQUIPMENT FURNISHED AND INSTALLED BY THE OWNER. PROVIDE 20 FOOT SERVICE LOOP COILED IN AREAS WITH ACCESSIBLE CEILING AT ACCESS POINT LOCATIONS.
- CAT 6 CABLES PROVIDED BY OWNER AND INSTALLED BY EC. TESTING AND TERMINATIONS AT BOTH ENDS BY OWNER.




DETAIL NOTES:

- TELECOMMUNICATION CONTRACTOR SHALL BOND ALL METAL RACKS AND ENCLOSURES IN ALL TELECOMMUNICATIONS ROOMS TO THE GROUND BUS BAR WITH #6 AWG COPPER.
- BOND EACH TELECOM GROUNDING BUSBAR TO THE LOCAL ELECTRICAL PANEL IN THE IT SPACE, AND TO BUILDING STEEL WHERE AVAILABLE. DETAIL IS TYPICAL FOR ALL MDF/IDF ROOMS.



DETAIL NOTES:

- PROVIDE SLEEVE THROUGH WALL TO ADJACENT ACCESSIBLE CEILING SPACE.
- WEATHERPROOF PATCH CABLES FOR CONNECTIONS TO EXTERIOR CAMERAS BY OWNER. EC TO INSTALL CAT 6 AND PATCH CABLES PROVIDED BY OWNER.

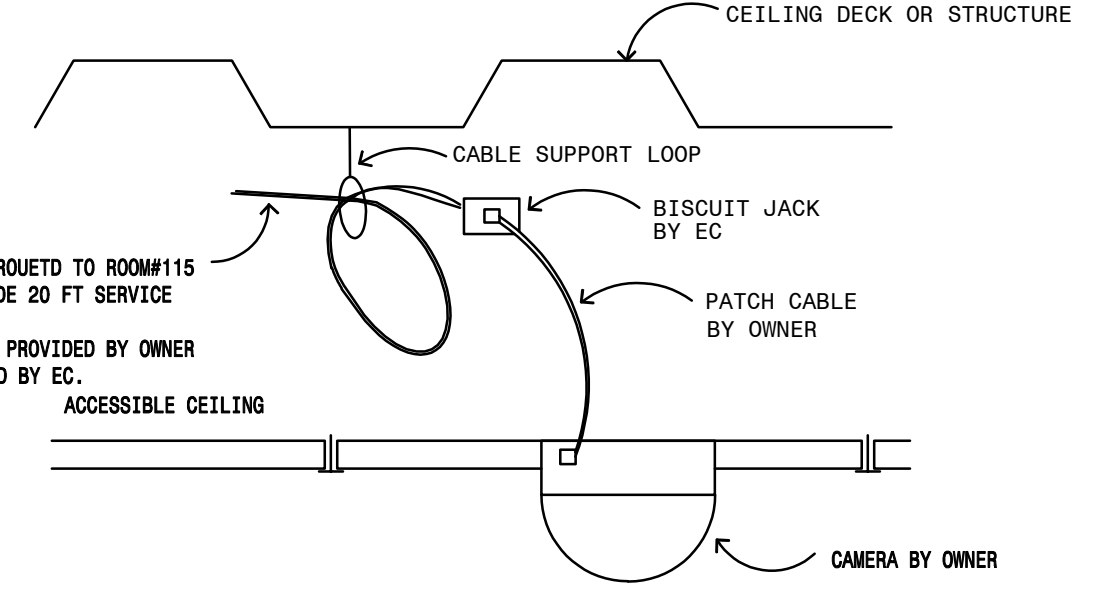


CATEGORY 6 ROUNDED TO ROOM#115 BY EC, PROVIDE 20 FT SERVICE LOOP. CAT 6 CABLES PROVIDED BY OWNER AND INSTALLED BY EC.

1 E500 TYPICAL DATA JACK ROUGH IN DETAIL
NOT TO SCALE

2 E500 TELECOMMUNICATIONS GROUNDING DETAIL
NOT TO SCALE

3 E500 TYPICAL EXTERIOR MOUNTED CAMERA DETAIL
NOT TO SCALE


4 E500 TYPICAL INTERIOR WALL/CEILING MOUNTED CAMERA DETAIL
NOT TO SCALE

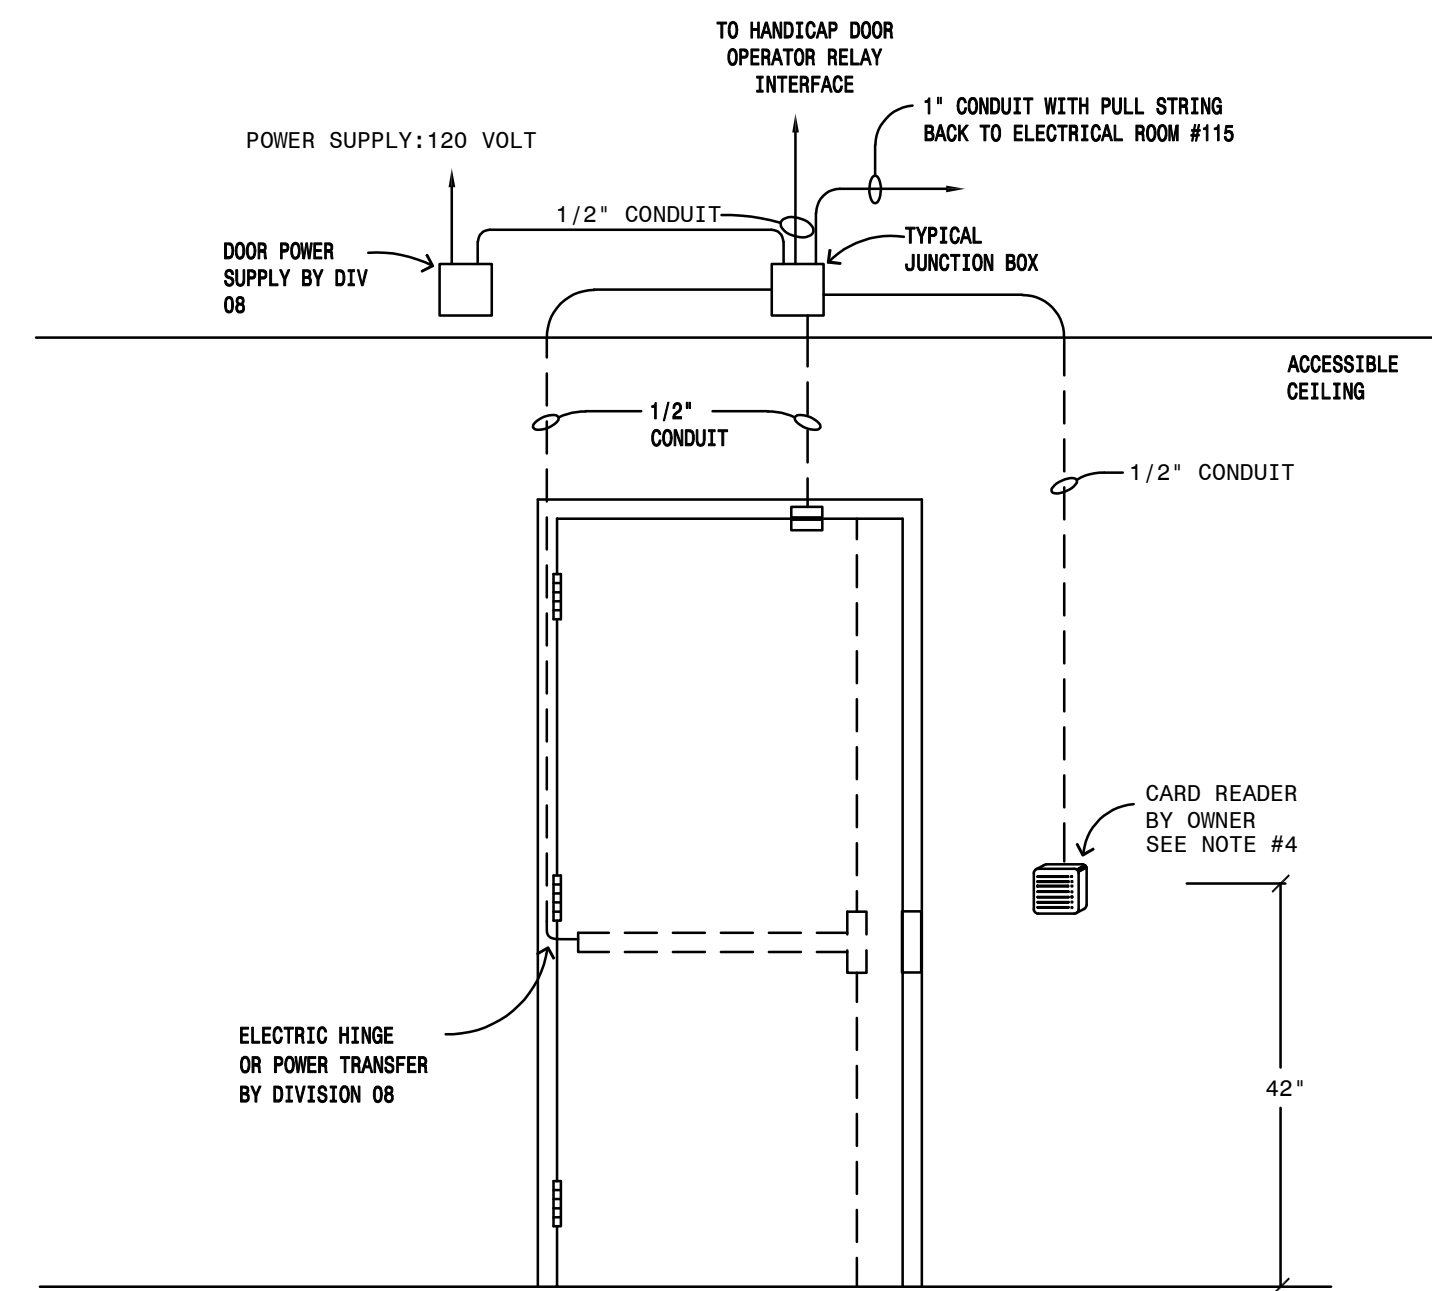

NOTES:

- ALL CONDUIT AT DOORS SHALL BE CONCEALED UNLESS NOTED OTHERWISE.
- THESE DETAILS SHOW A TYPICAL INSTALLATION, VERIFY EXACT WIRING REQUIREMENTS AND LOCKING MECHANISMS WITH DIVISION 08 AND THE OWNER'S CARD ACCESS SYSTEM MANUFACTURER PRIOR TO ROUGH IN.
- VERIFY EXIT HARDWARE ROUGH-IN WITH DOOR HARDWARE SUPPLIER.
- DIVISION 26 TO FURNISH ROUGH IN OF CONDUIT, BOXES, AND SHALL PROVIDE 120V CONNECTIONS TO DOOR HARDWARE POWER SUPPLIES AT EACH DOOR. WIRING AND FINAL CONNECTIONS TO CARD READER EQUIPMENT AND ELECTRIFIED DOOR LOCKS BY OWNER'S SECURITY INSTALLER. CARD READERS SUPPLIED AND INSTALLED BY OWNER.

5 E500 TYPICAL CARD ACCESS ROUGH IN DETAIL
NOT TO SCALE

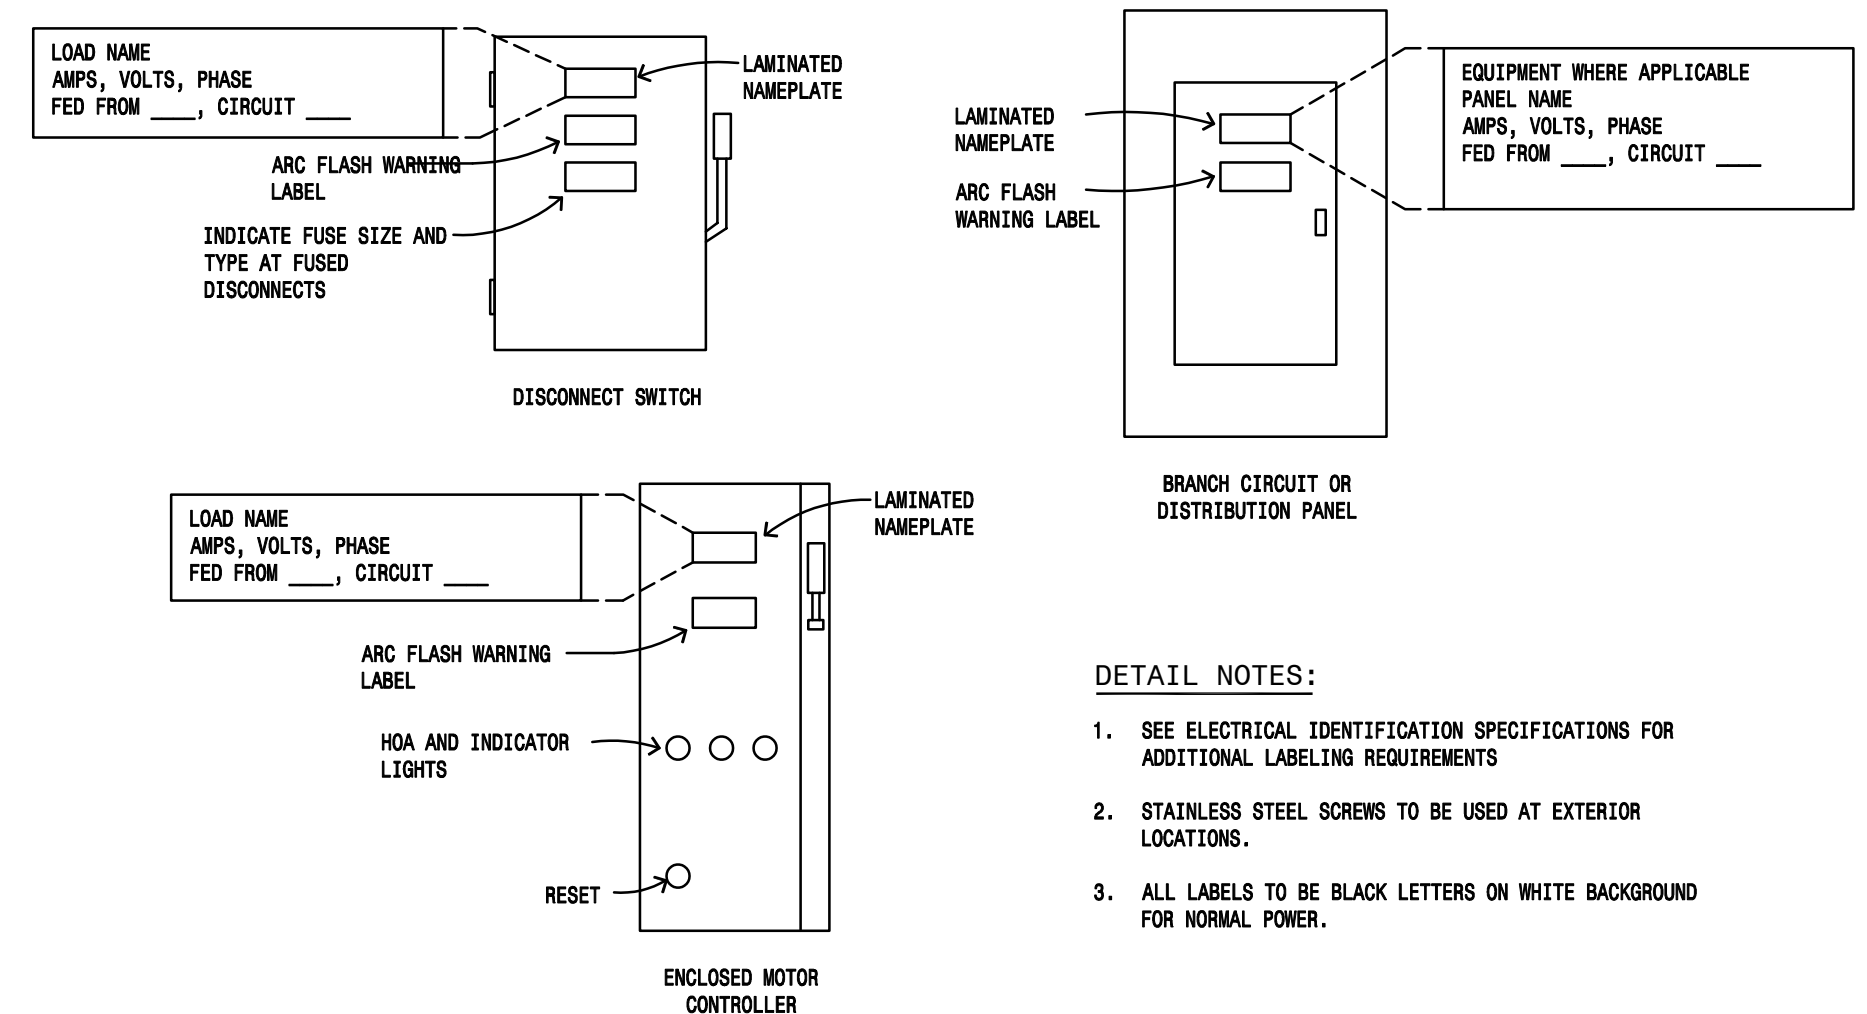

DETAIL NOTES:

- SEE ELECTRICAL IDENTIFICATION SPECIFICATIONS FOR ADDITIONAL LABELING REQUIREMENTS
- STAINLESS STEEL SCREWS TO BE USED AT EXTERIOR LOCATIONS.
- ALL LABELS TO BE BLACK LETTERS ON WHITE BACKGROUND FOR NORMAL POWER.

6 E500 ELECTRICAL EQUIPMENT NAMEPLATE DETAIL
NOT TO SCALE



DRAWING HISTORY

NO.	DESCRIPTION	DATE
1	DESIGN DOCUMENTS	01/15/25

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ELECTRICAL DETAILS

SHEET

E600